INDEX OF SHEETS DESCRIPTION SHEET NO. LAYOUT SHEET
TYPICAL SECTIONS AND DETAILS
LEGEND & UTILITY OWNERS
PLAN AND PROFILE SHEETS SHEETS NOT INCLUDED IN TOTAL SHEETS R2A - R2D


# Commonwealth of Kentucky DEPARTMENT OF HIGHWAYS

PLANS OF PROPOSED PROJECT

# BRACKEN COUNTY

KY 1159 - BROOKSVILLE TO AA HIGHWAY 012 1159 000-005

RIGHT OF WAY PLANS

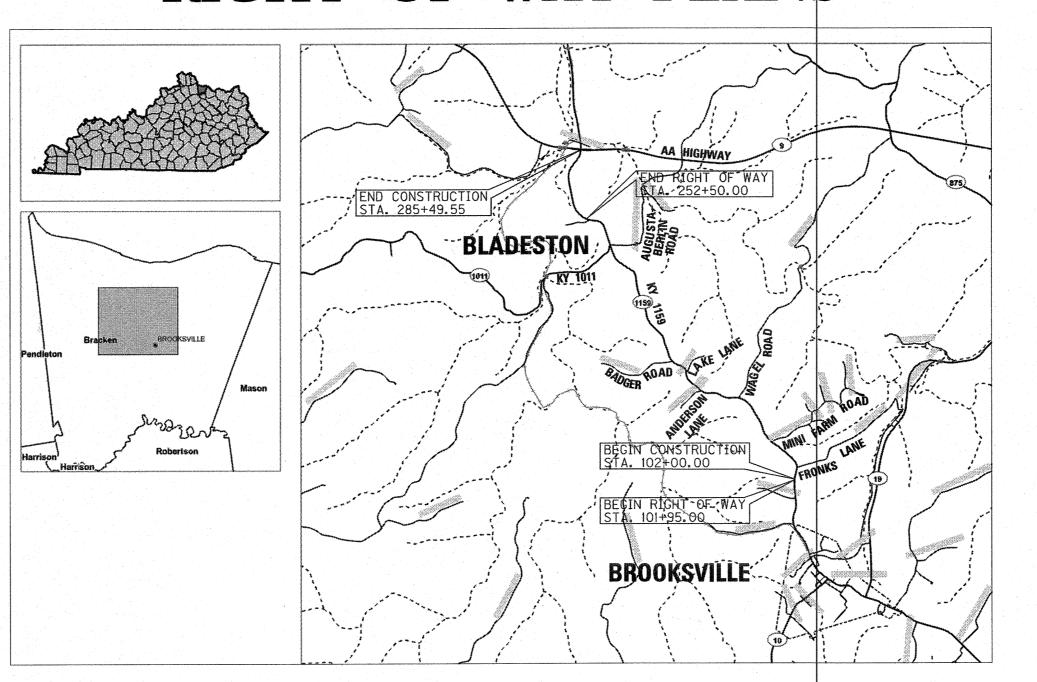

LAYOUT MAP

RIGHT OF WAY **PLANS** 



6-8311.00

BRACKEN

### **DESIGN CRITERIA**

CLASS OF HIGHWAY RURAL MAJOR COLLECTOR TYPE OF TERRAIN ROLLING 35 MPH (URBAN); 50 MPH (RURAL) DESIGN SPEED 35 - 250'; 50 - 425' REQUIRED NPSD 35 - 1280'; 50 - 1835' REQUIRED PSD LEVEL OF SERVICE C ADT PRESENT ( 2011 ) 1900 - 2400 ADT FUTURE ( 2045 ) 3700 - 4700 DHV 400 - 500 D % 50 - 50 T % 6.5

### GEOGRAPHIC COORDINATES

LATITUDE 38 DEGREES 42 MINUTES 17 SECONDS NORTH LONGITUDE 84 DEGREES 05 MINUTES 02 SECONDS WEST

### **DESIGNED**

% RESTRICTED SD LEVEL OF SERVICE MAX. DISTANCE W/O PASSING

APPROACH ROADS KY 1159 LENGTH 18,349.55 LIN. FT. 3.475 MILES LENGTH 2,012.55 LIN. FT. 0.381 MILES LENGTH LIN. FT. \_\_\_\_\_\_ ADDED FOR EQUALITIES \_\_\_\_\_LIN. FT. ADDED FOR EQUALITIES \_\_\_\_\_ \_\_LIN. FT. ADDED FOR EQUALITIES \_\_\_\_ \_LIN. FT. ADDED FOR EQUALITIES \_LIN. FT NOT INCLUDED NOT INCLUDED NOT INCLUDED \_\_LIN. FT. RAILROAD CROSSINGS NO. \_ \_\_LIN. F \_LIN. FT. RAILROAD CROSSINGS NO. \_\_\_\_ AILROAD CROSSINGS NO. \_\_\_\_\_ \_\_LIN. F

### Commonwealth of Kentucky DEPARTMENT OF HIGHWAYS COUNTY OF

### **BRACKEN**

ITEM NO. 6-8311.00

PROJECT NUMBER: KY 1159 RECONSTRUCTION 012 1159 000-005

LETTING DATE:

STATE HIGHWAY ENGINEER

PLAN APPROVED BY: \_\_\_\_


MARCH 25, 2014


**PARSONS** BRINCKERHOFF Parsons Brinckerhoff, Inc. 1792 Alysheba Way, Suite 230 Lexington, KY 40509 (859) 272-5400



# TYPICAL SECTIONS


SHEET NO. ITEM NO. R2 BRACKEN 6-8311.00

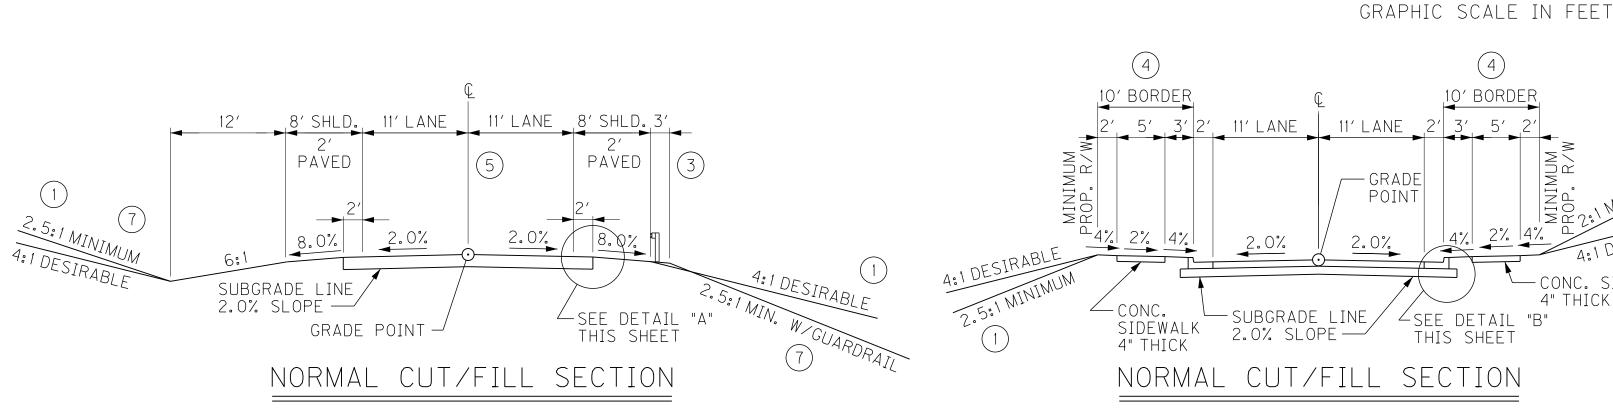

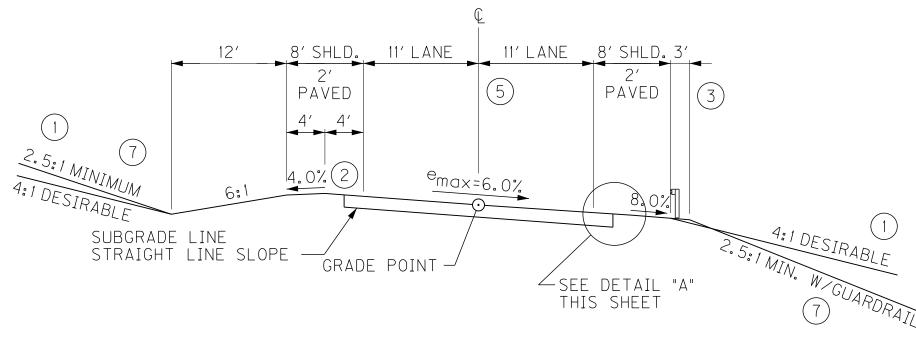


SUPERELEVATED CUT/FILL SECTION

**KY 1159 – RURAL** 

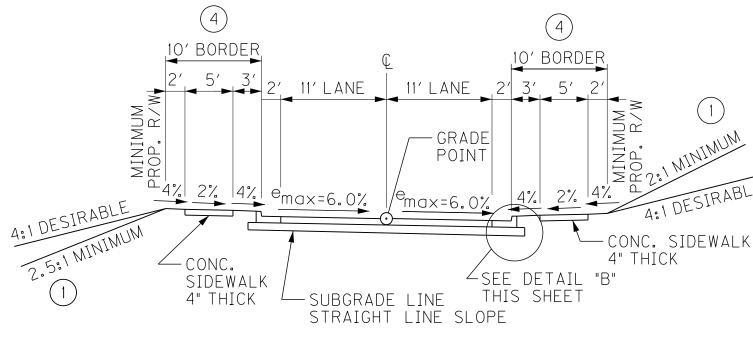


SUPERELEVATED CUT/FILL SECTION

**KY 1159 – URBAN** LT. STA. 102 + 00 TO LT. STA. 106 + 13 RT. STA. 102 + 00 TO RT. STA. 107 + 65

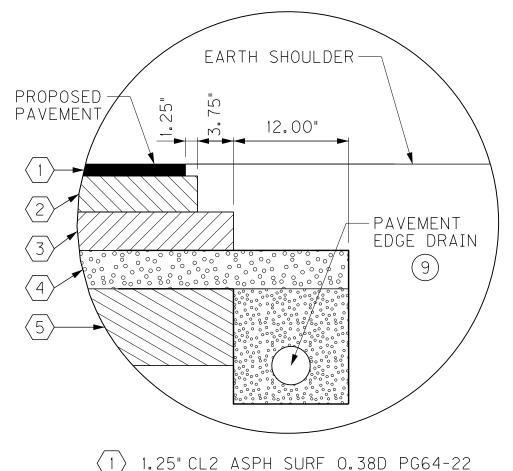

- (1) 1.25" CL2 ASPH SURF 0.38D PG64-22
- 3.75" CL2 ASPH BASE 1.00D PG64-22  $\langle 3 \rangle$  4.00" CL2 ASPH BASE 1.00D PG64-22
- 4 4.00" CRUSHED STONE BASE
- (5) 8.00" LIME STABILIZED ROADBED (8)

DETAIL "A" **KY 1159 – RURAL** NOT TO SCALE

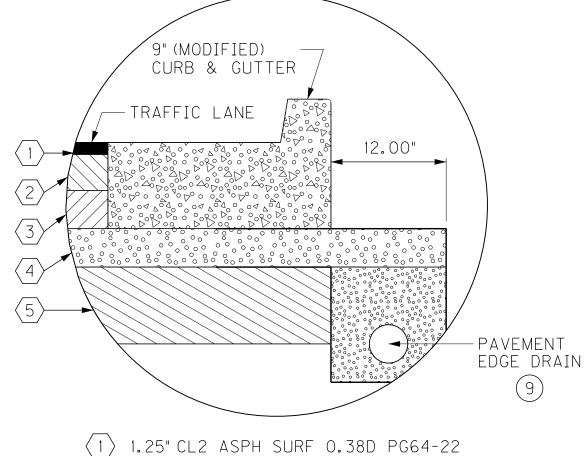


- $\langle 2 \rangle$  3.75" CL2 ASPH BASE 1.00D PG64-22
- 4.00" CL2 ASPH BASE 1.00D PG64-22
- $\langle 4 \rangle$  4.00" CRUSHED STONE BASE
- (5) 8.00" LIME STABILIZED ROADBED (8)


DETAIL "B" **KY 1159 – URBAN** NOT TO SCALE

#### NOTES

- 1) SEE CROSS SECTIONS FOR SLOPES OUTSIDE THE LIMITS OF THE SHOULDERS.
- 2 SUPERELEVATED SHOULDER TO BE CONSTRUCTED TO SUPERELEVATION RATE. AT NO TIME WILL THE SLOPE BE FLATTER THAN THE SLOPE INDICATED FOR THE NORMAL
- 3 SHOULDERS SHALL BE WIDENED 3 FEET WHERE GUARDRAIL IS TO BE INSTALLED.
- 4 BORDER AREA IS TO BE SODDED BETWEEN CURB AND SIDEWALK AND 2 FEET BEHIND SIDEWALK.
- (5) 12' WIDE LEFT TURN LANE PROVIDED FOR BLADESTON.
- (6) EXISTING SHOULDER PAVEMENT IS TO BE REMOVED.
- 7 SEE CROSS SECTIONS FOR SELECT LOCATIONS WHERE 2:1 SLOPES ARE ALLOWED.
- (8) 6% BY DRY MASS DENSITY 102 LBS. / CU. FT.
- (9) SEE SHEET R2B FOR PAVEMENT EDGE DRAIN DETAIL.
- (10) ALL ASPHALT OVERLAYS TO BE 1.25" CL2 ASPH SURF 0.38D PG64-22. SEE PLANS FOR ALL LOCATIONS.

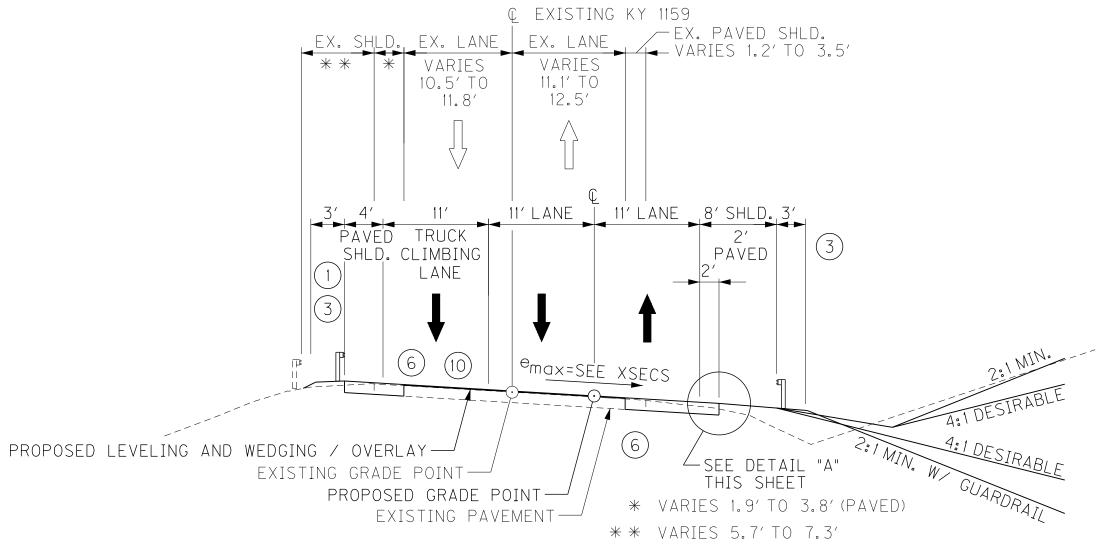

SUPERELEVATED CUT/FILL SECTION

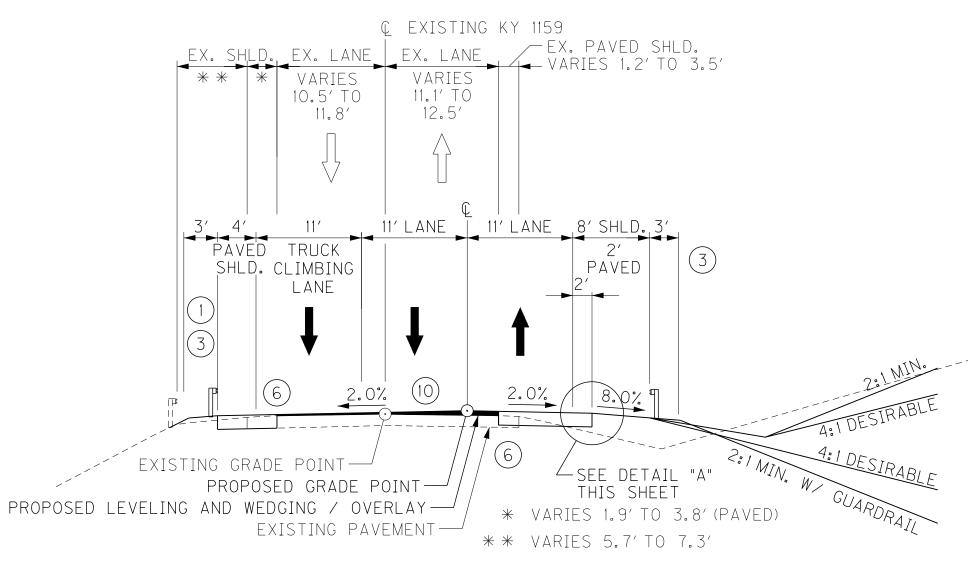


NORMAL CUT/FILL SECTION


**KY 1159 – TRUCK CLIMBING LANE** (SOUTH OF AA HIGHWAY)


RIGHT OF WAY **PLANS** 

KY 1159 RECONSTRUCTION TYPICAL SECTIONS KY 1159

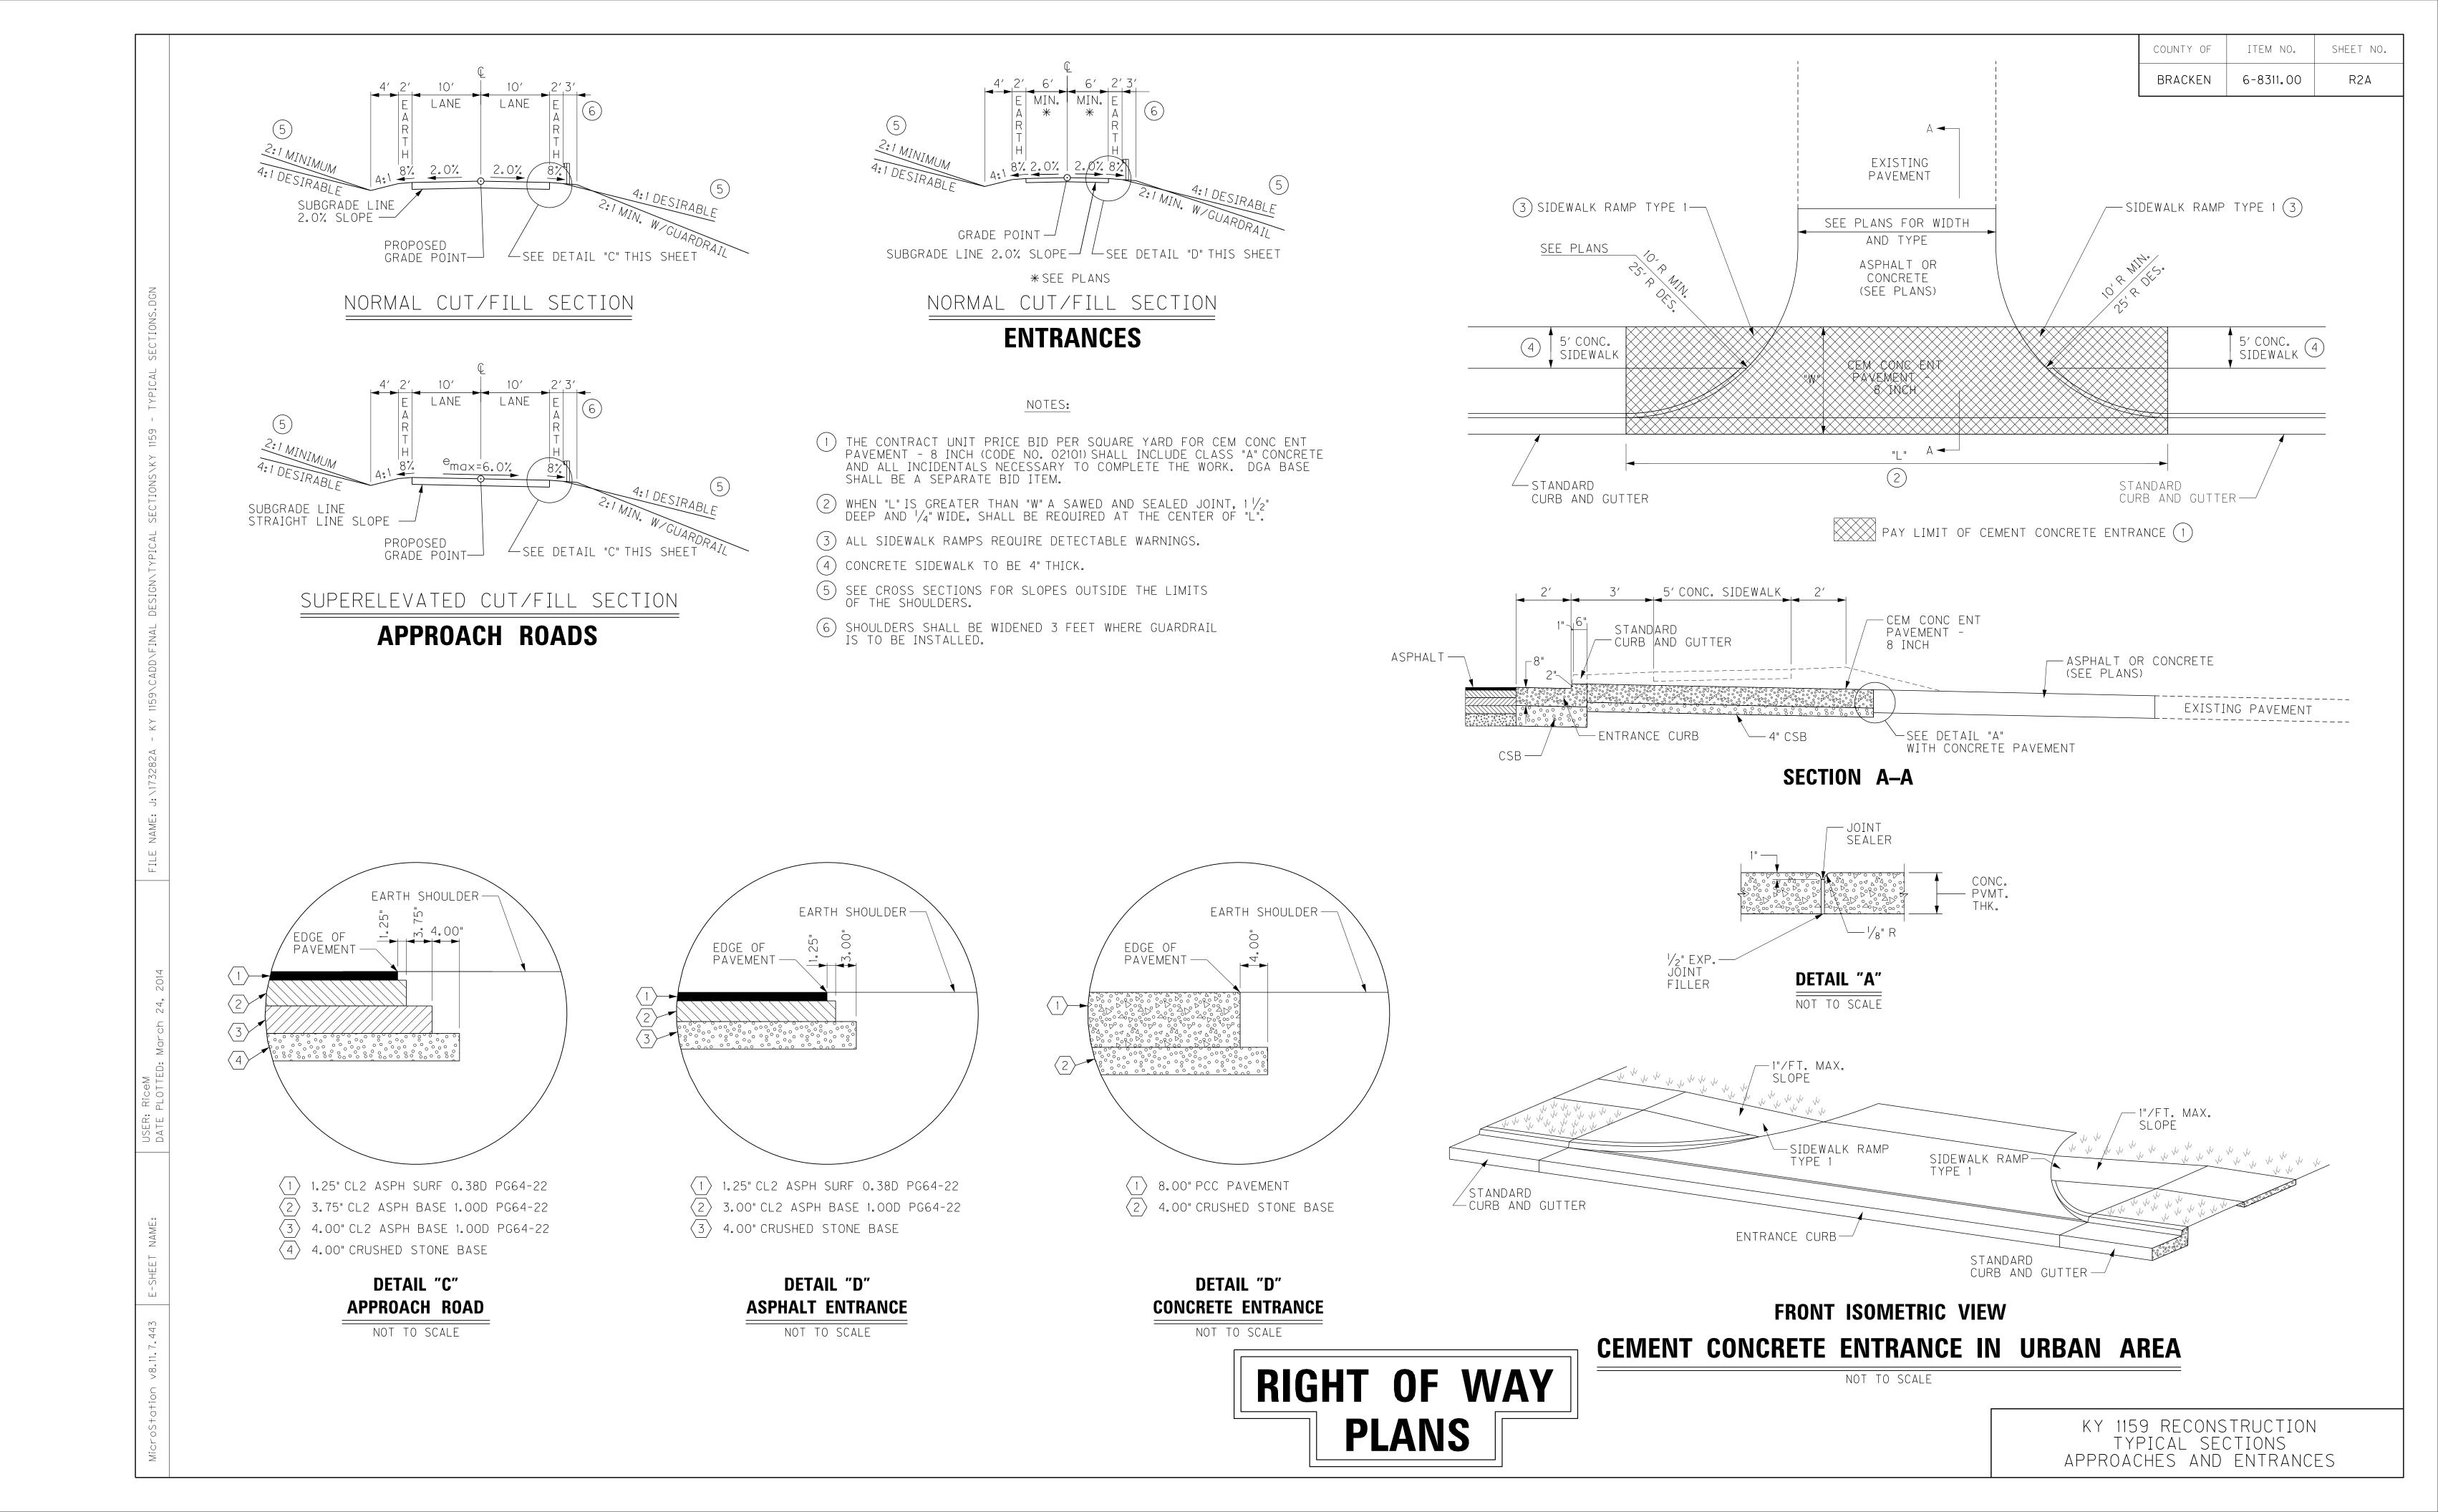

# PAVEMENT EDGE DRAIN DETAILS

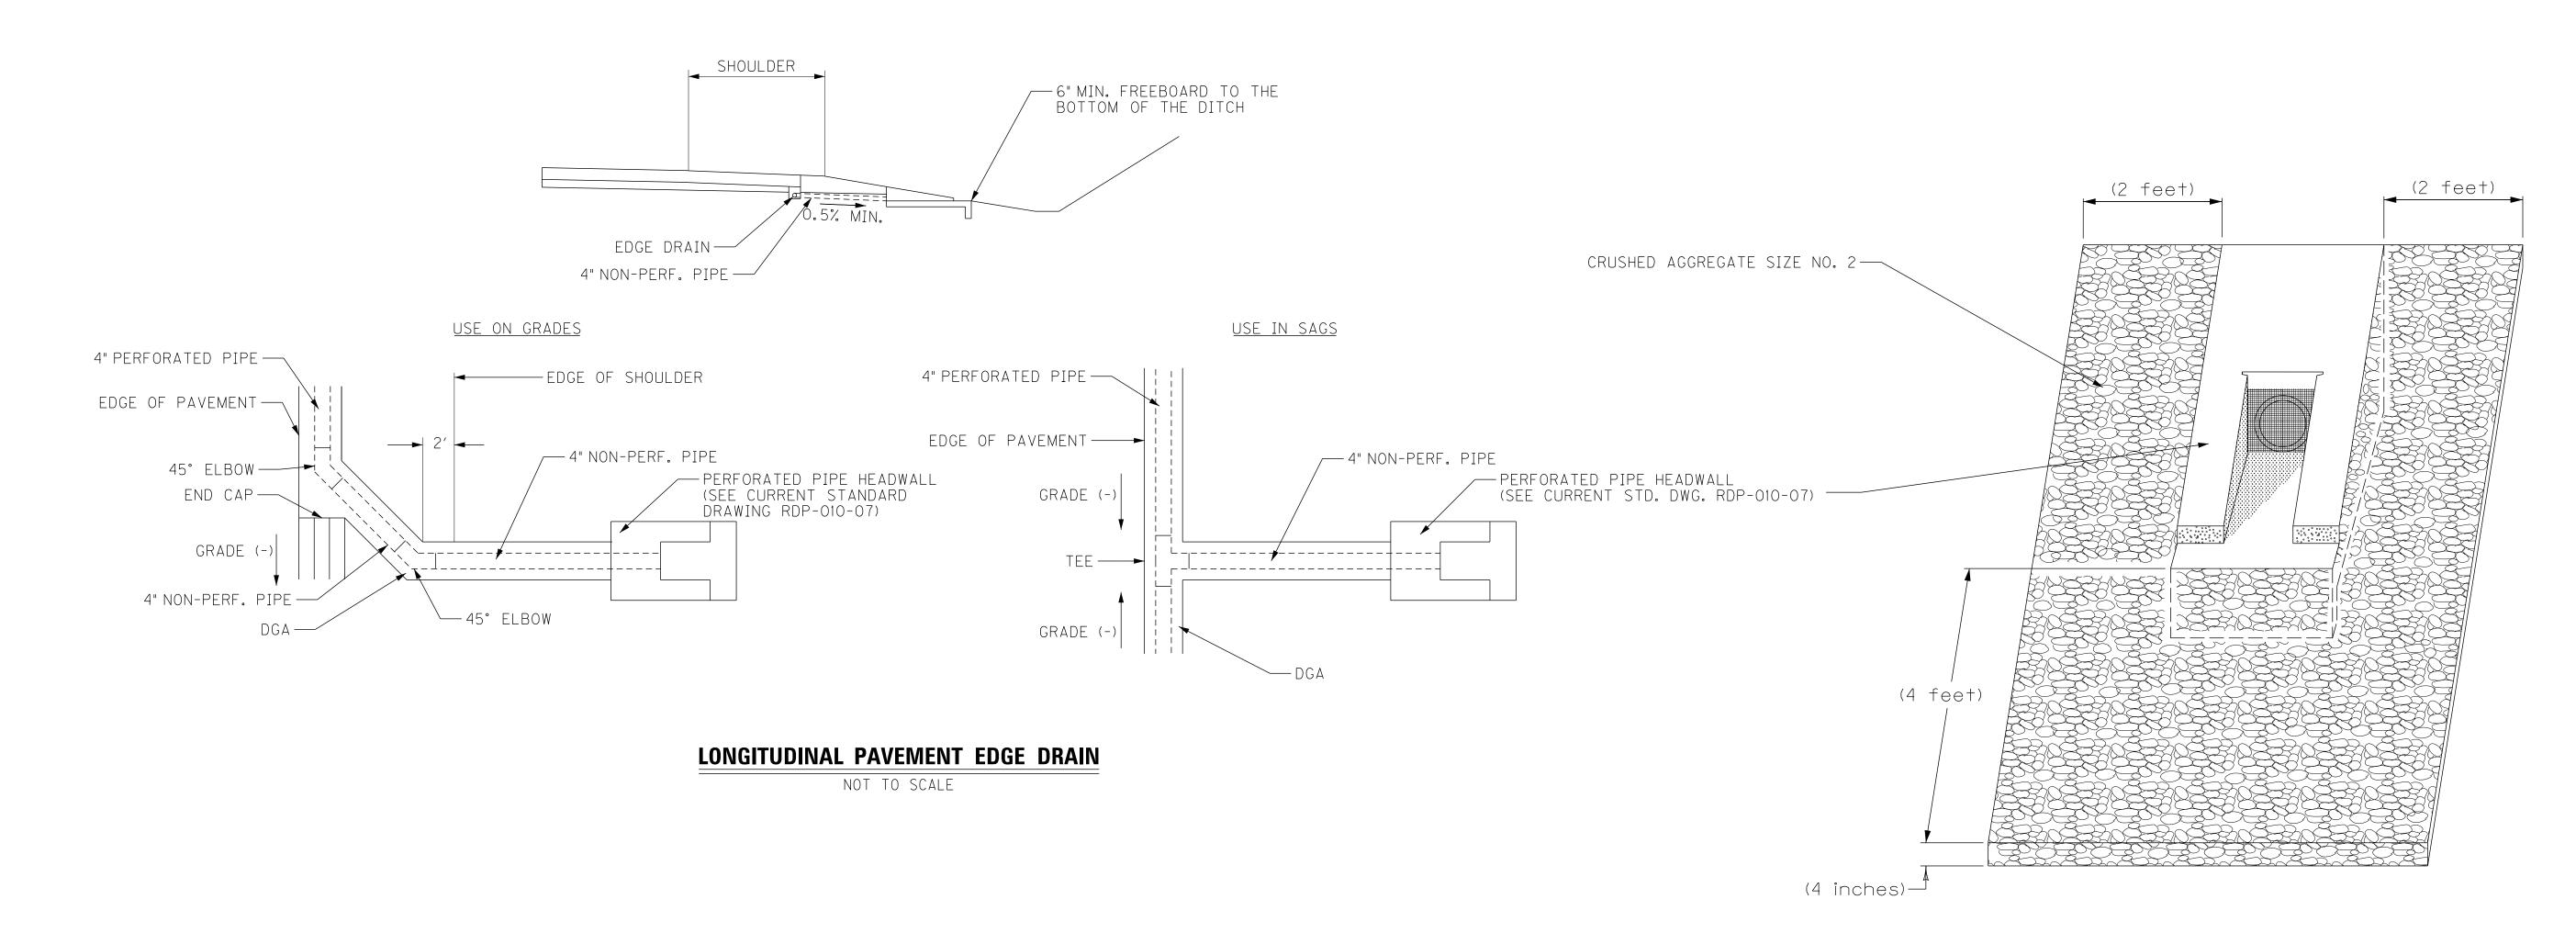

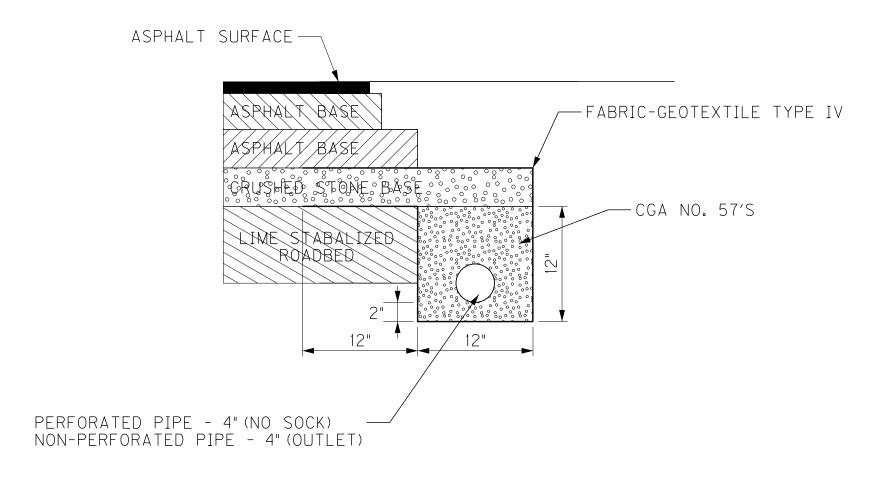

## PAVEMENT EDGE DRAIN

NOT TO SCALE

### PERFORATED PIPE HEADWALL OUTLET

NOT TO SCALE

SPECIAL NOTE FOR PAVEMENT SUBSURFACE DRAINAGE OUTLET

Use approximately one ton of Crushed Aggregate Size No. 2 at all Perforated Pipe Headwall Outlets as illustrated in the detail above. Place Crushed Aggregate Size No. 2 to a minimum depth of 4" as detailed above.

Use Dense Graded Aggregate Base (DGA) removed during placement of the Crushed Aggregate Size No. 2 to dress existing shoulders where DGA is exposed. Waste other materials removed during placement of the Crushed Aggregate Size No. 2 as directed by the Engineer. The Department will make no direct payment for disposal of wasted material.

The Department will consider payment for Crushed Aggregate Size No. 2 as full compensation for all materials, labor, and other incidentals necessary to place Crushed Aggregate Size No. 2 for vegetation control and/or erosion control at perforated pipe headwall outlets.

SEE CURRENT STANDARD DRAWING RDP-010-08 FOR DIMENSIONS AND OTHER DETAILS.



KY 1159 RECONSTRUCTION PAVEMENT EDGE DRAIN DETAILS

ENTRANCE WIDTH
12' (TYP.) CONCRETE APRON — (SEE STD. DRAWING RDI-200-04 FLUSH MEDIAN SECTION) ENTRANCE PIPE ENTRANCE PIPE SLOTTED DRAIN TYPICAL SLOTTED DRAIN ENTRANCE PIPE PLAN VIEW 12' 15" SLOTTED DRAIN PIPE / 12' SLOTTED DRAIN PIPE RISER PROPOSED —
DITCH PROPOSED — DITCH So= 0.0139 FT/FT → 15" ENTRANCE PIPE 15" ENTRANCE PIPE TYPICAL SLOTTED DRAIN ENTRANCE PIPE SECTION SECTION SHOWN ALONG Q OF DITCH AND PIPE

ITEM NO. SHEET NO. 6-8311.00 R2C BRACKEN

NOTES


1) CONCRETE APRON SHALL BE INCIDENTAL TO SLOTTED DRAIN PIPE CONSTRUCTION

2. SLOTTED DRAIN ENTRANCE PIPE LOCATIONS:
-ENTRANCE LT. STA. 127+00
-ENTRANCE RT. STA. 145+25
-ENTRANCE LT. STA. 167+16
-ENTRANCE LT. STA. 167+76
-ENTRANCE RT. STA. 190+11
-ENTRANCE RT. STA. 248+82
-ENTRANCE RT. STA. 249+39

RIGHT OF WAY **PLANS** 

SCALE: 1"=5'

KY 1159 RECONSTRUCTION SLOTTED DRAIN ENTRANCE PIPE PLAN AND TYPICAL SECTIONS

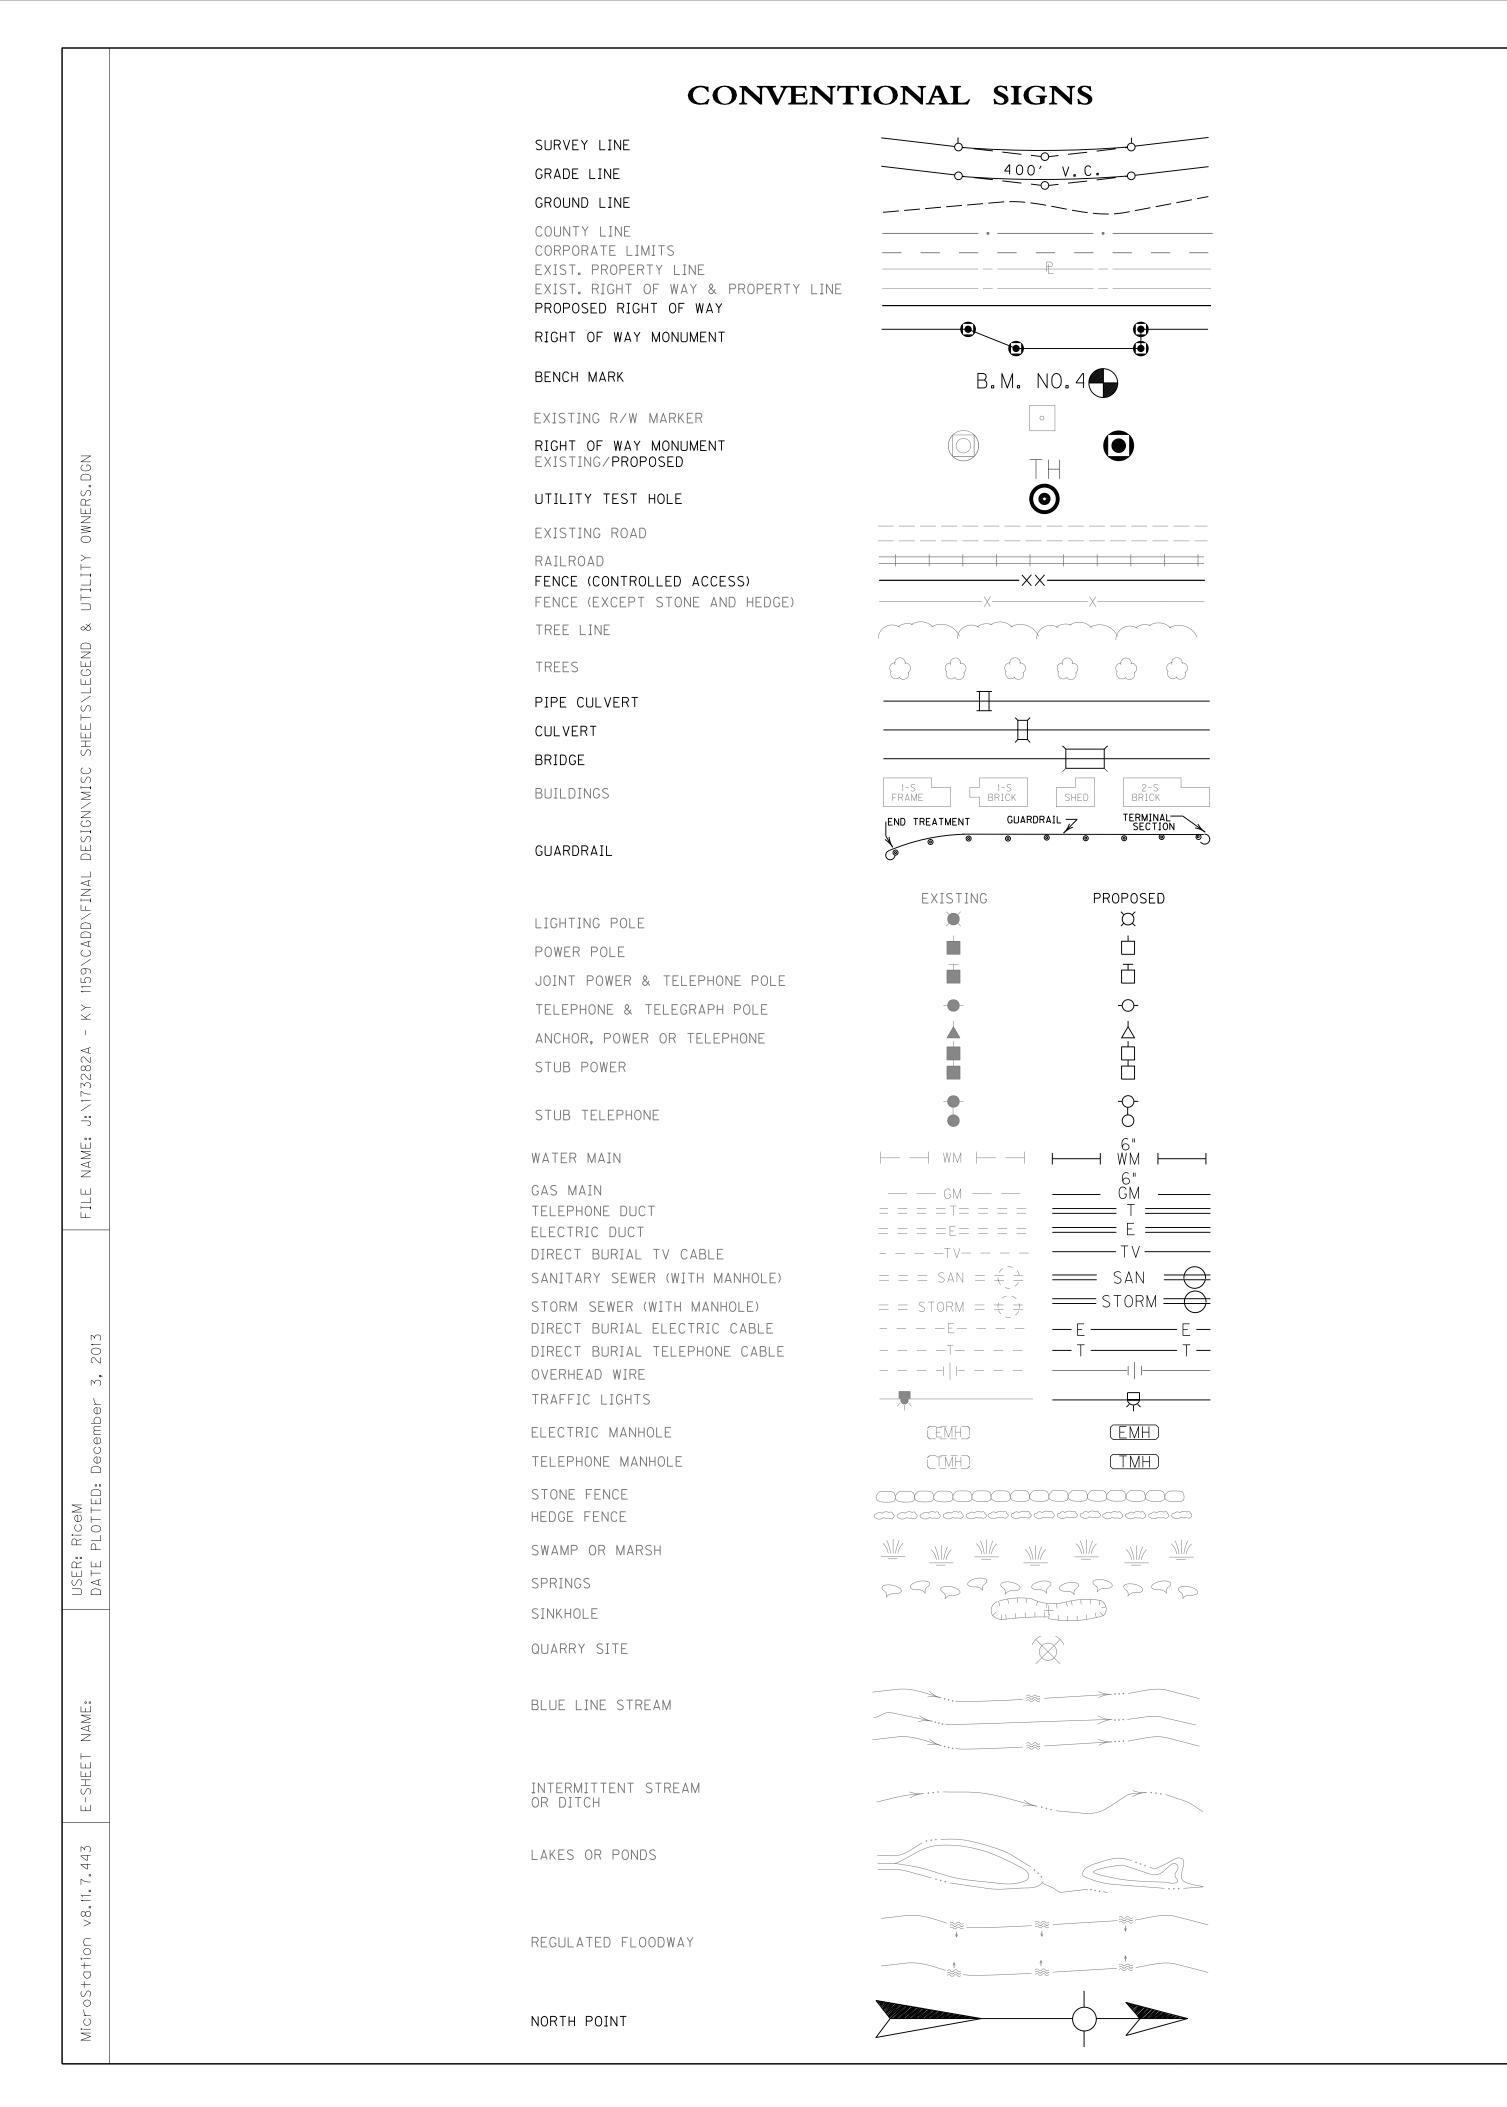

#### **UTILITY OWNERS**

COUNTY OF ITEM NO. SHEET NO.

BRACKEN 6-8311.00 R2D

<u>ELECTRIC</u> BLUEGRASS ENERGY (859) 885-2114 KENTUCKY UTILITIES (859) 987-0325

TELEPHONE

WINDSTREAM (606) 845-4741

WATER

CITY OF BROOKSVILLE (606) 735-2619
BRACKEN COUNTY WATER DISTRICT (606) 735-3513

<u>GAS</u>

COLUMBIA GAS OF KENTUCKY (859) 288-0225 CITY OF BROOKSVILLE (606) 735-2619

<u>cable tv</u>

BRACKEN CABLEVISION (606) 564-9220

SANITARY SEWERS

CITY OF BROOKSVILLE (606) 735-2619


### — — BEFOR<u>E YO</u>U DIG — — —


The contractor is instructed to call 1-800-752-6007 to reach KY 811, the one-call system for information on the location of existing underground utilities. The call is to be placed a minimum of two (2) and no more than ten (10) business days prior to excavation. The contractor should be aware that owners of underground facilities are not required to be members of the KY 811 one-call Before-U-Dig (BUD) service. The contractor must coordinate excavation with the utility owners, including those whom do not subscribe to KY 811. It may be necessary for the contractor to contact the County Court Clerk to determine what utility companies have facilities in the area.


### NOTE:


ALL MAPPING, SURVEY DATA, UTILITY LOCATIONS, EXISTING RIGHT OF WAY, EXISTING EASEMENTS, PROPERTY LINES, AND PROPERTY OWNERSHIP DATA WAS PROVIDED BY THE KENTUCKY TRANSPORTATION CABINET.


RIGHT OF WAY
PLANS

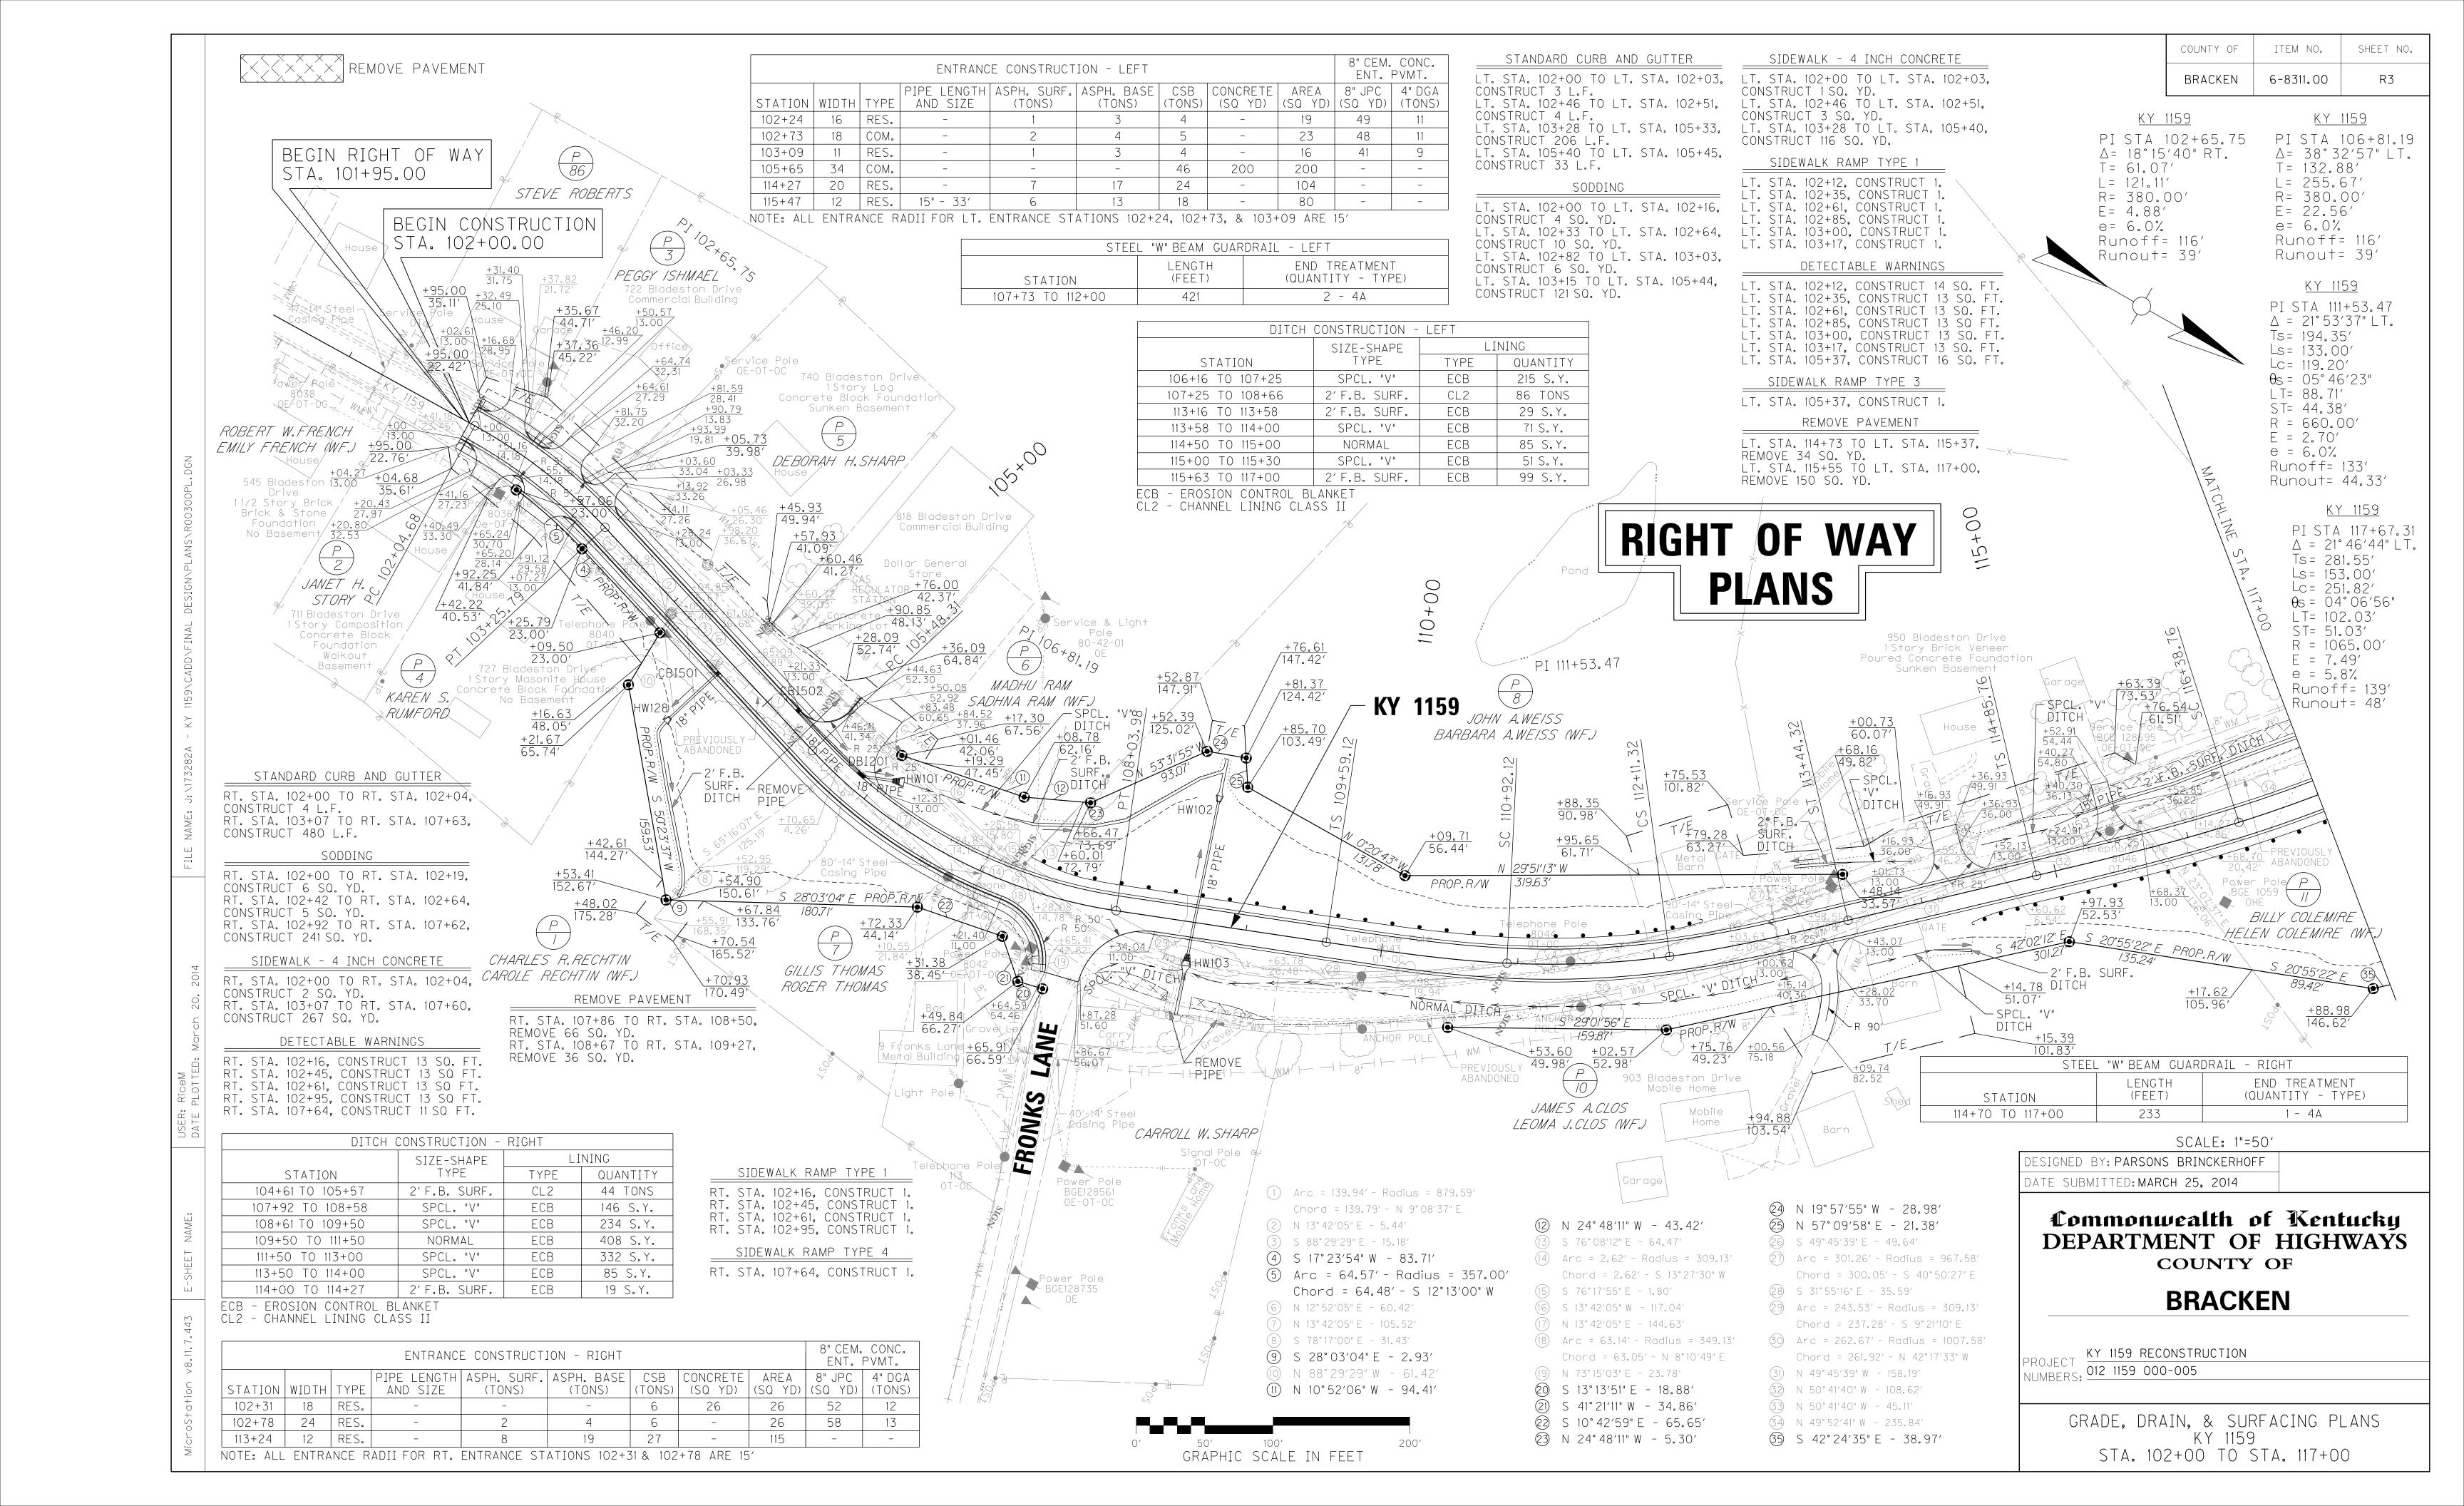


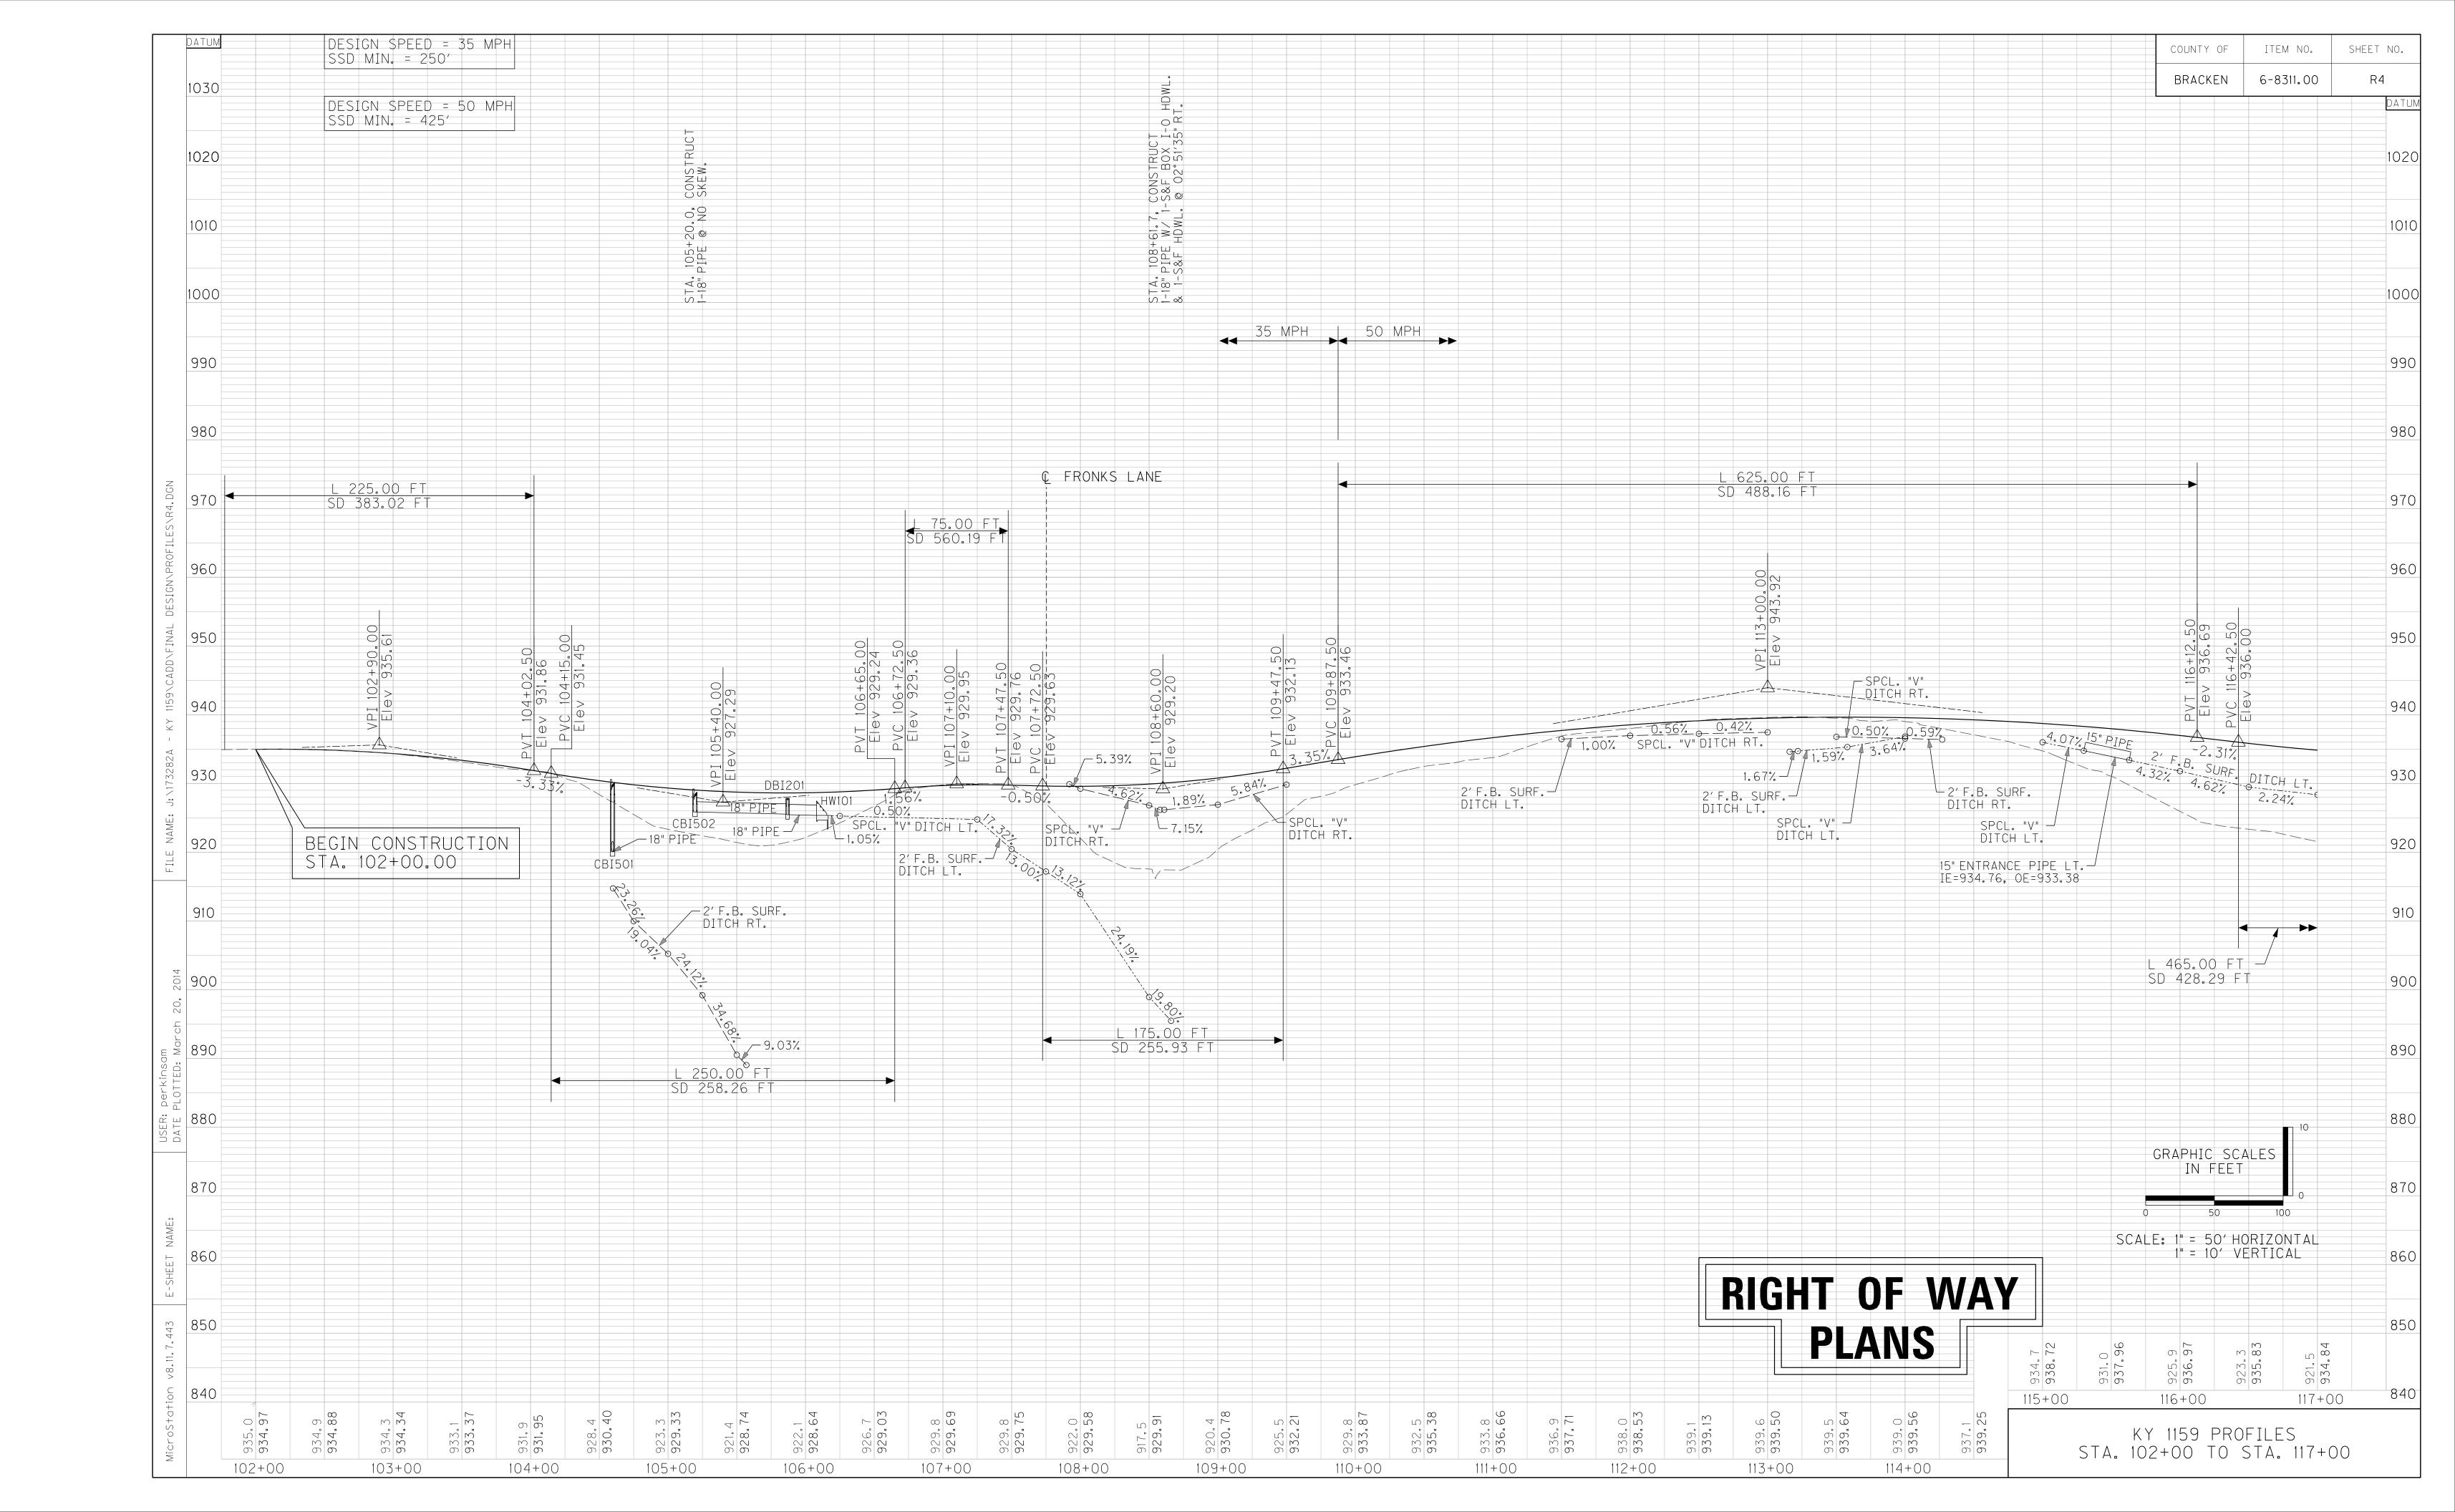


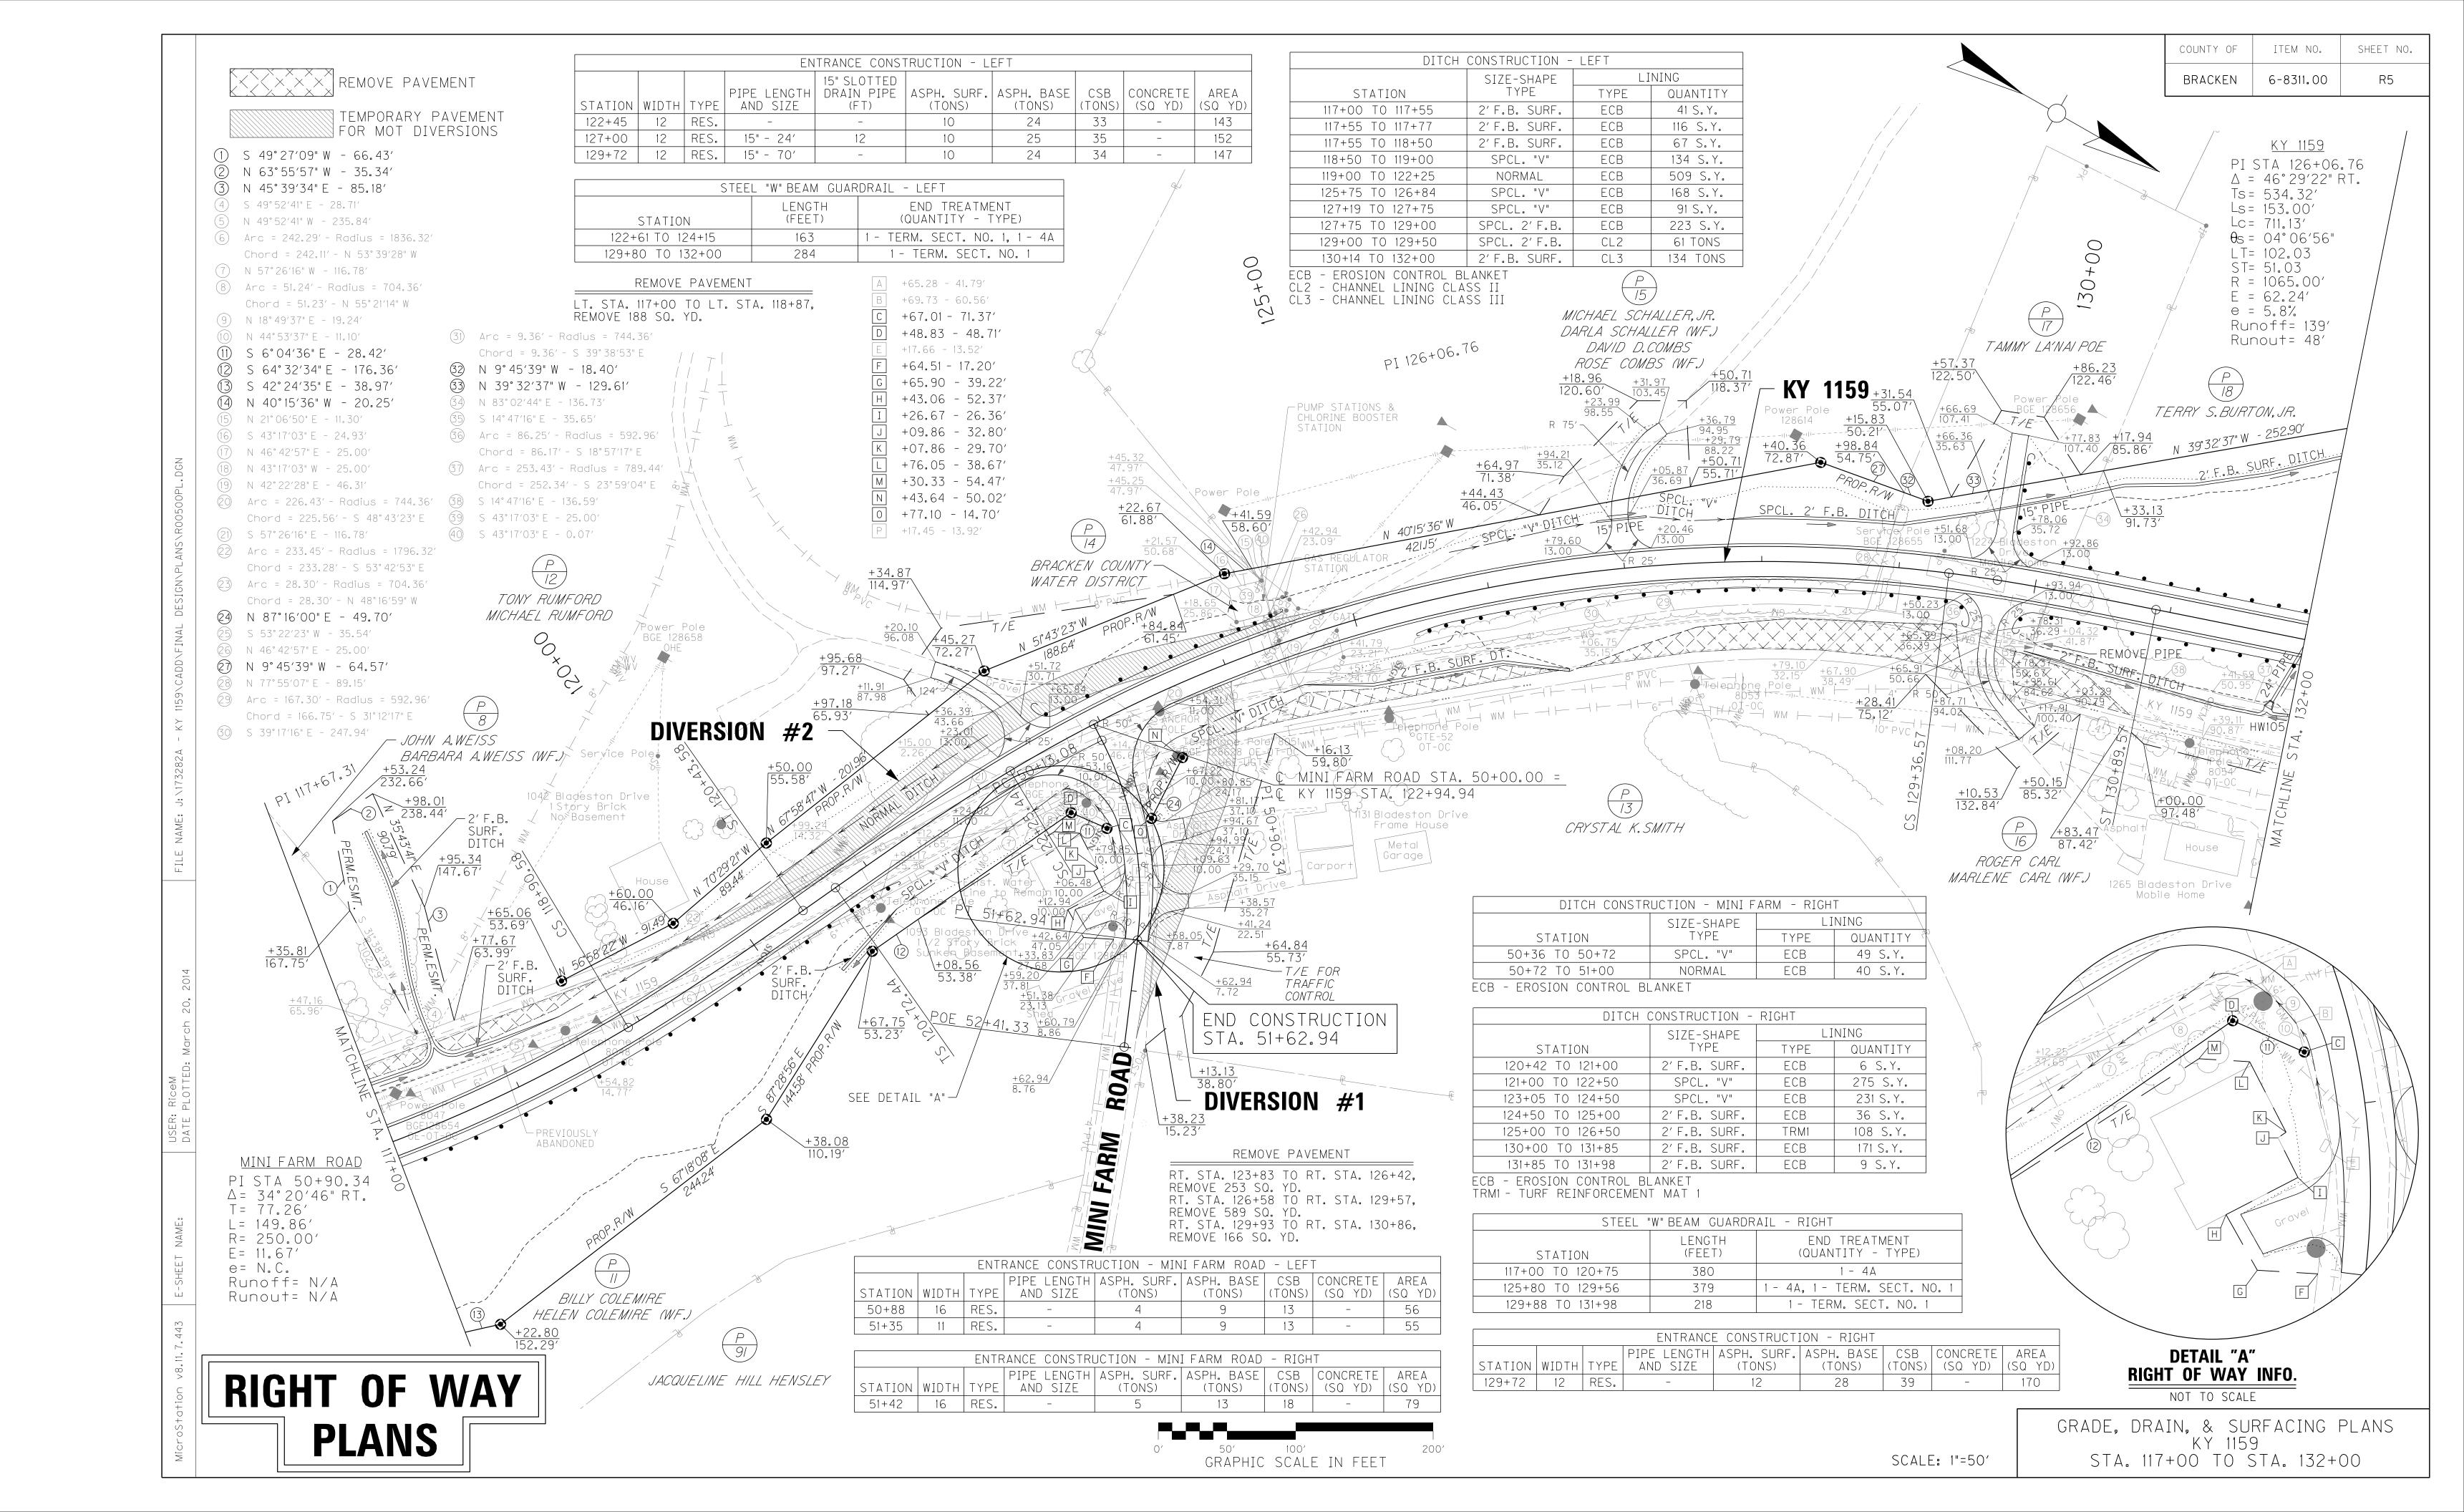


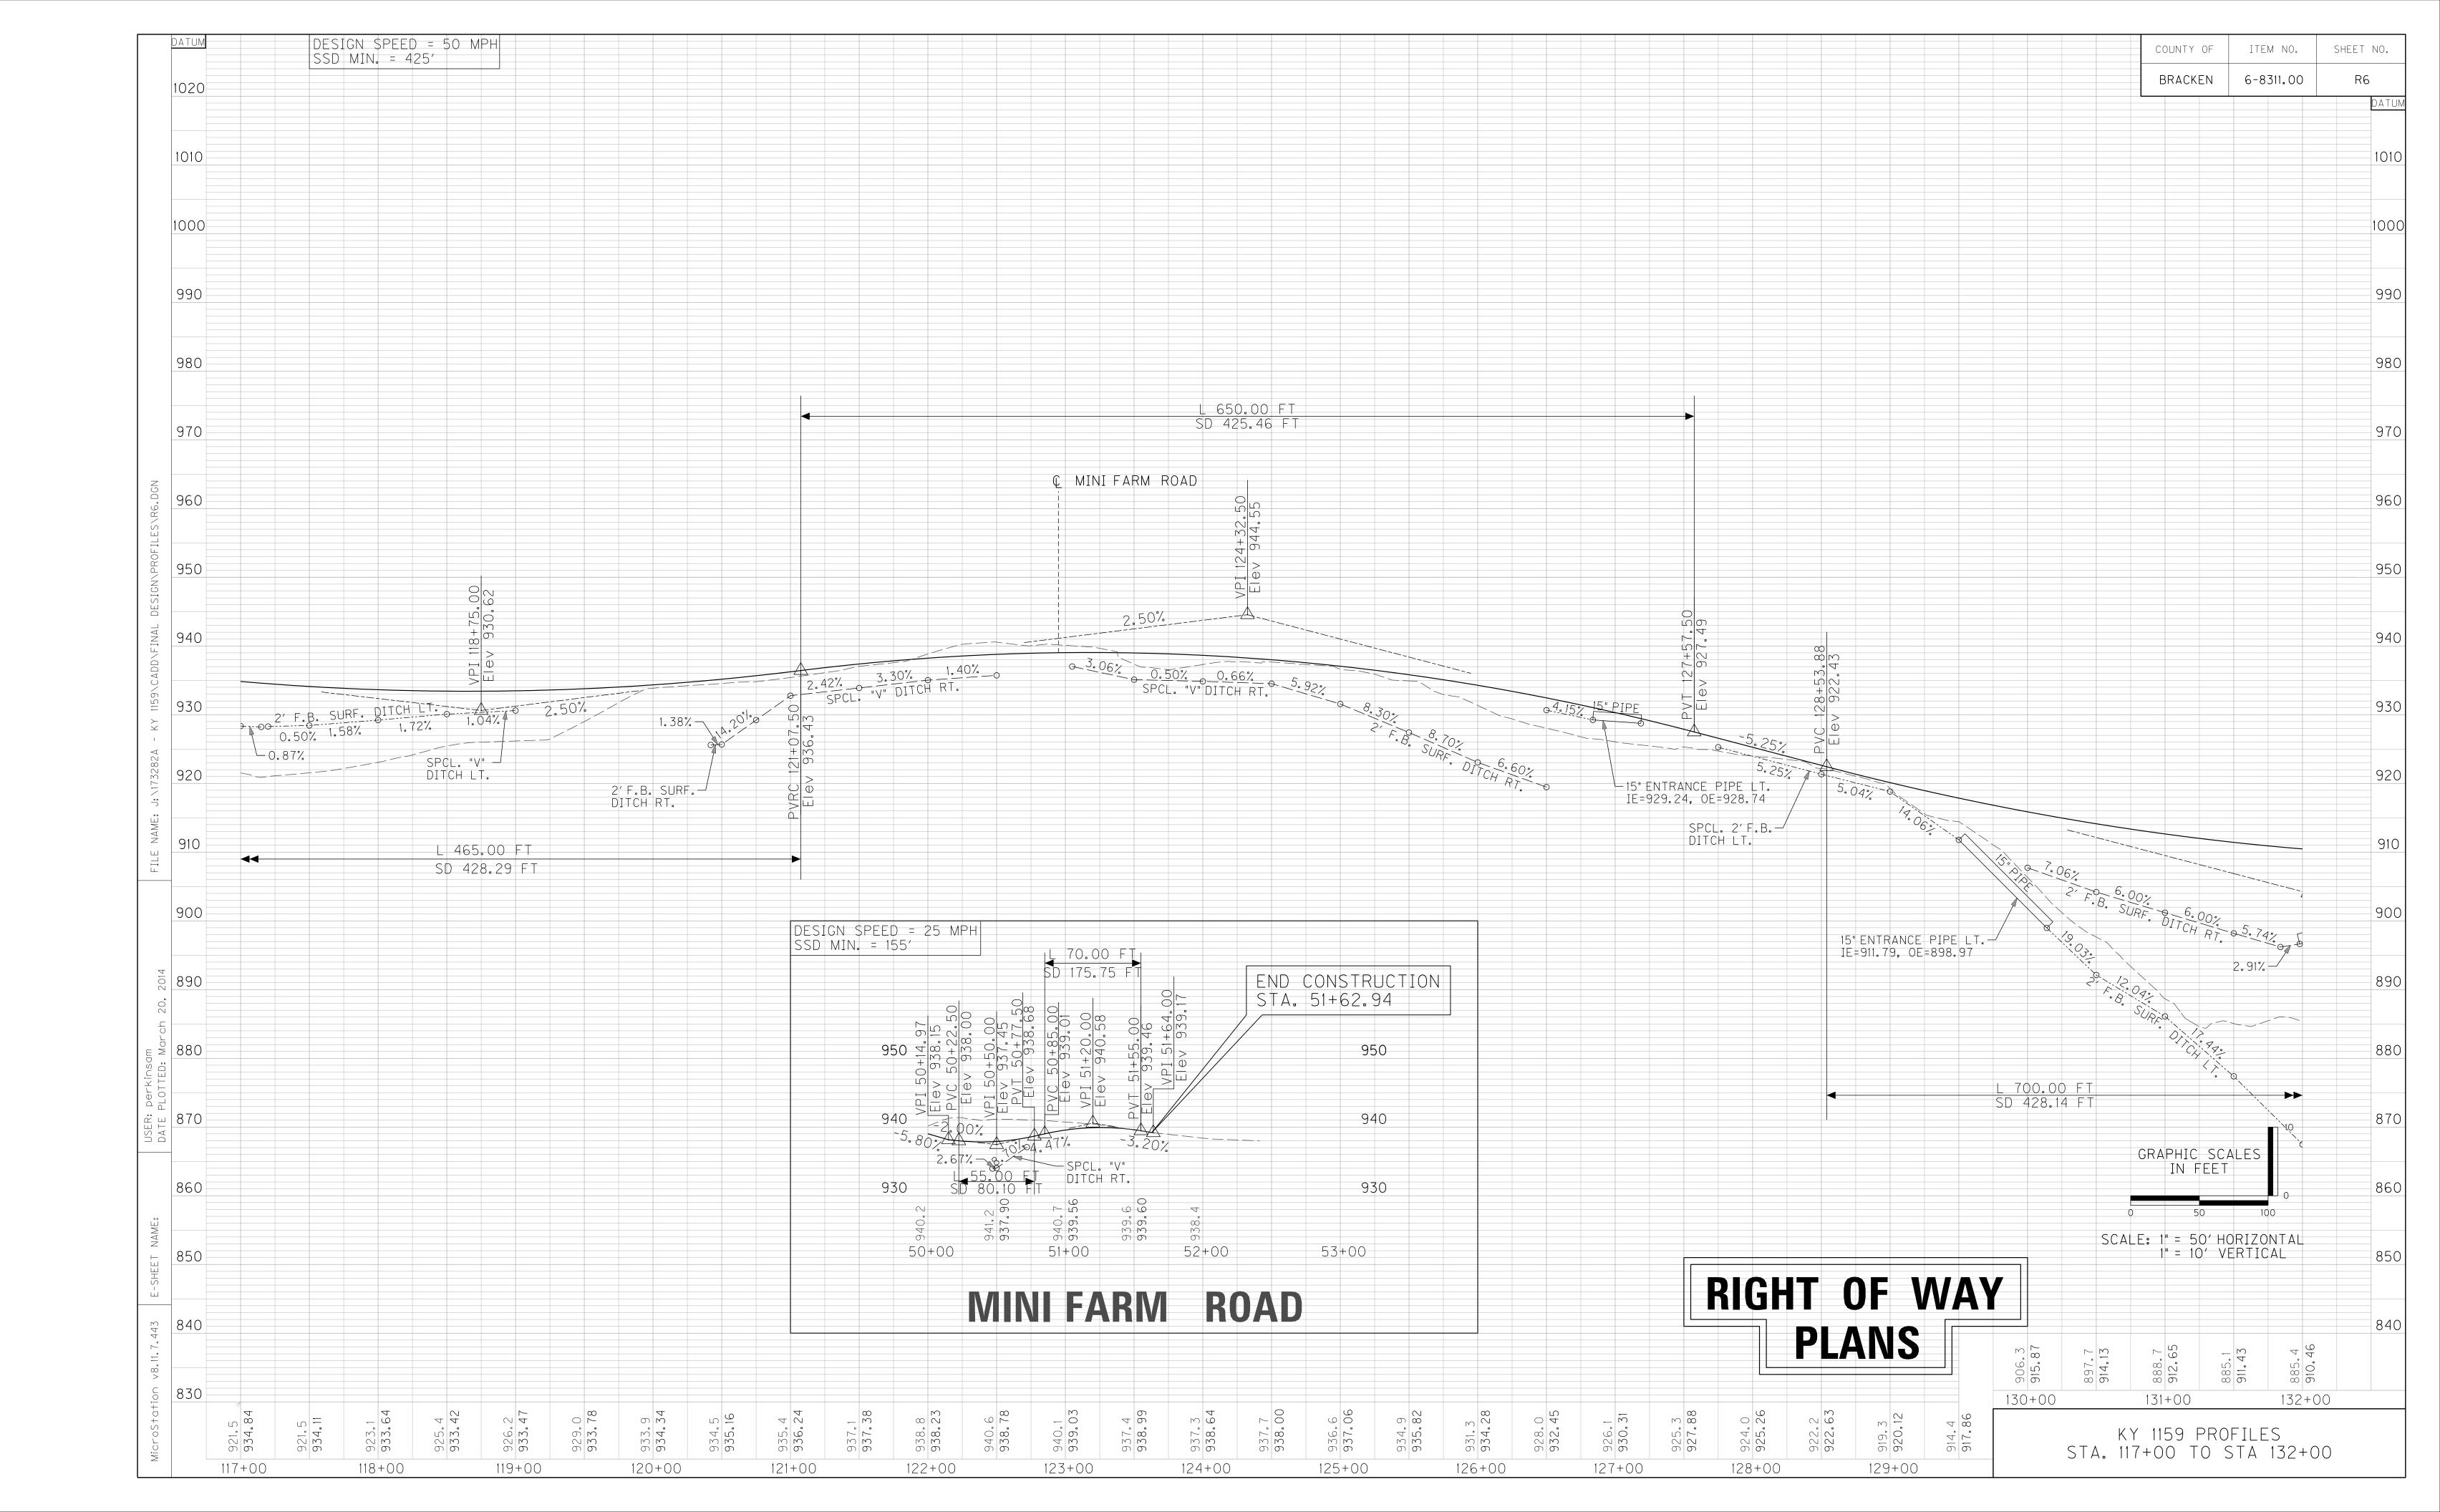


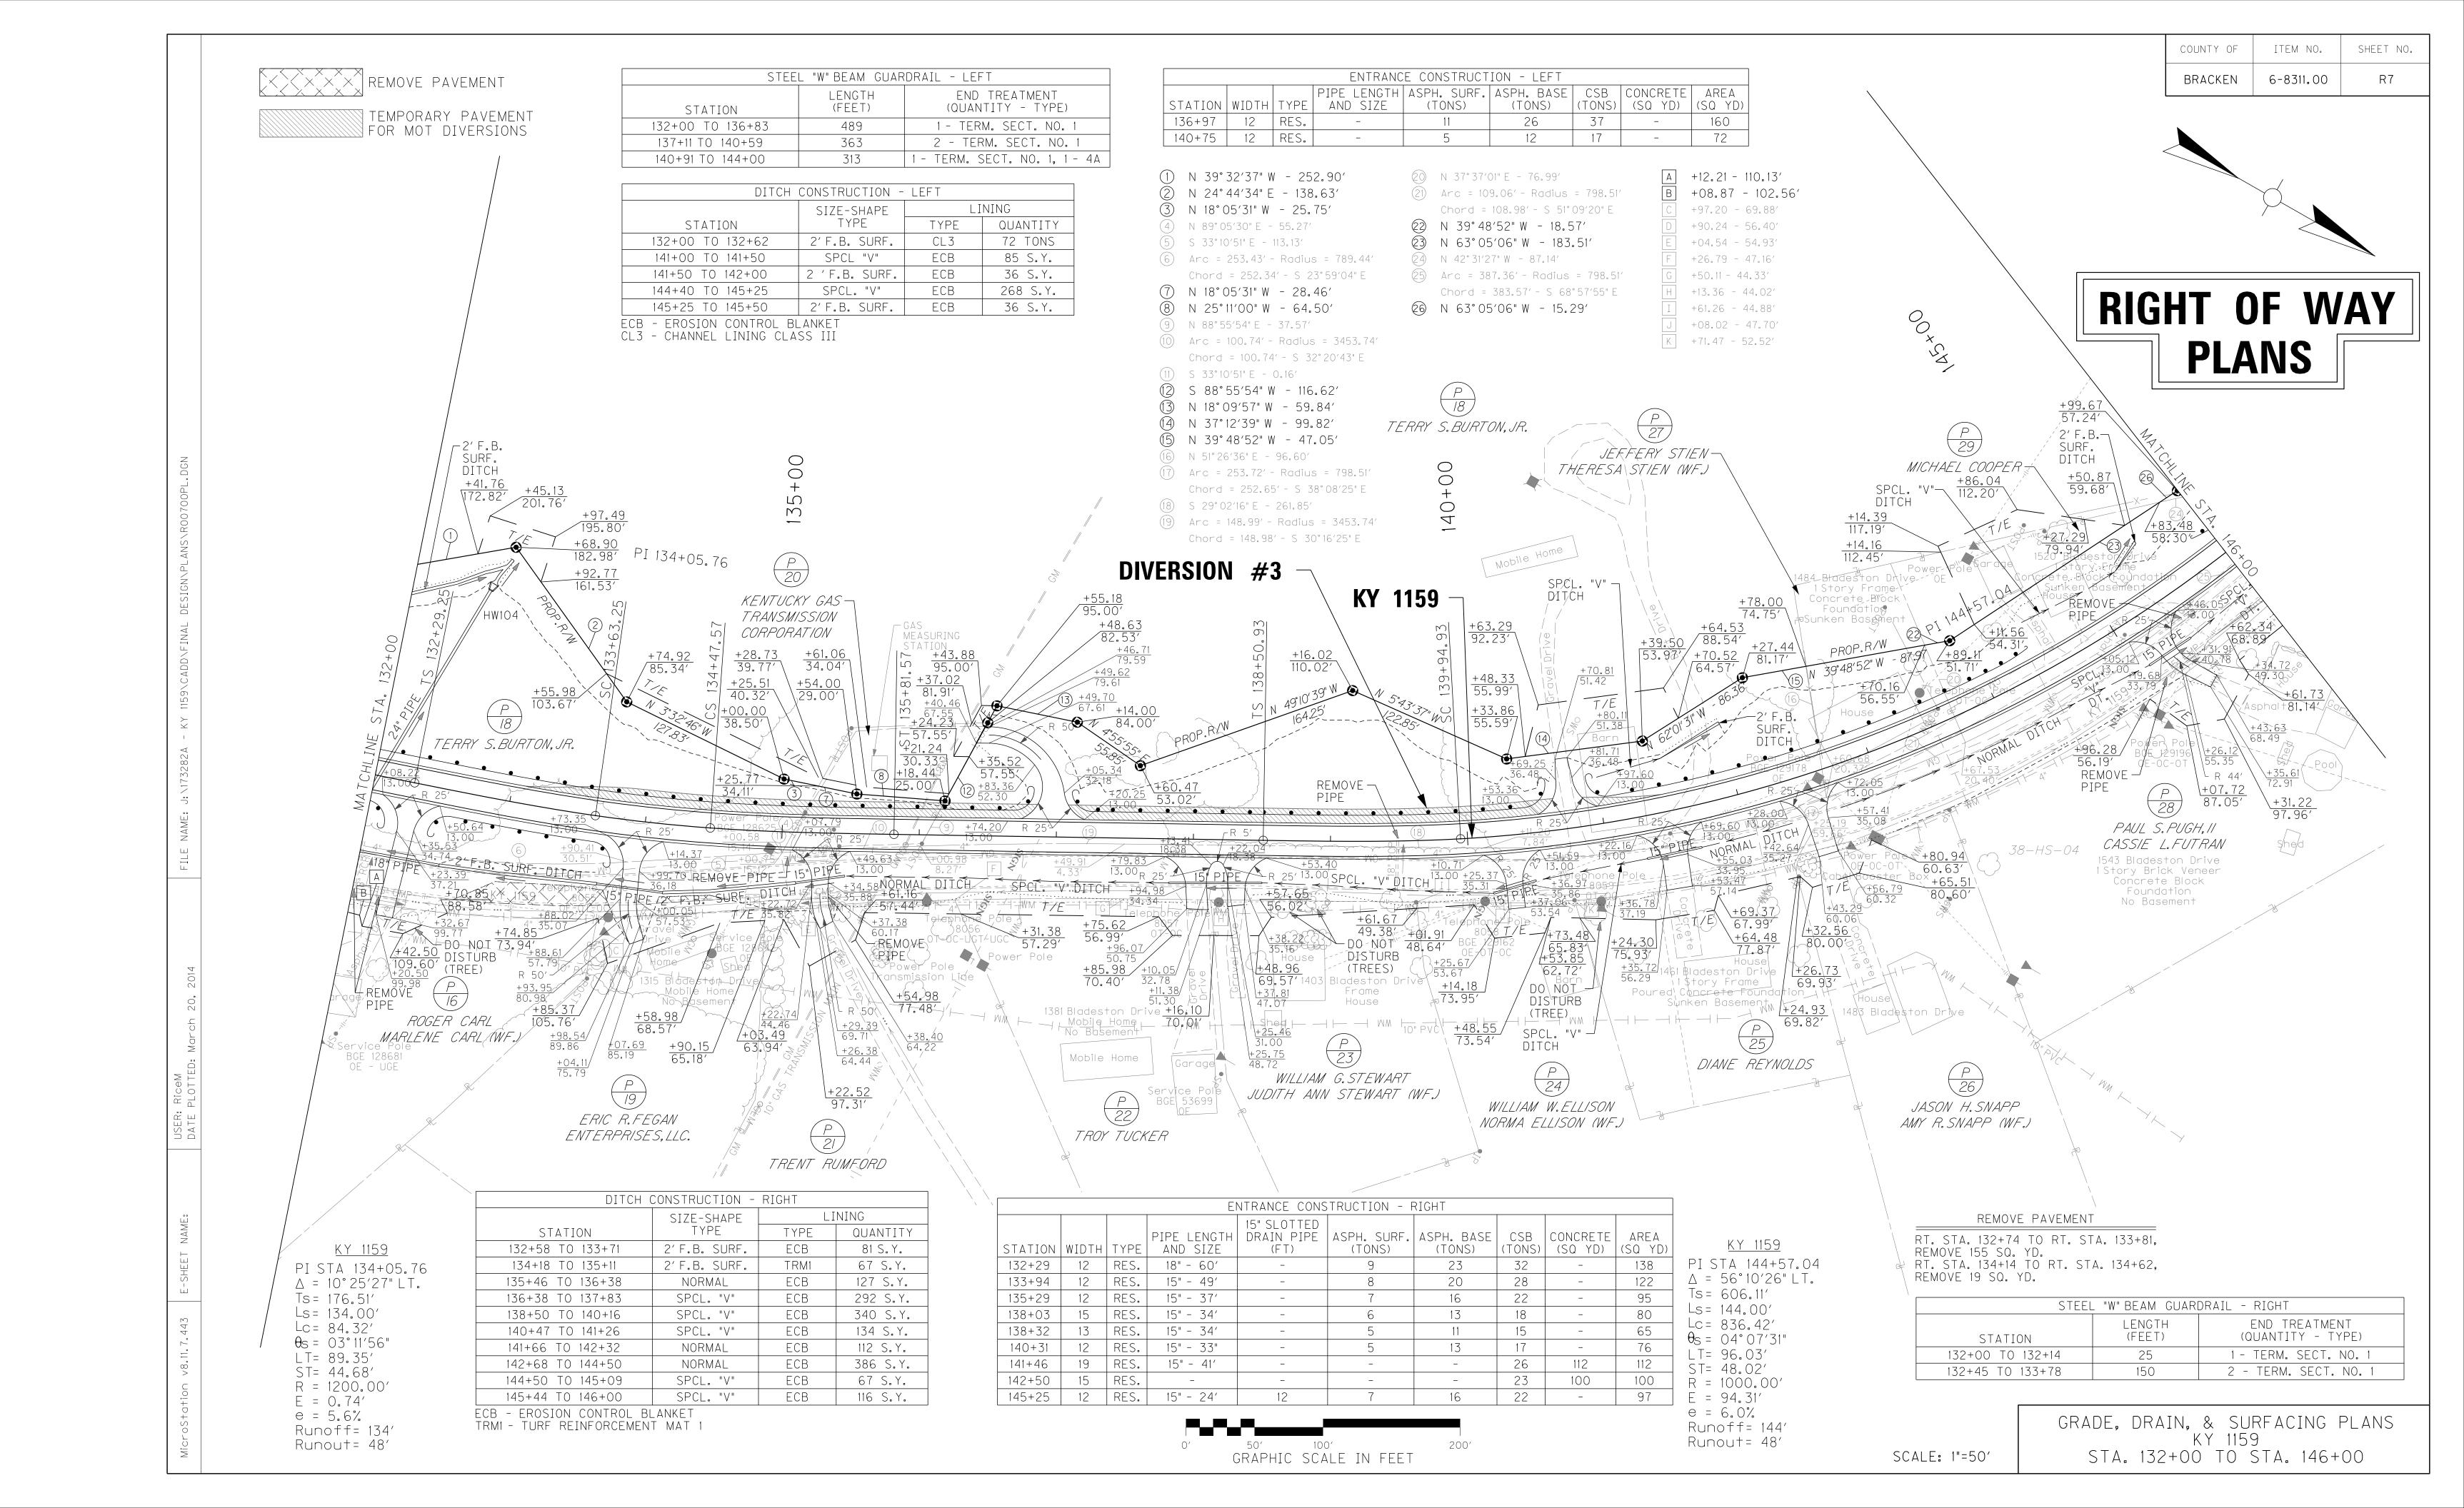


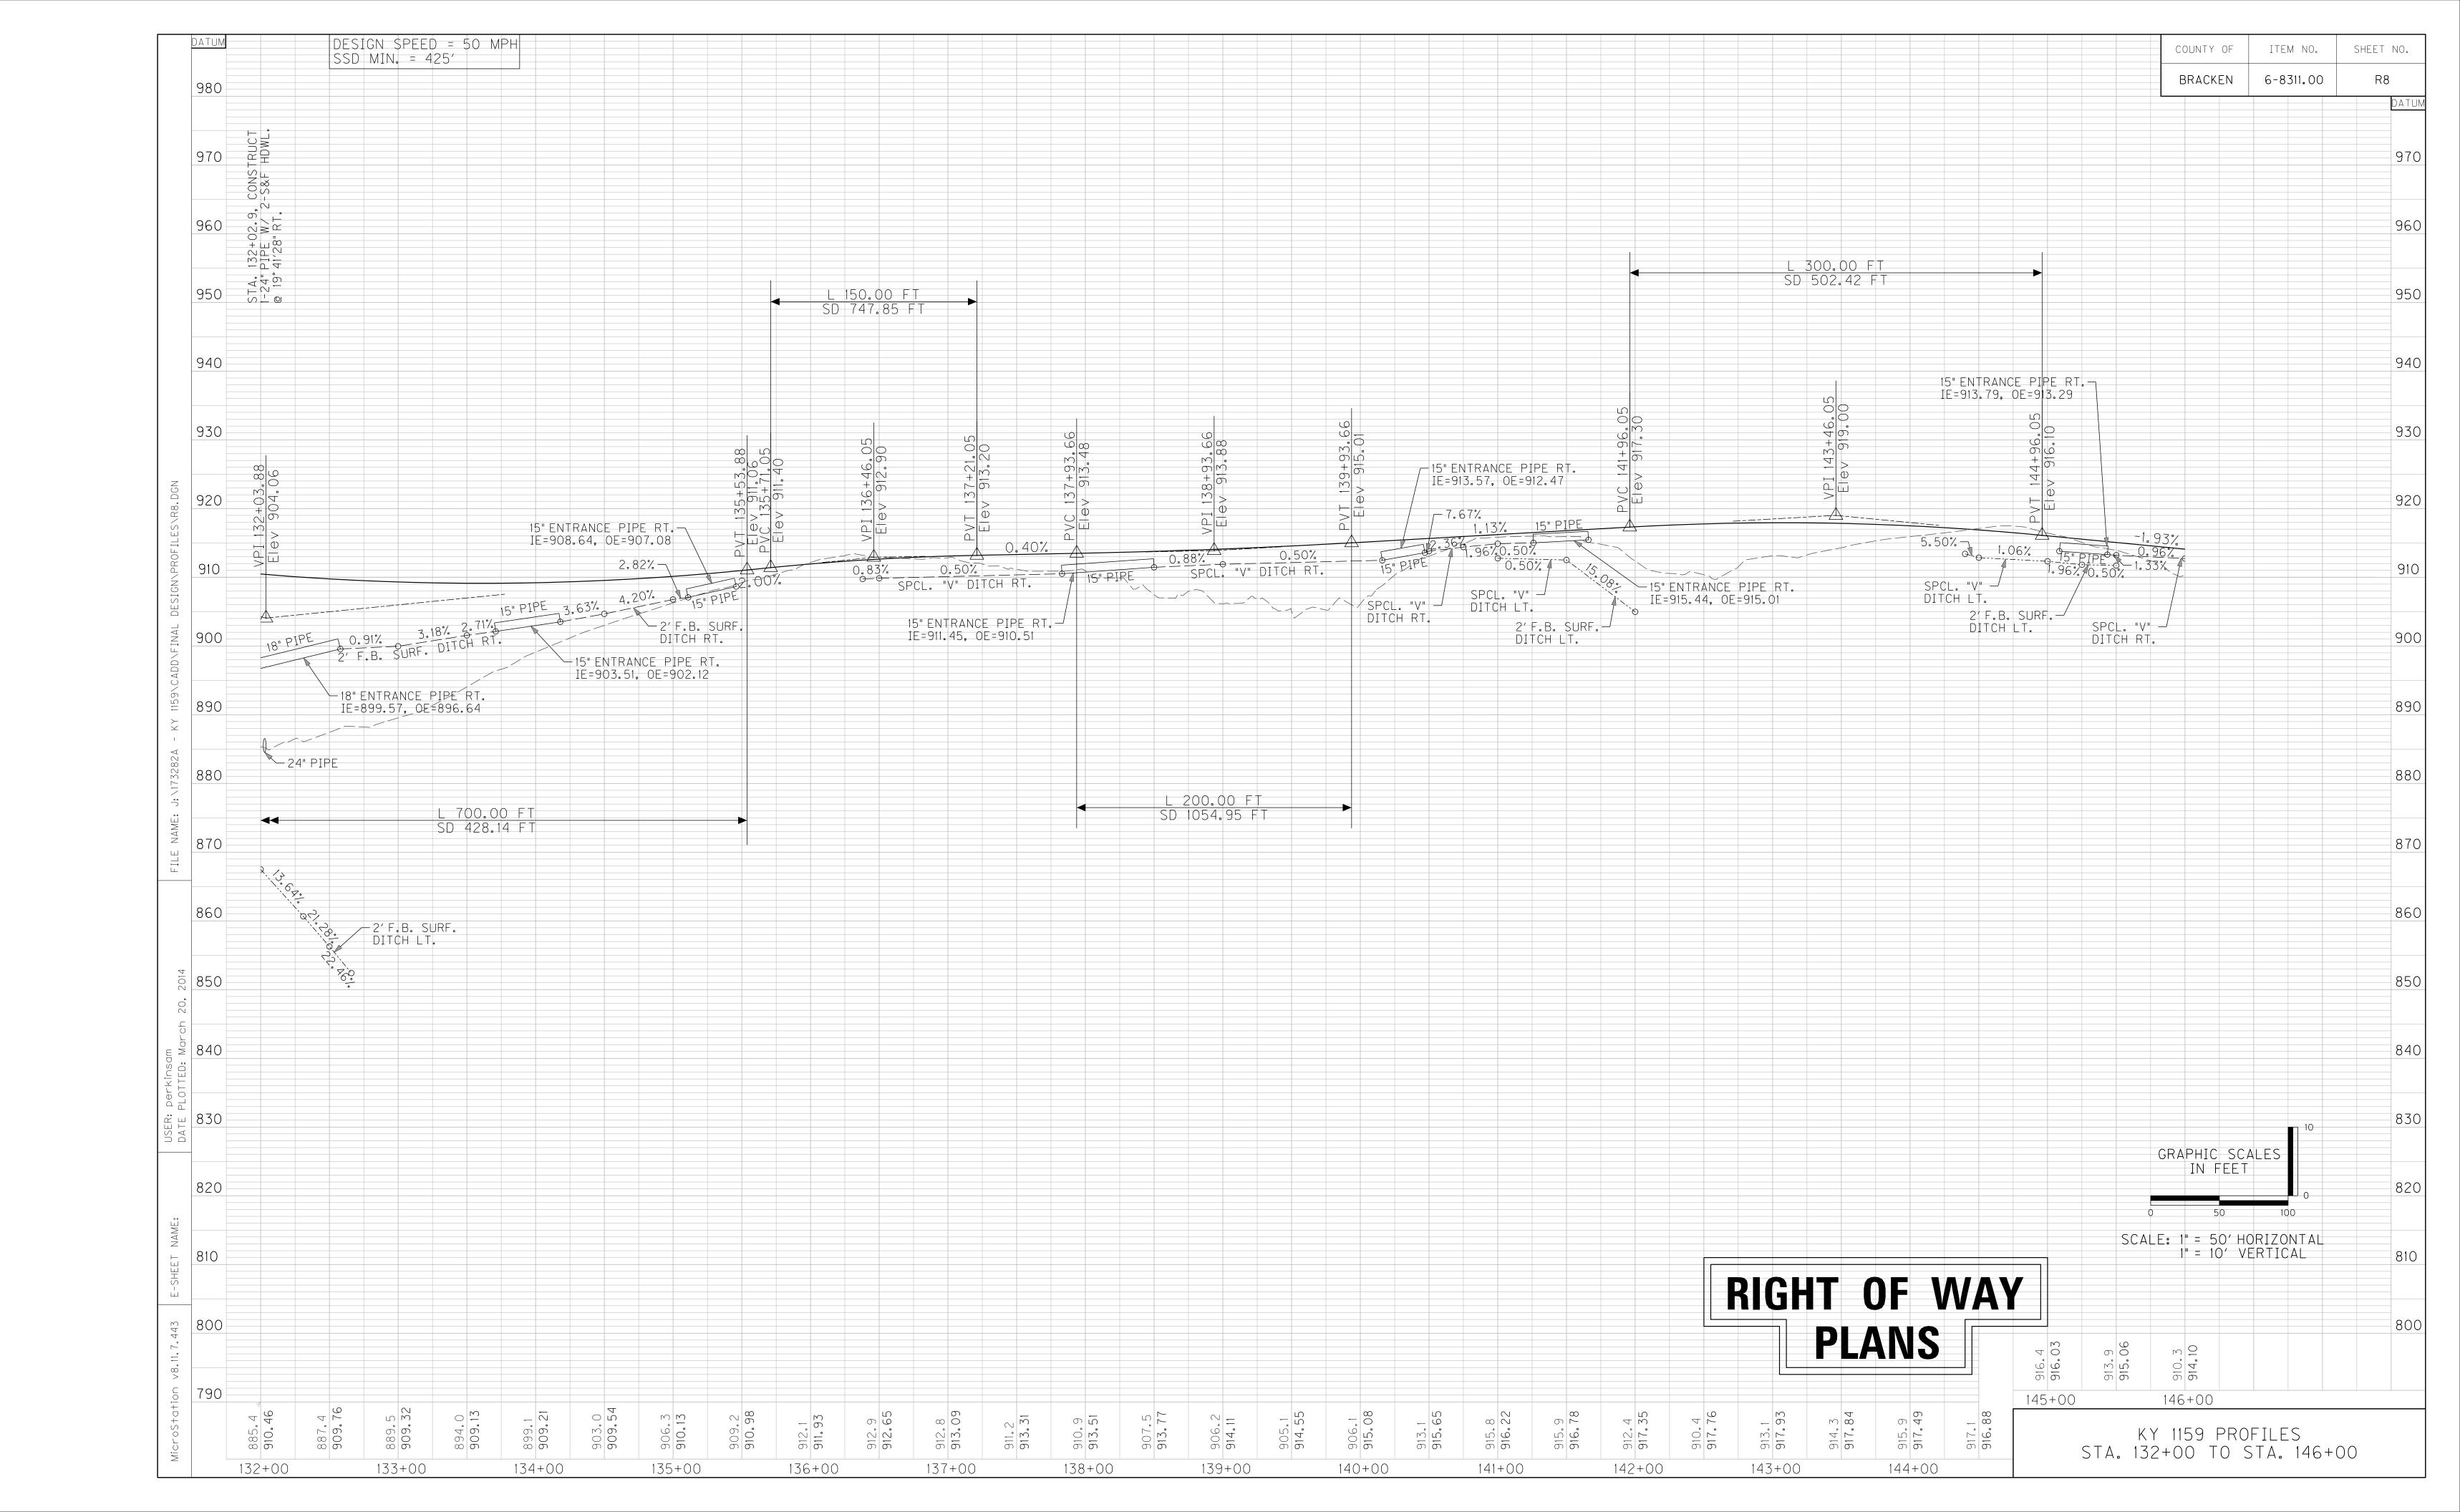


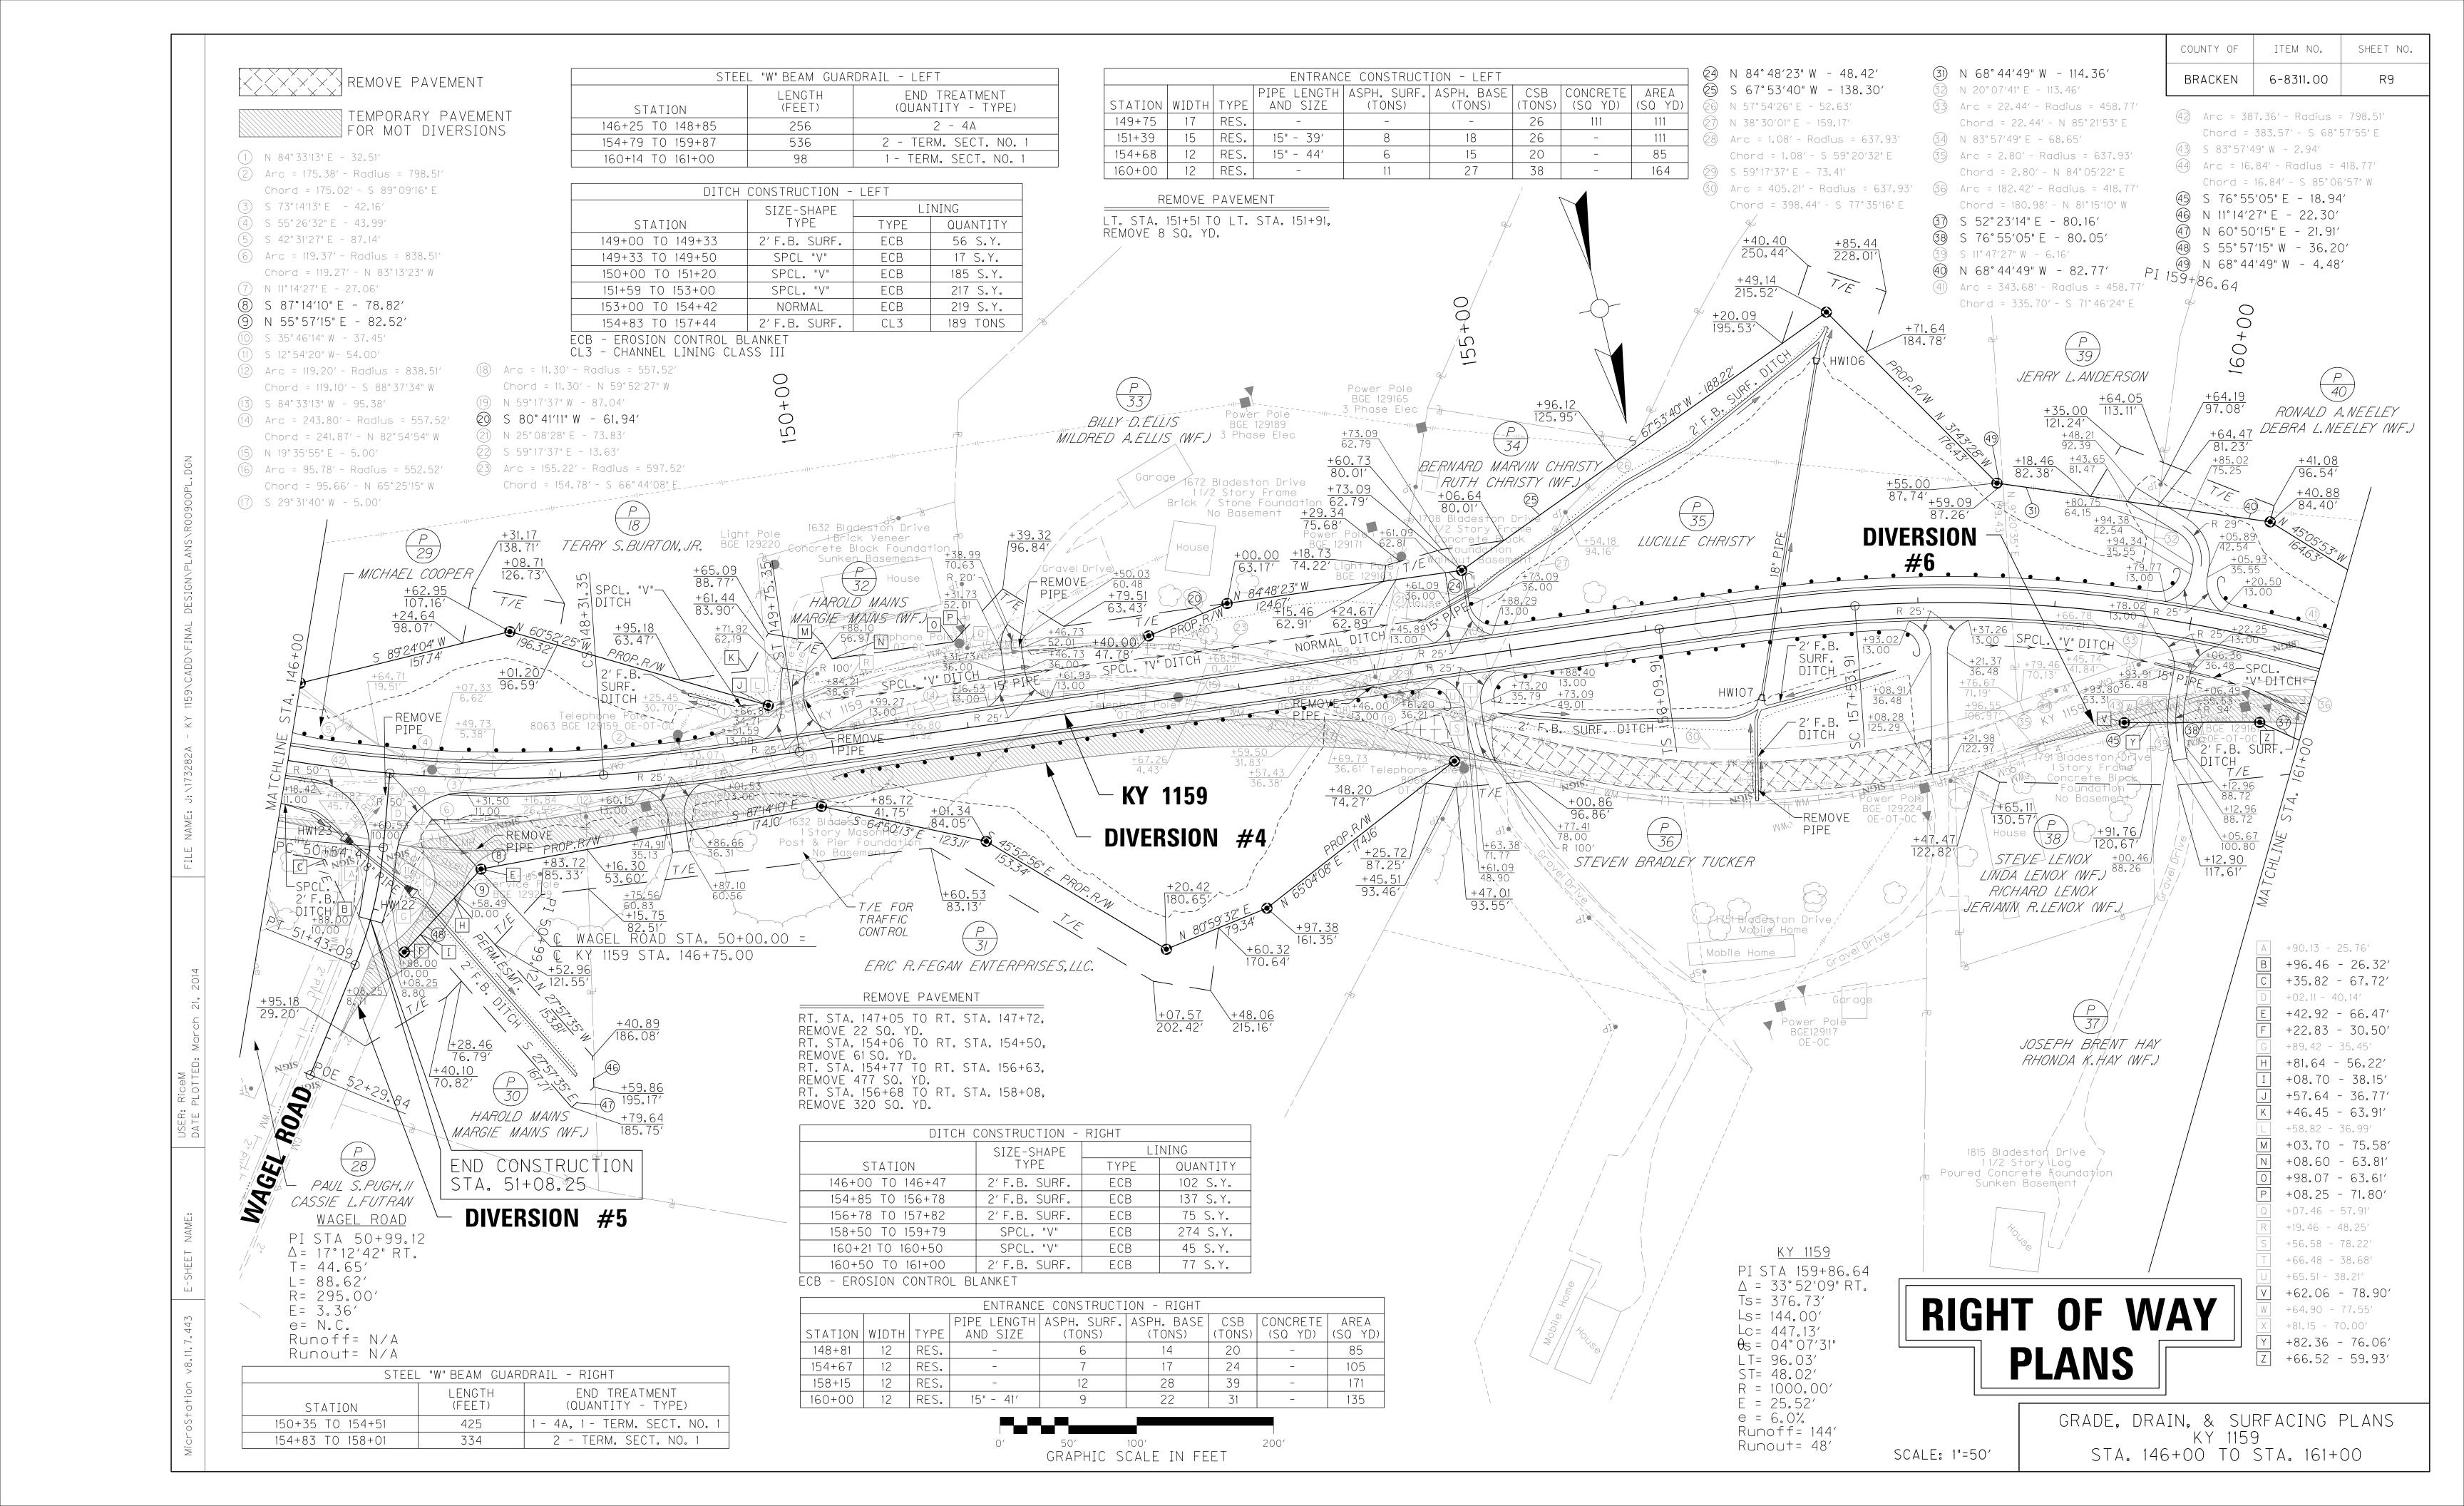


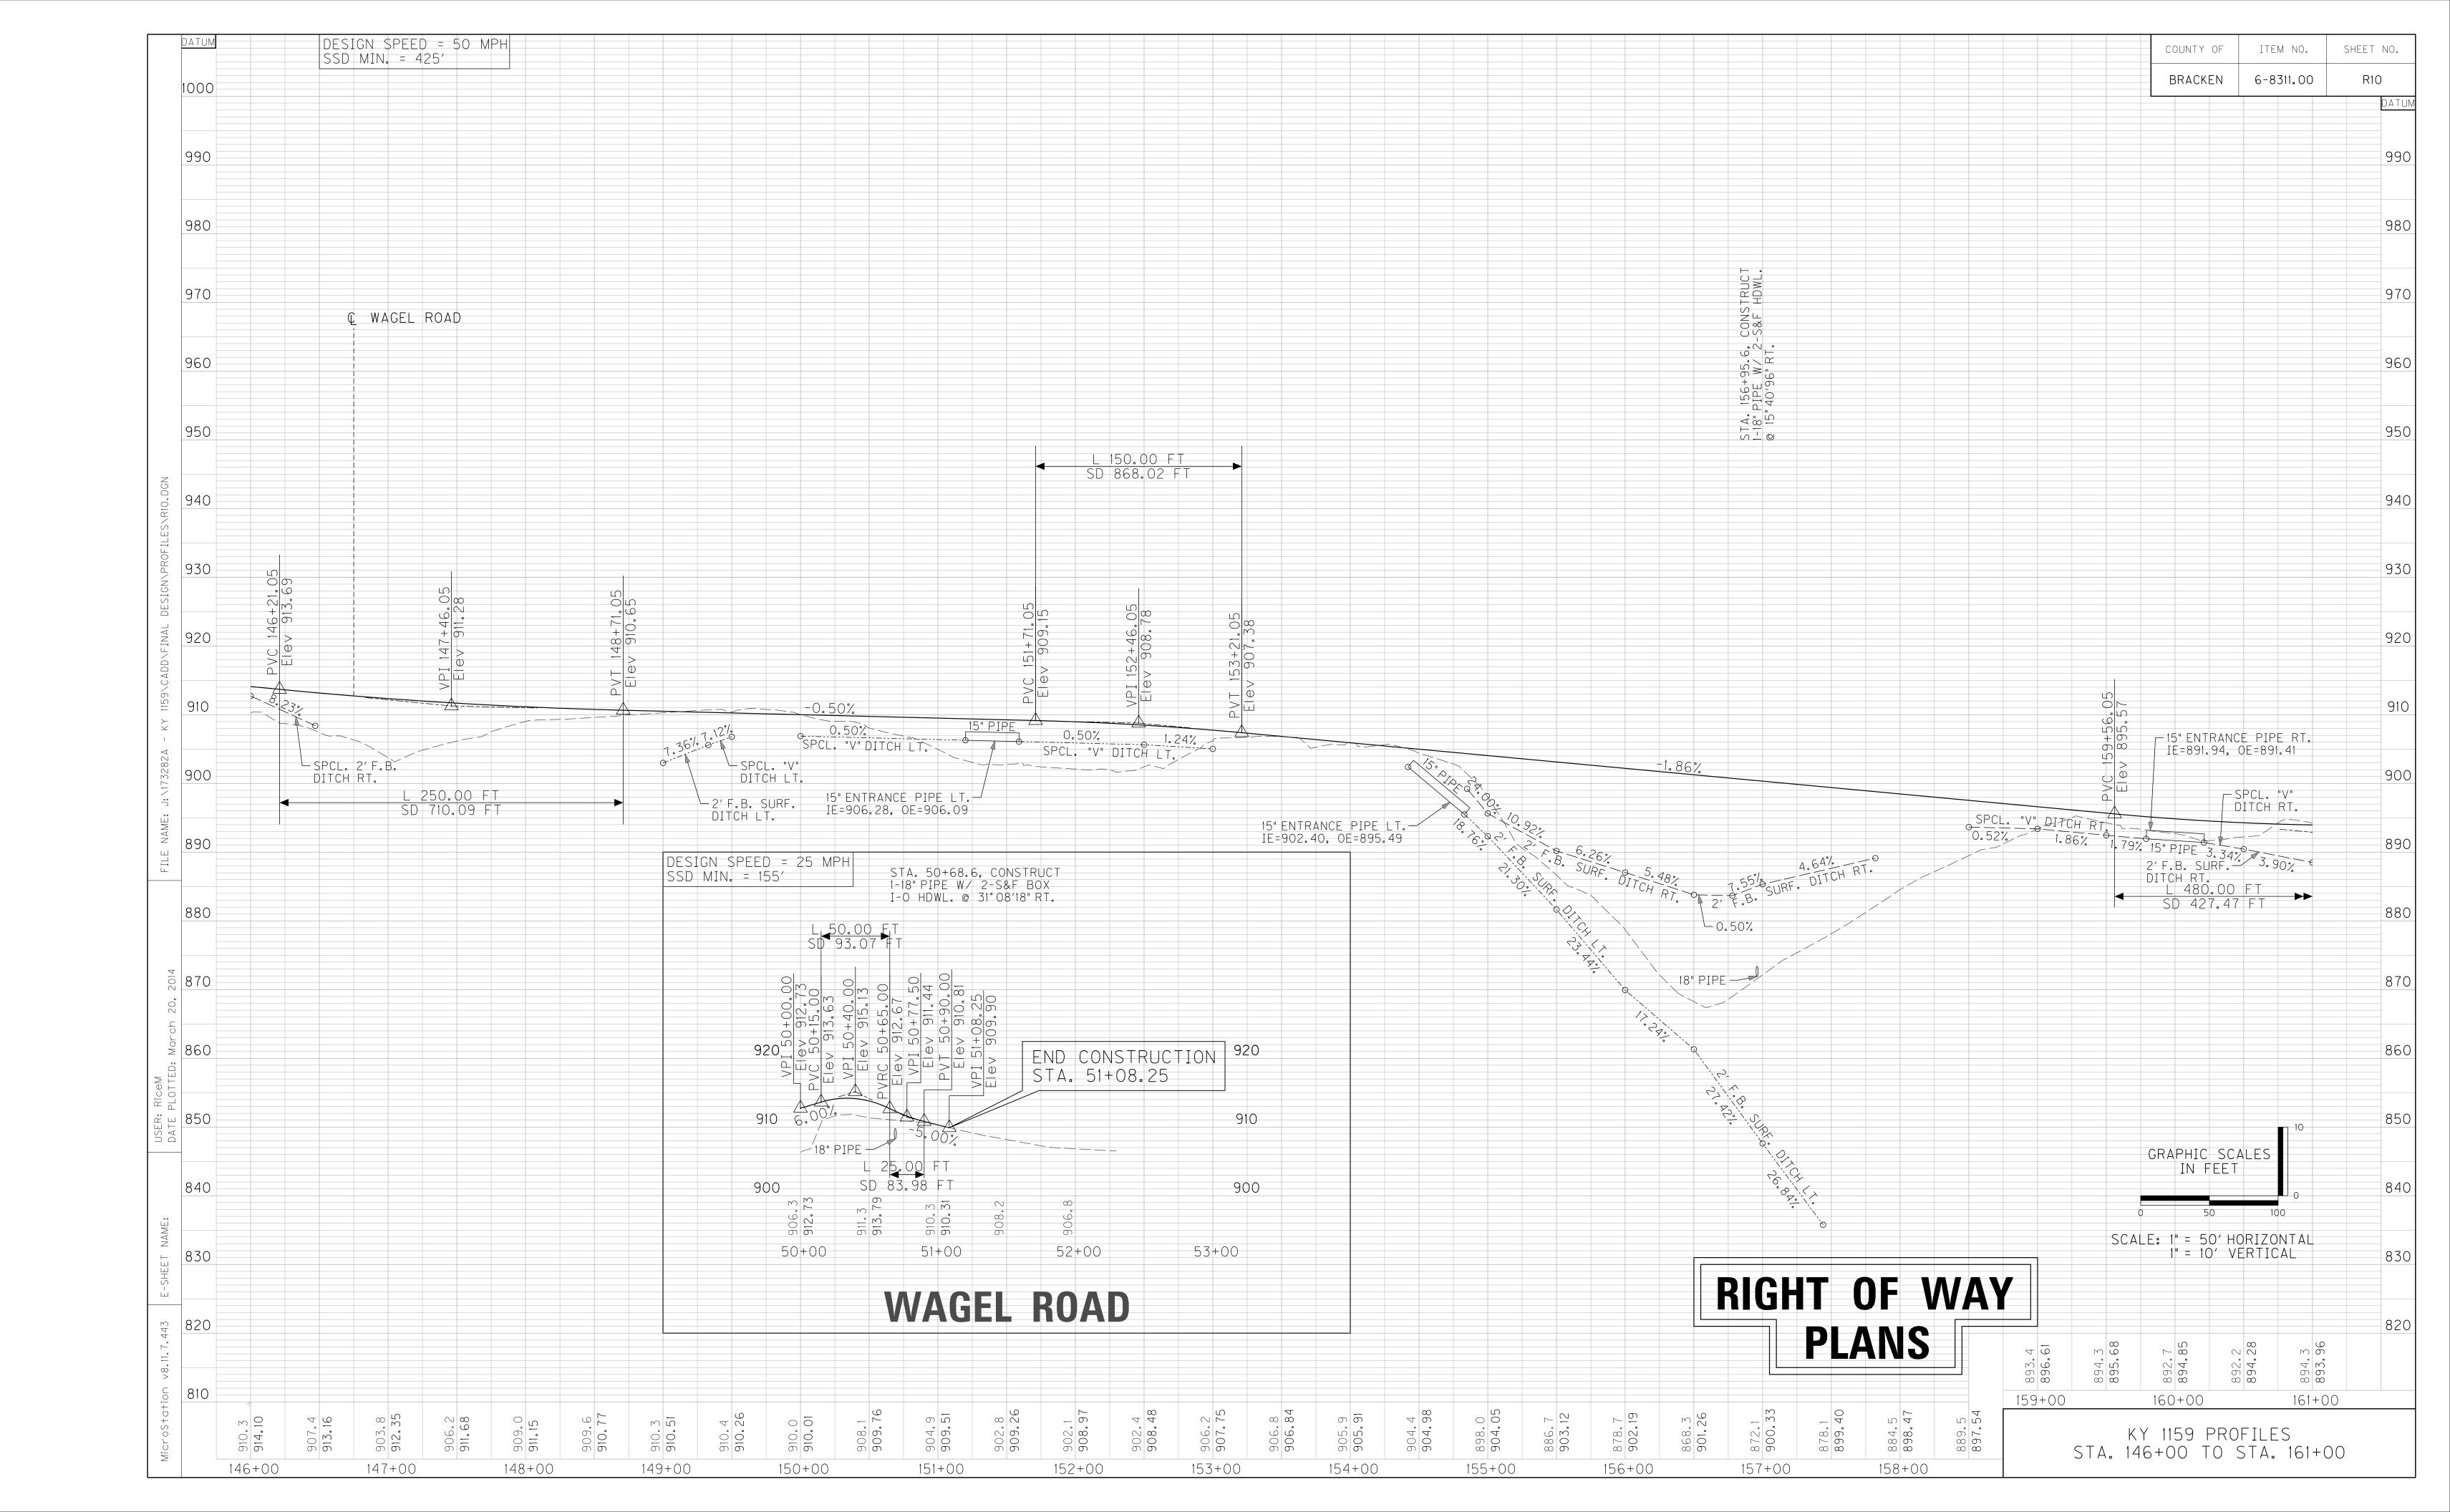


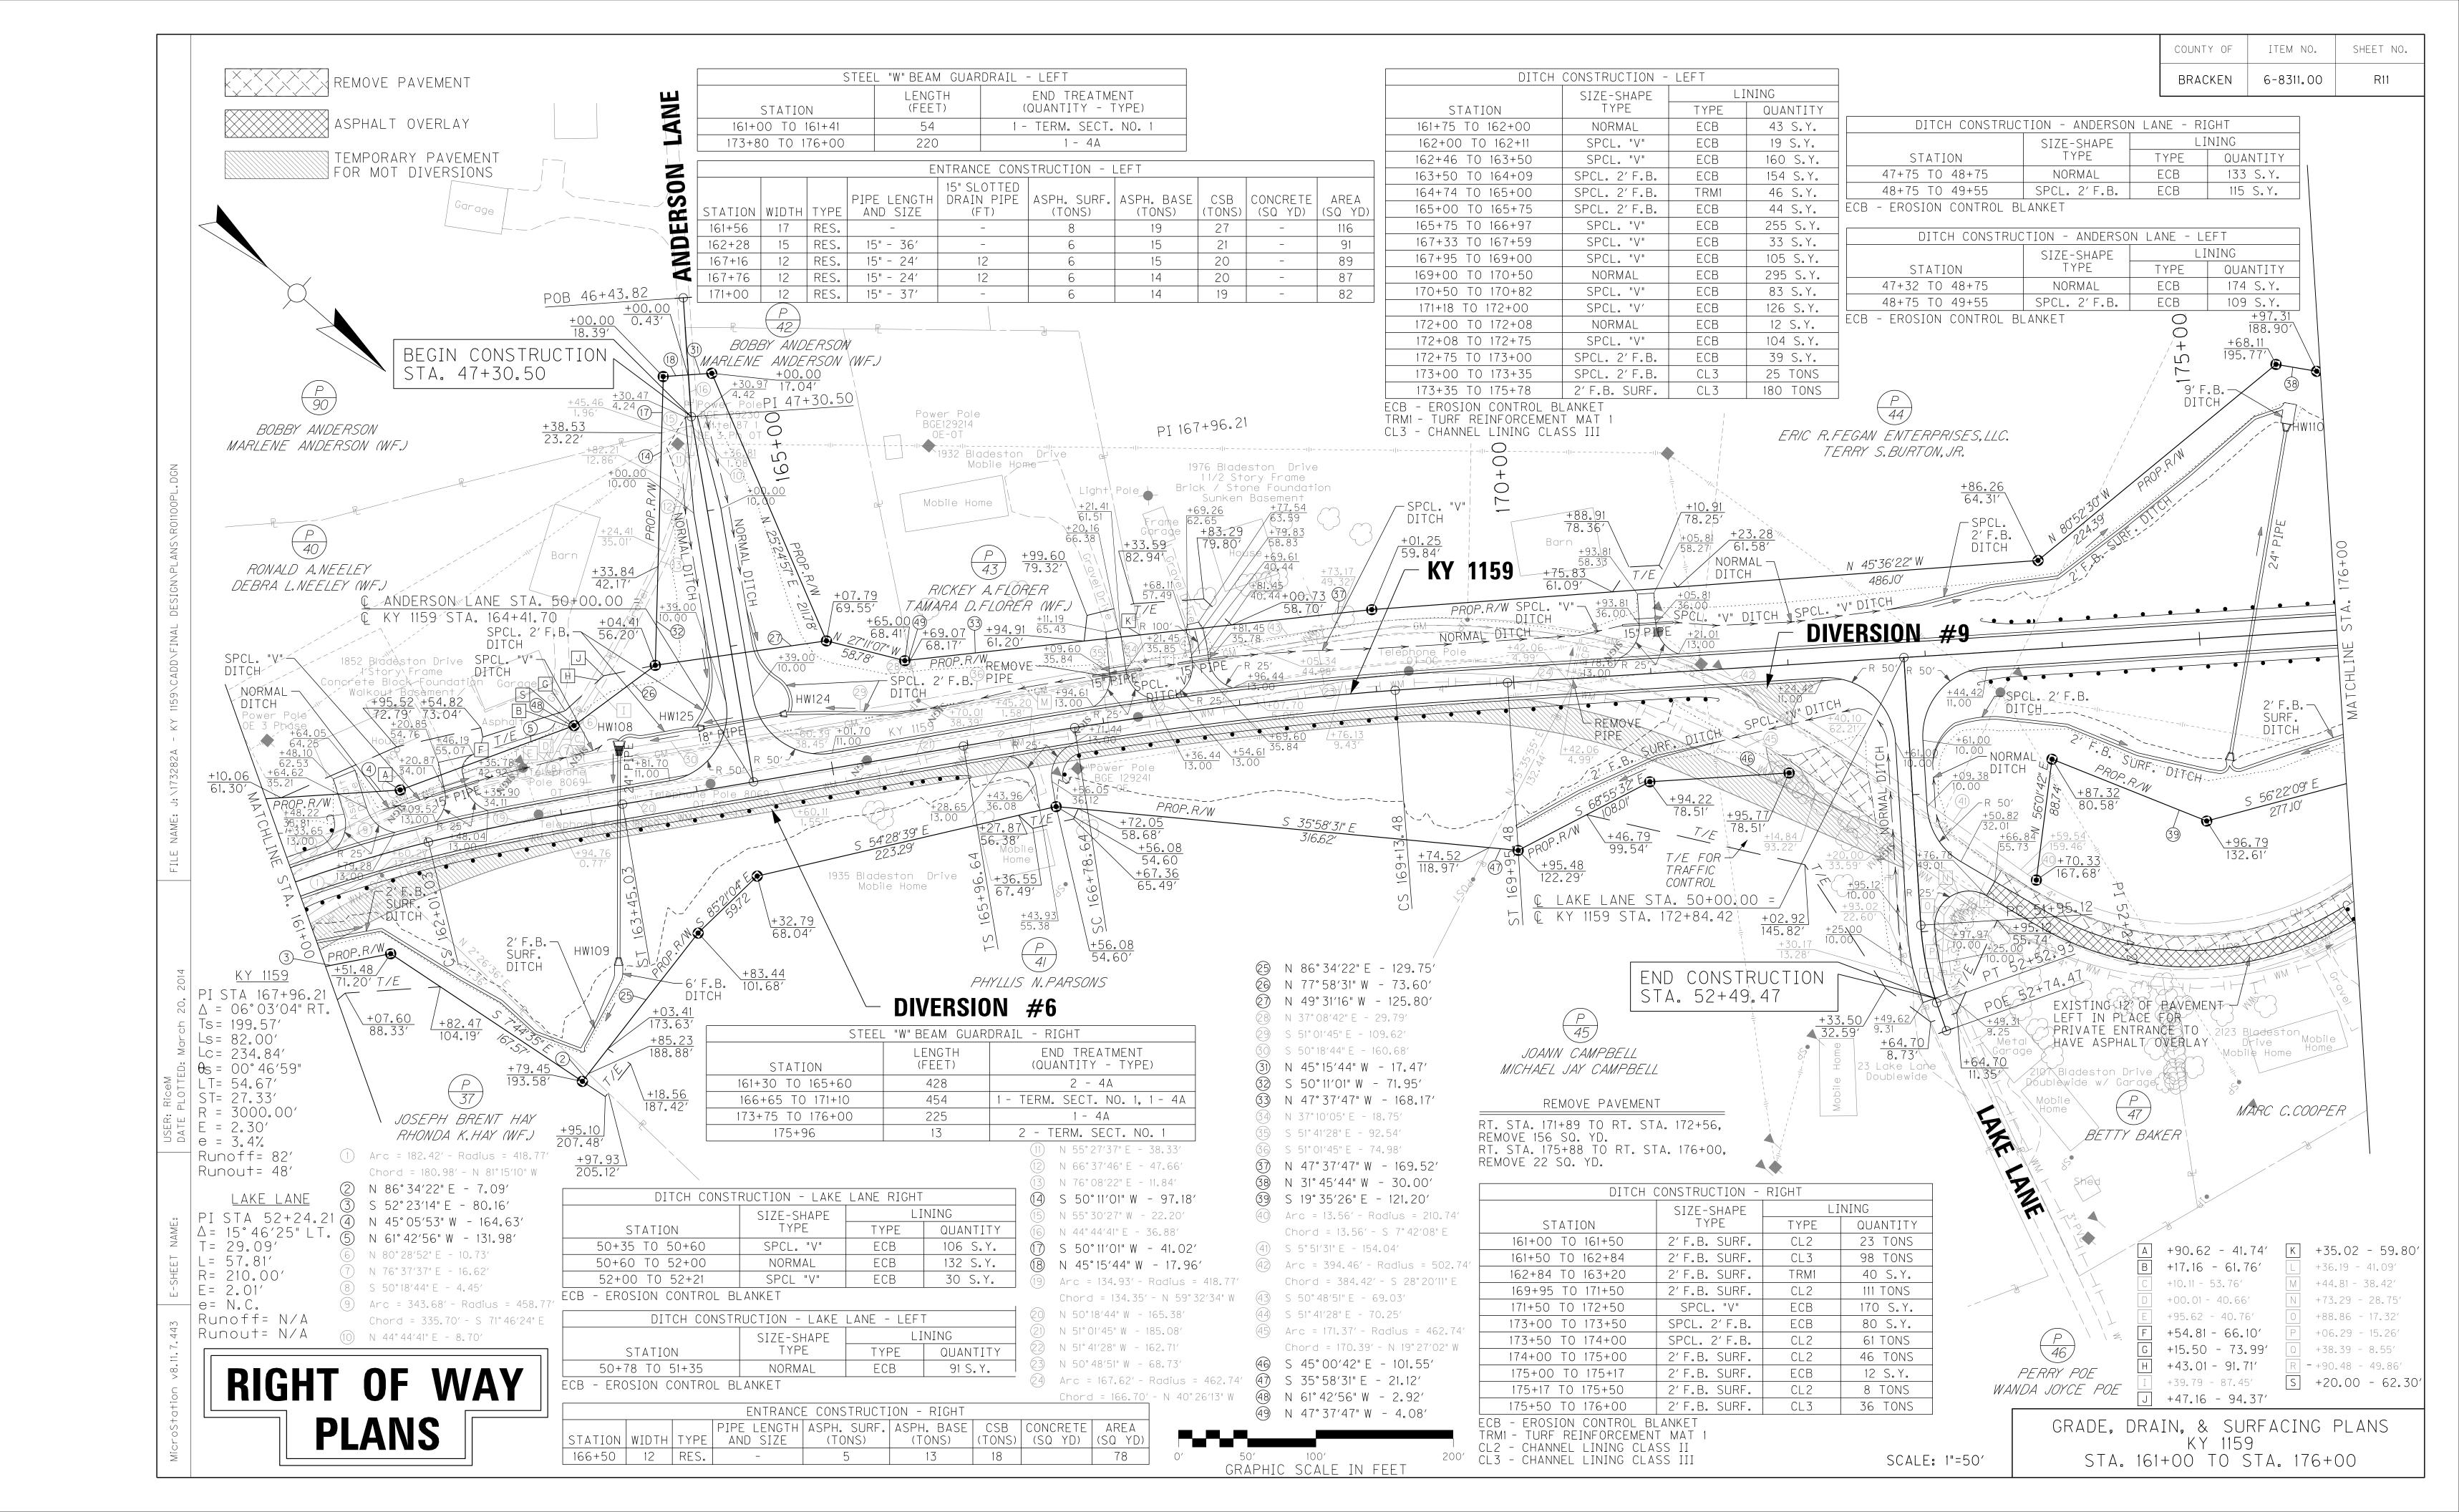


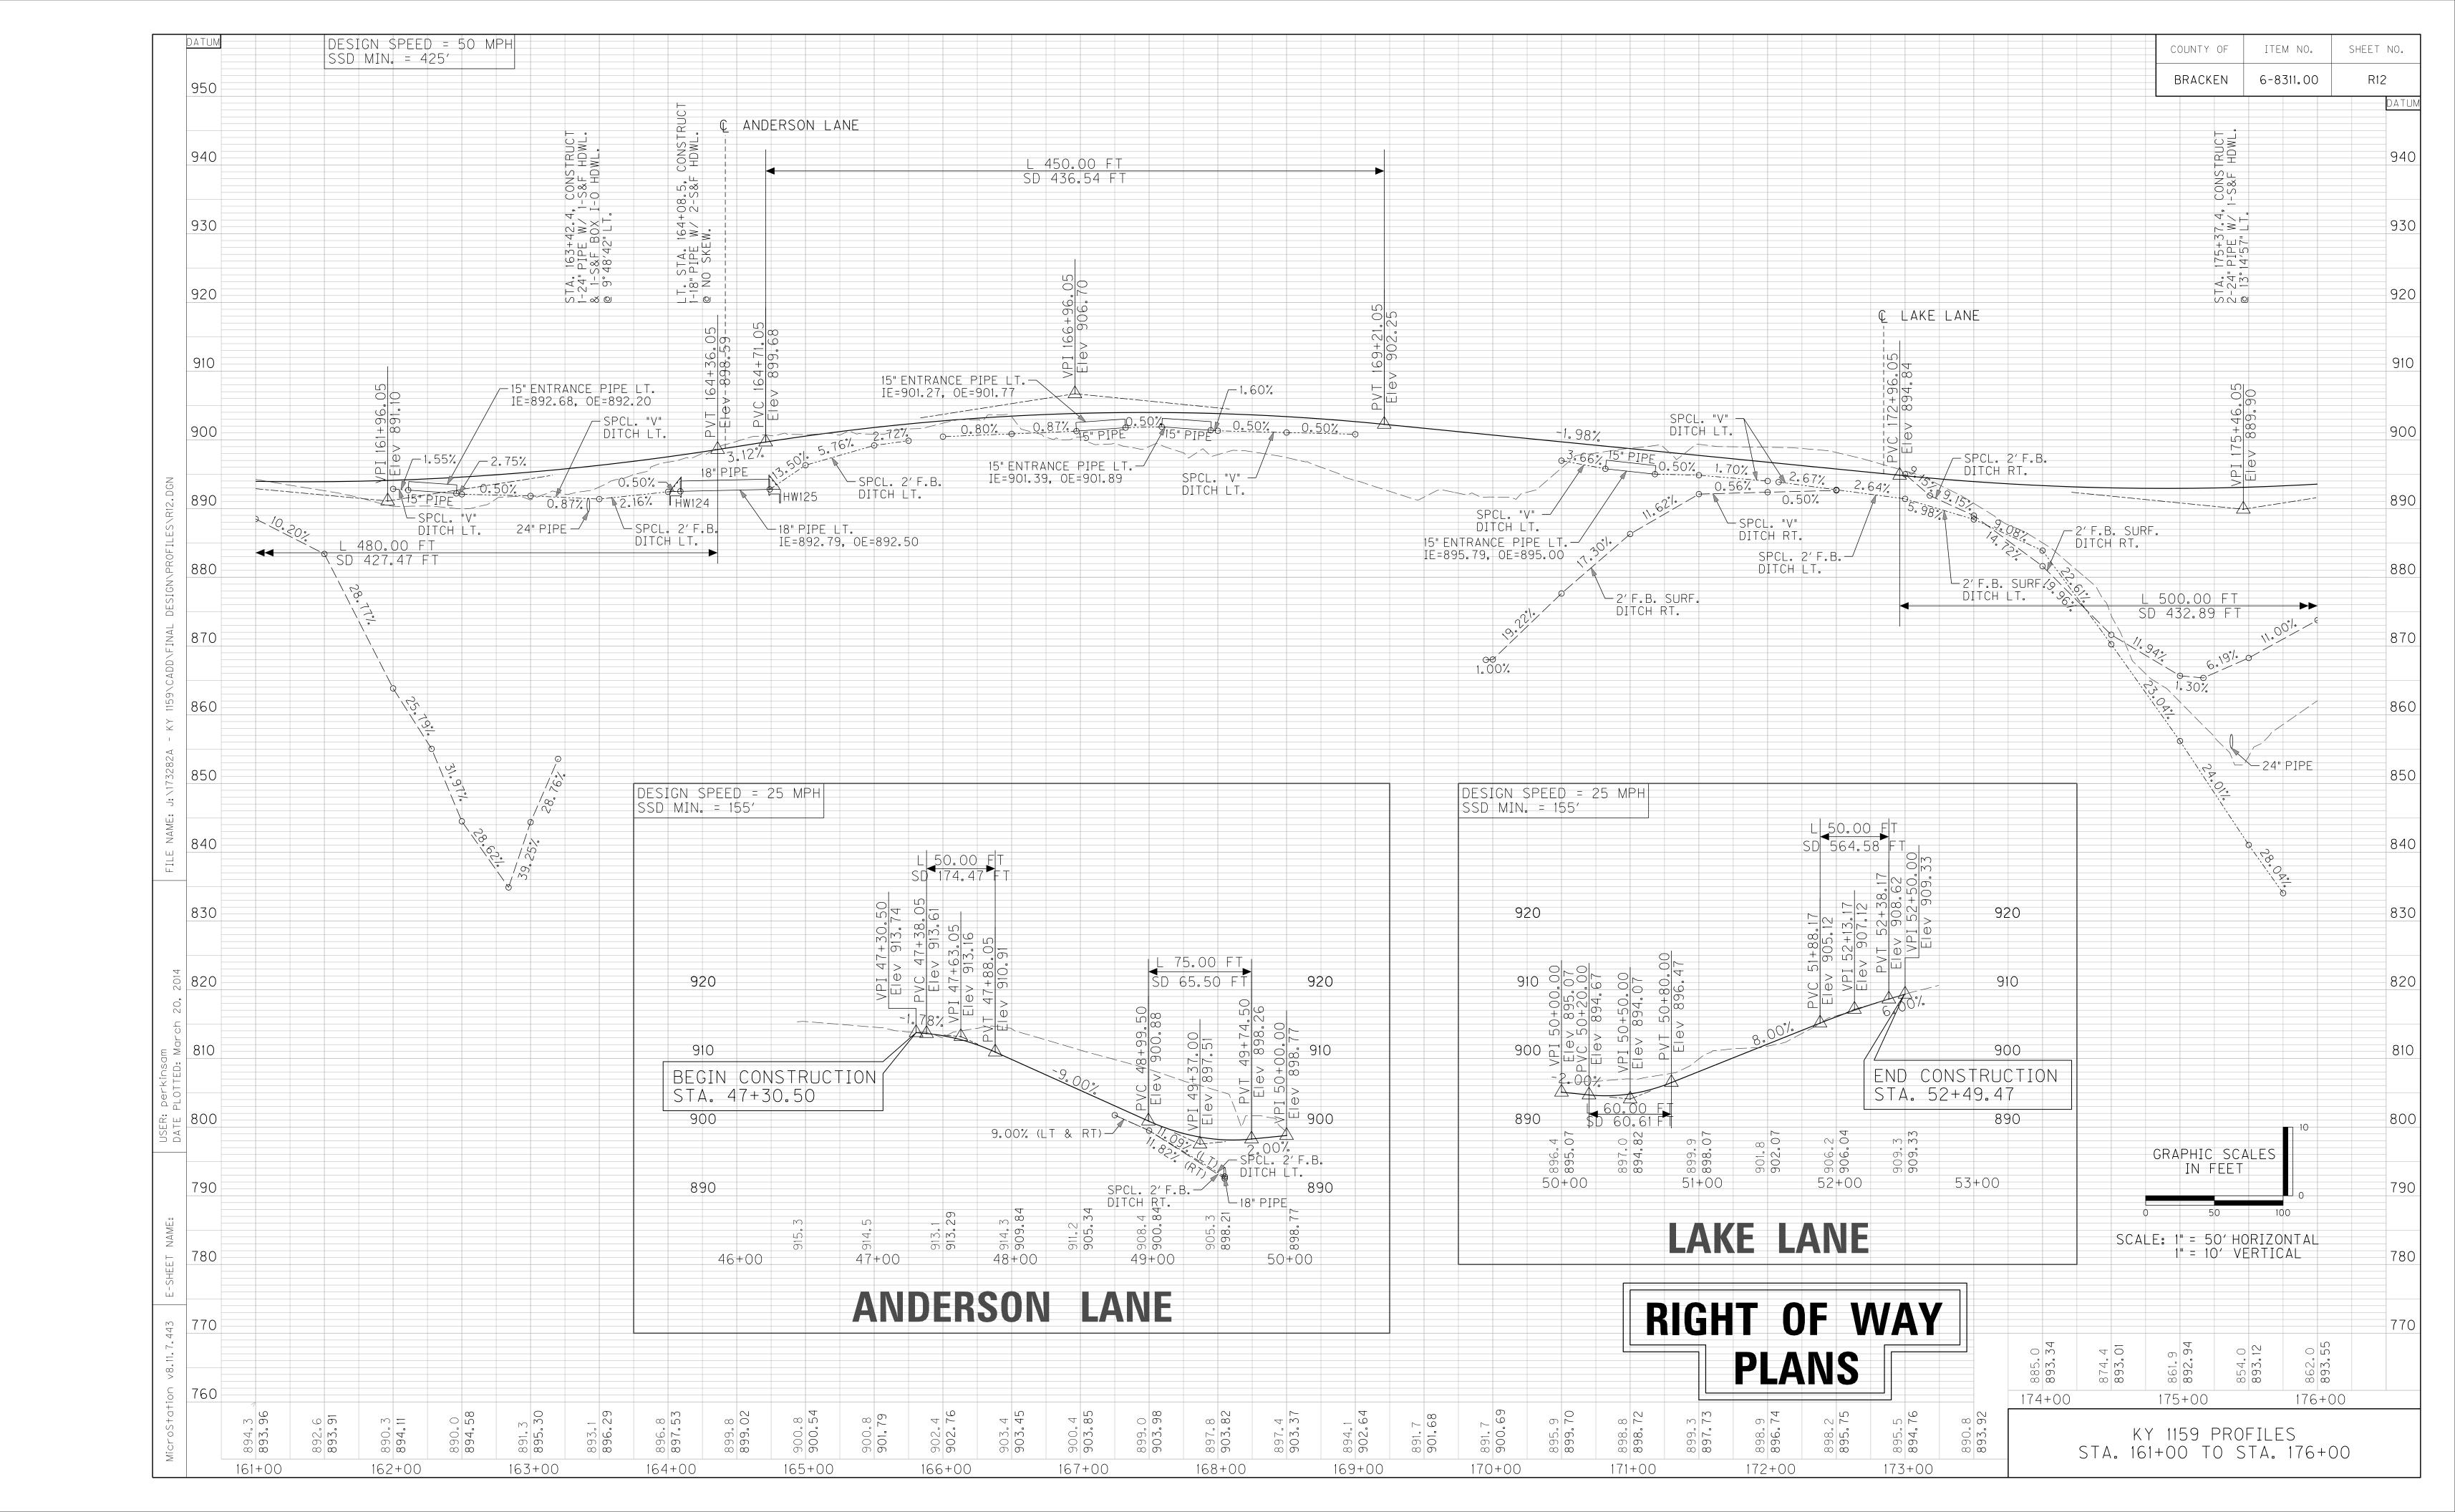


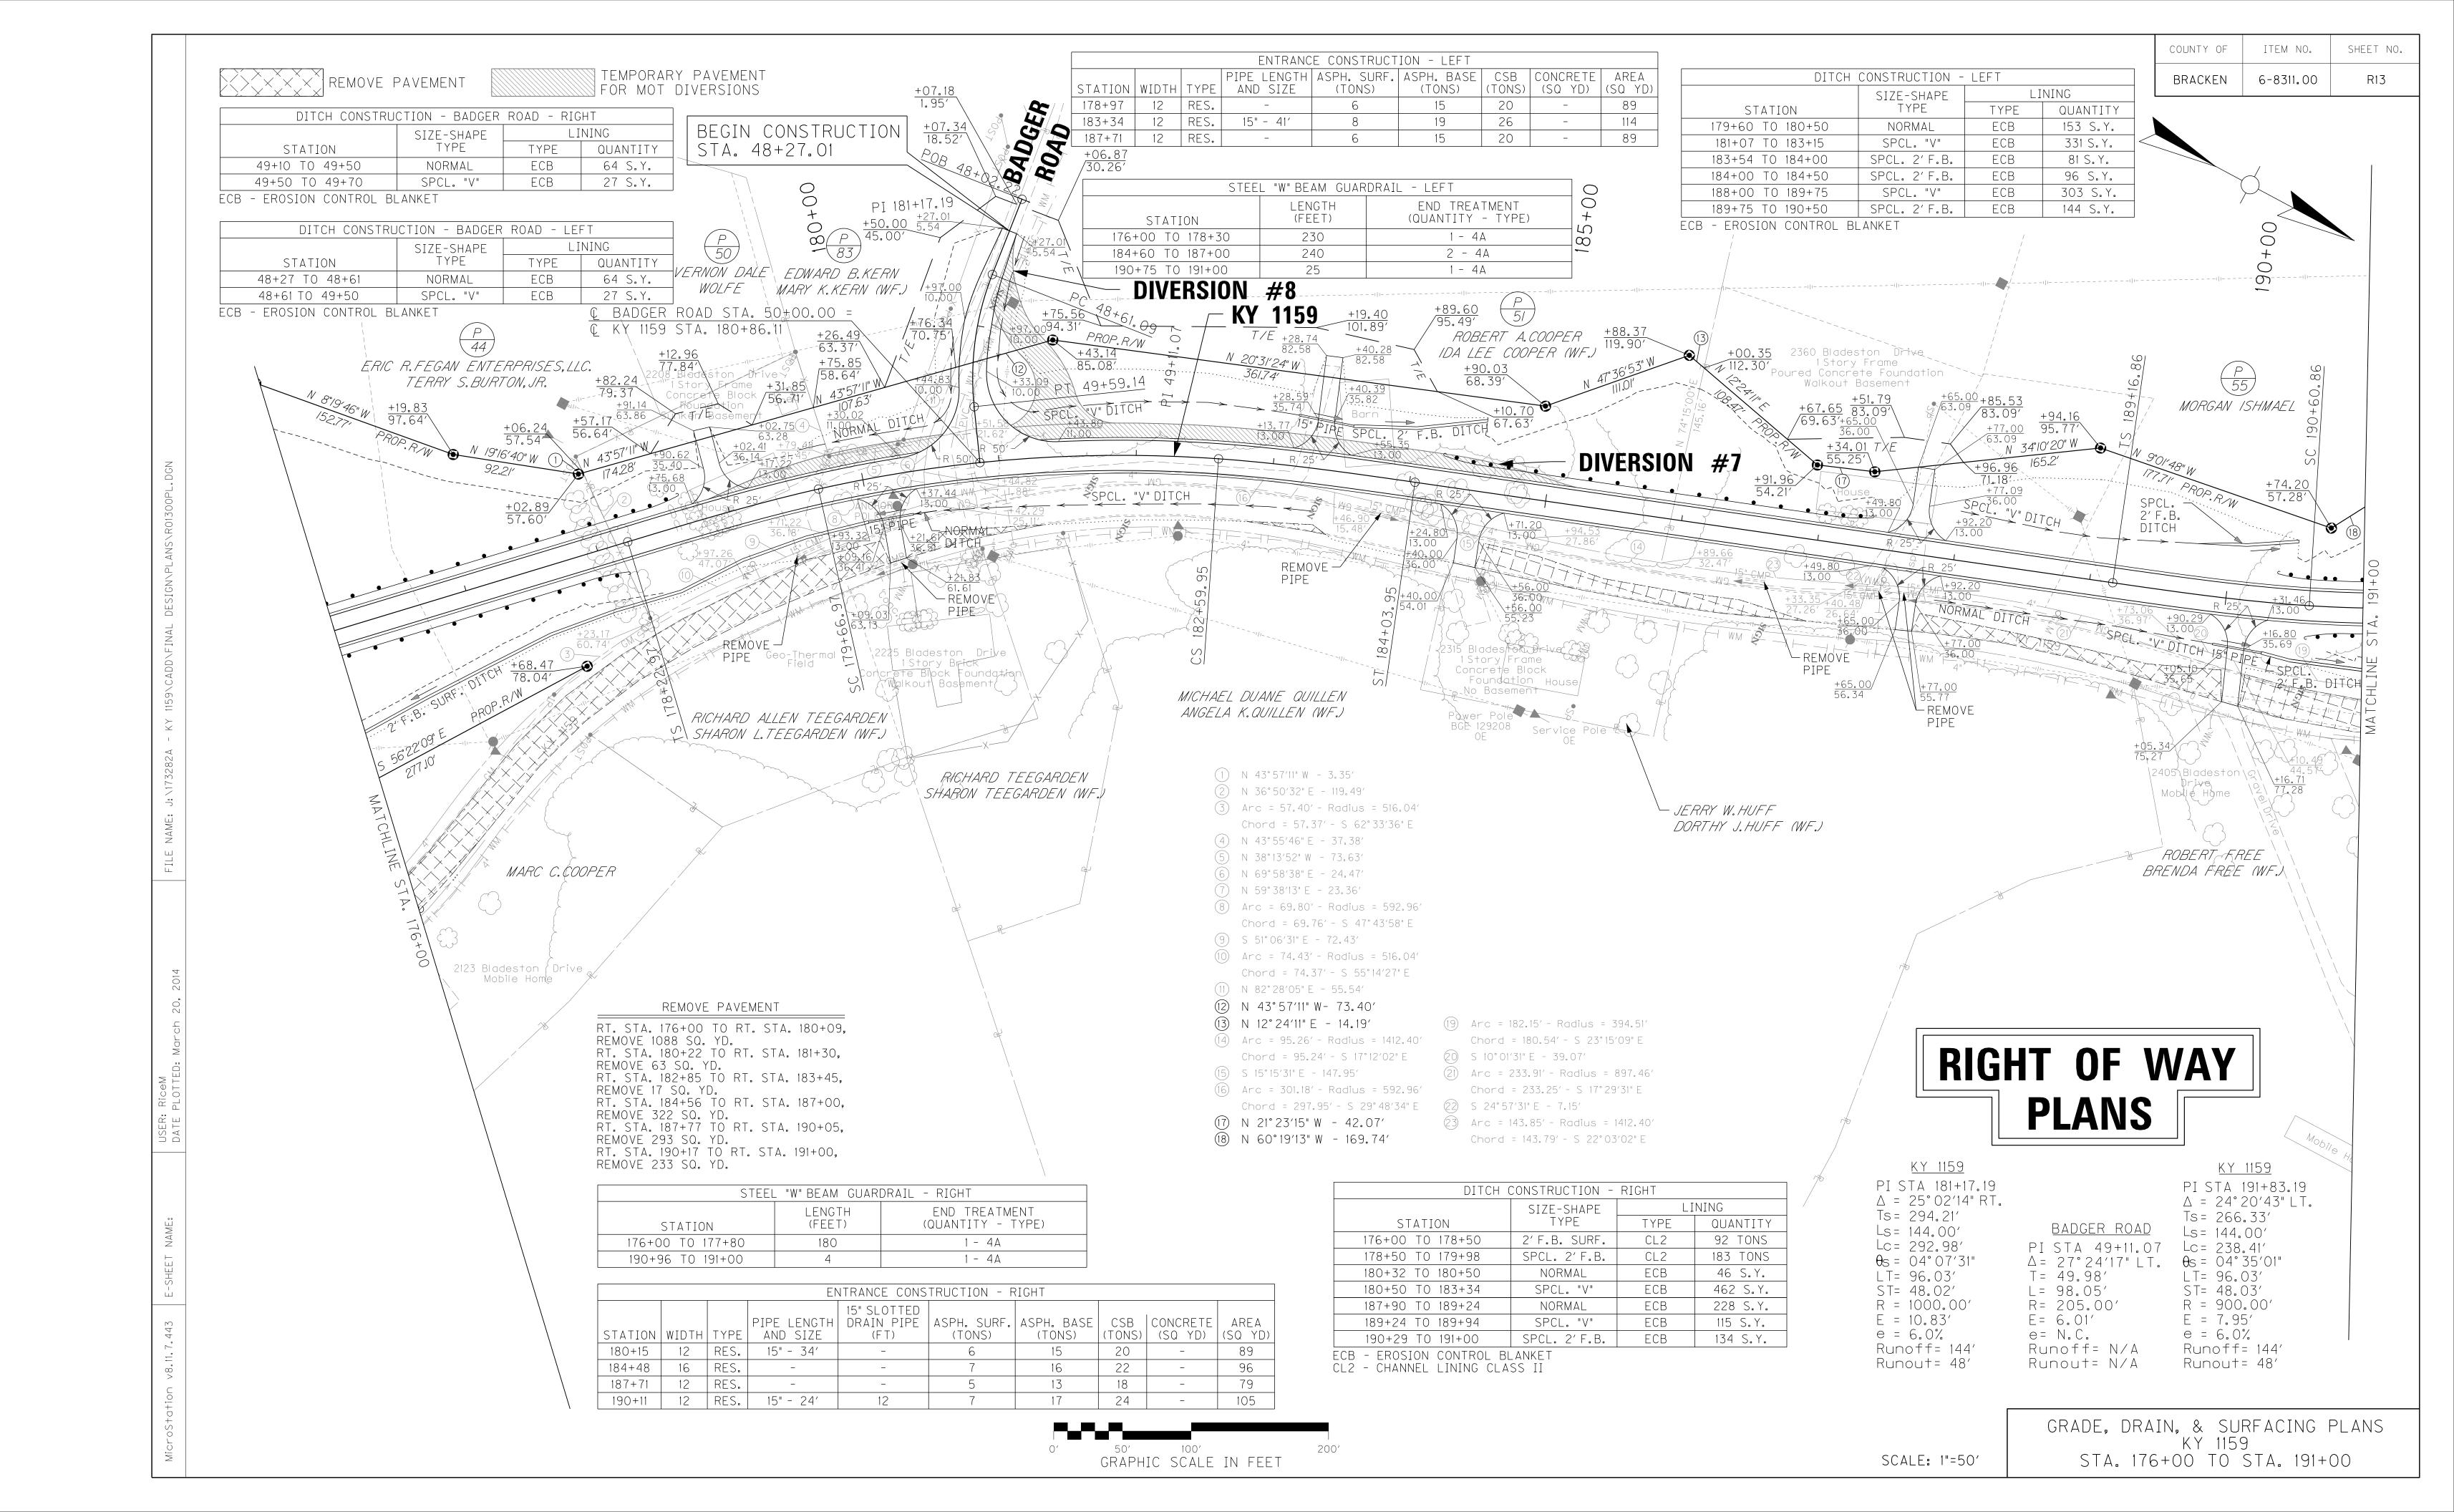


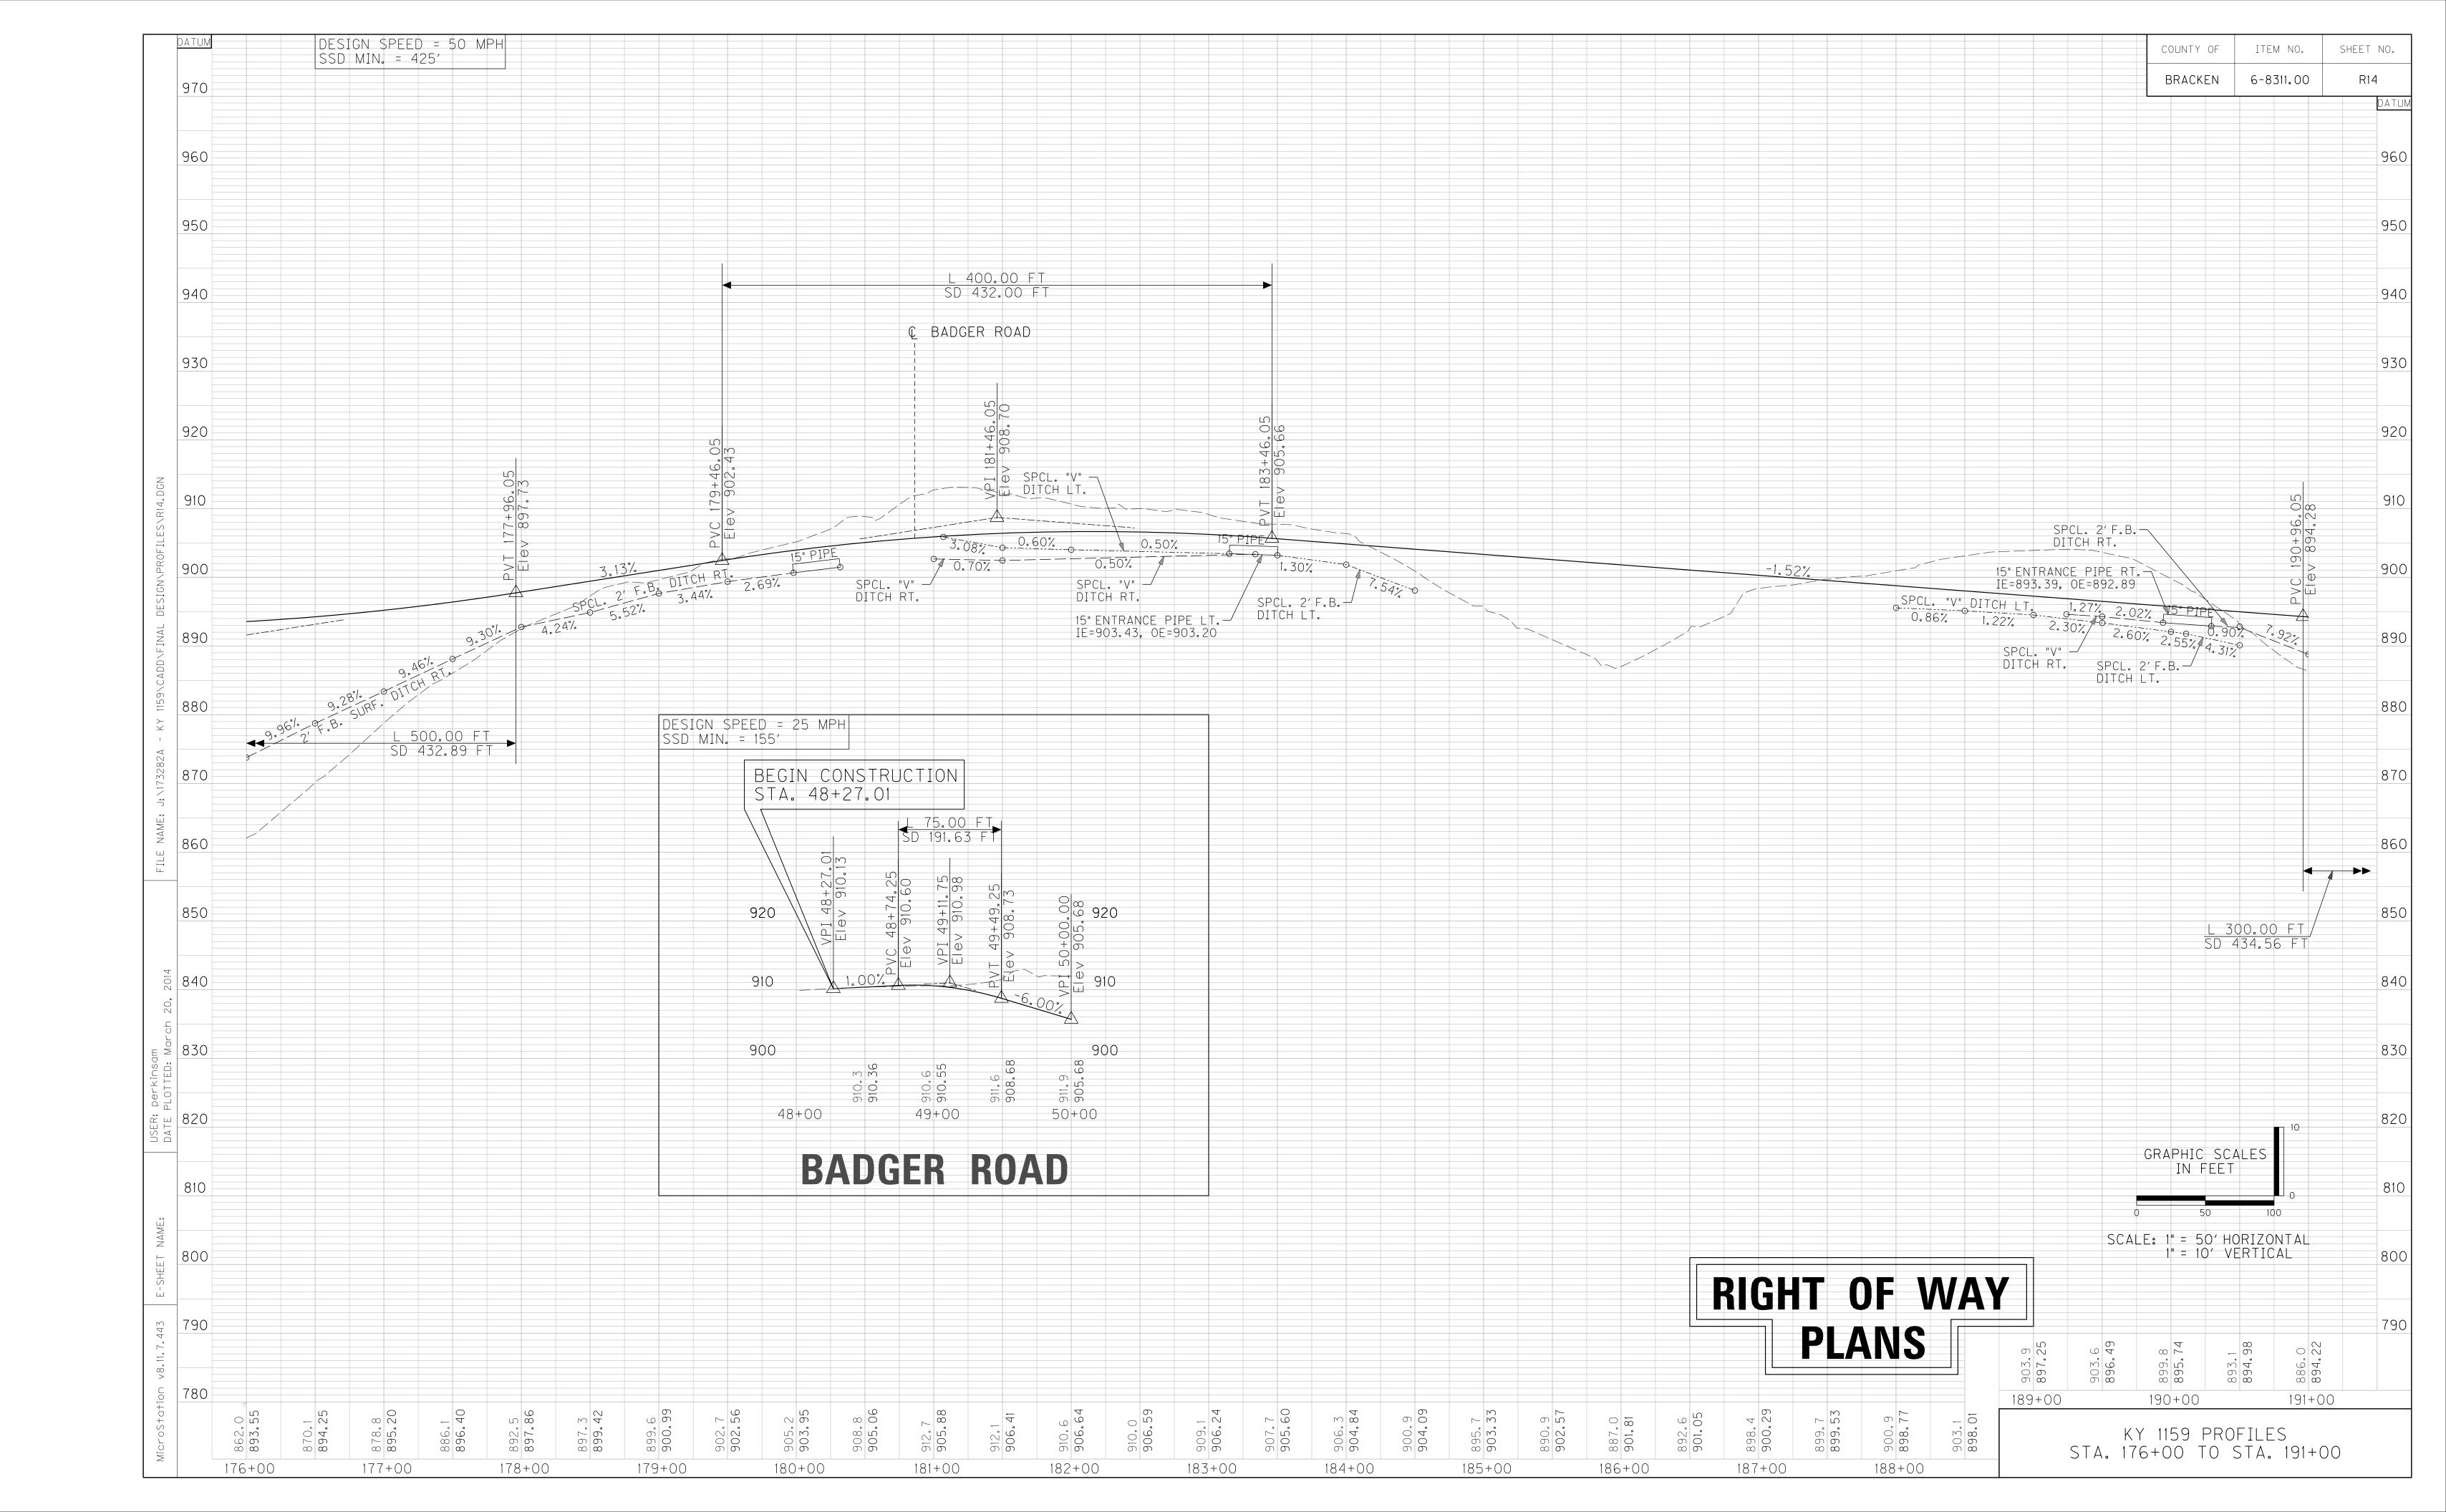


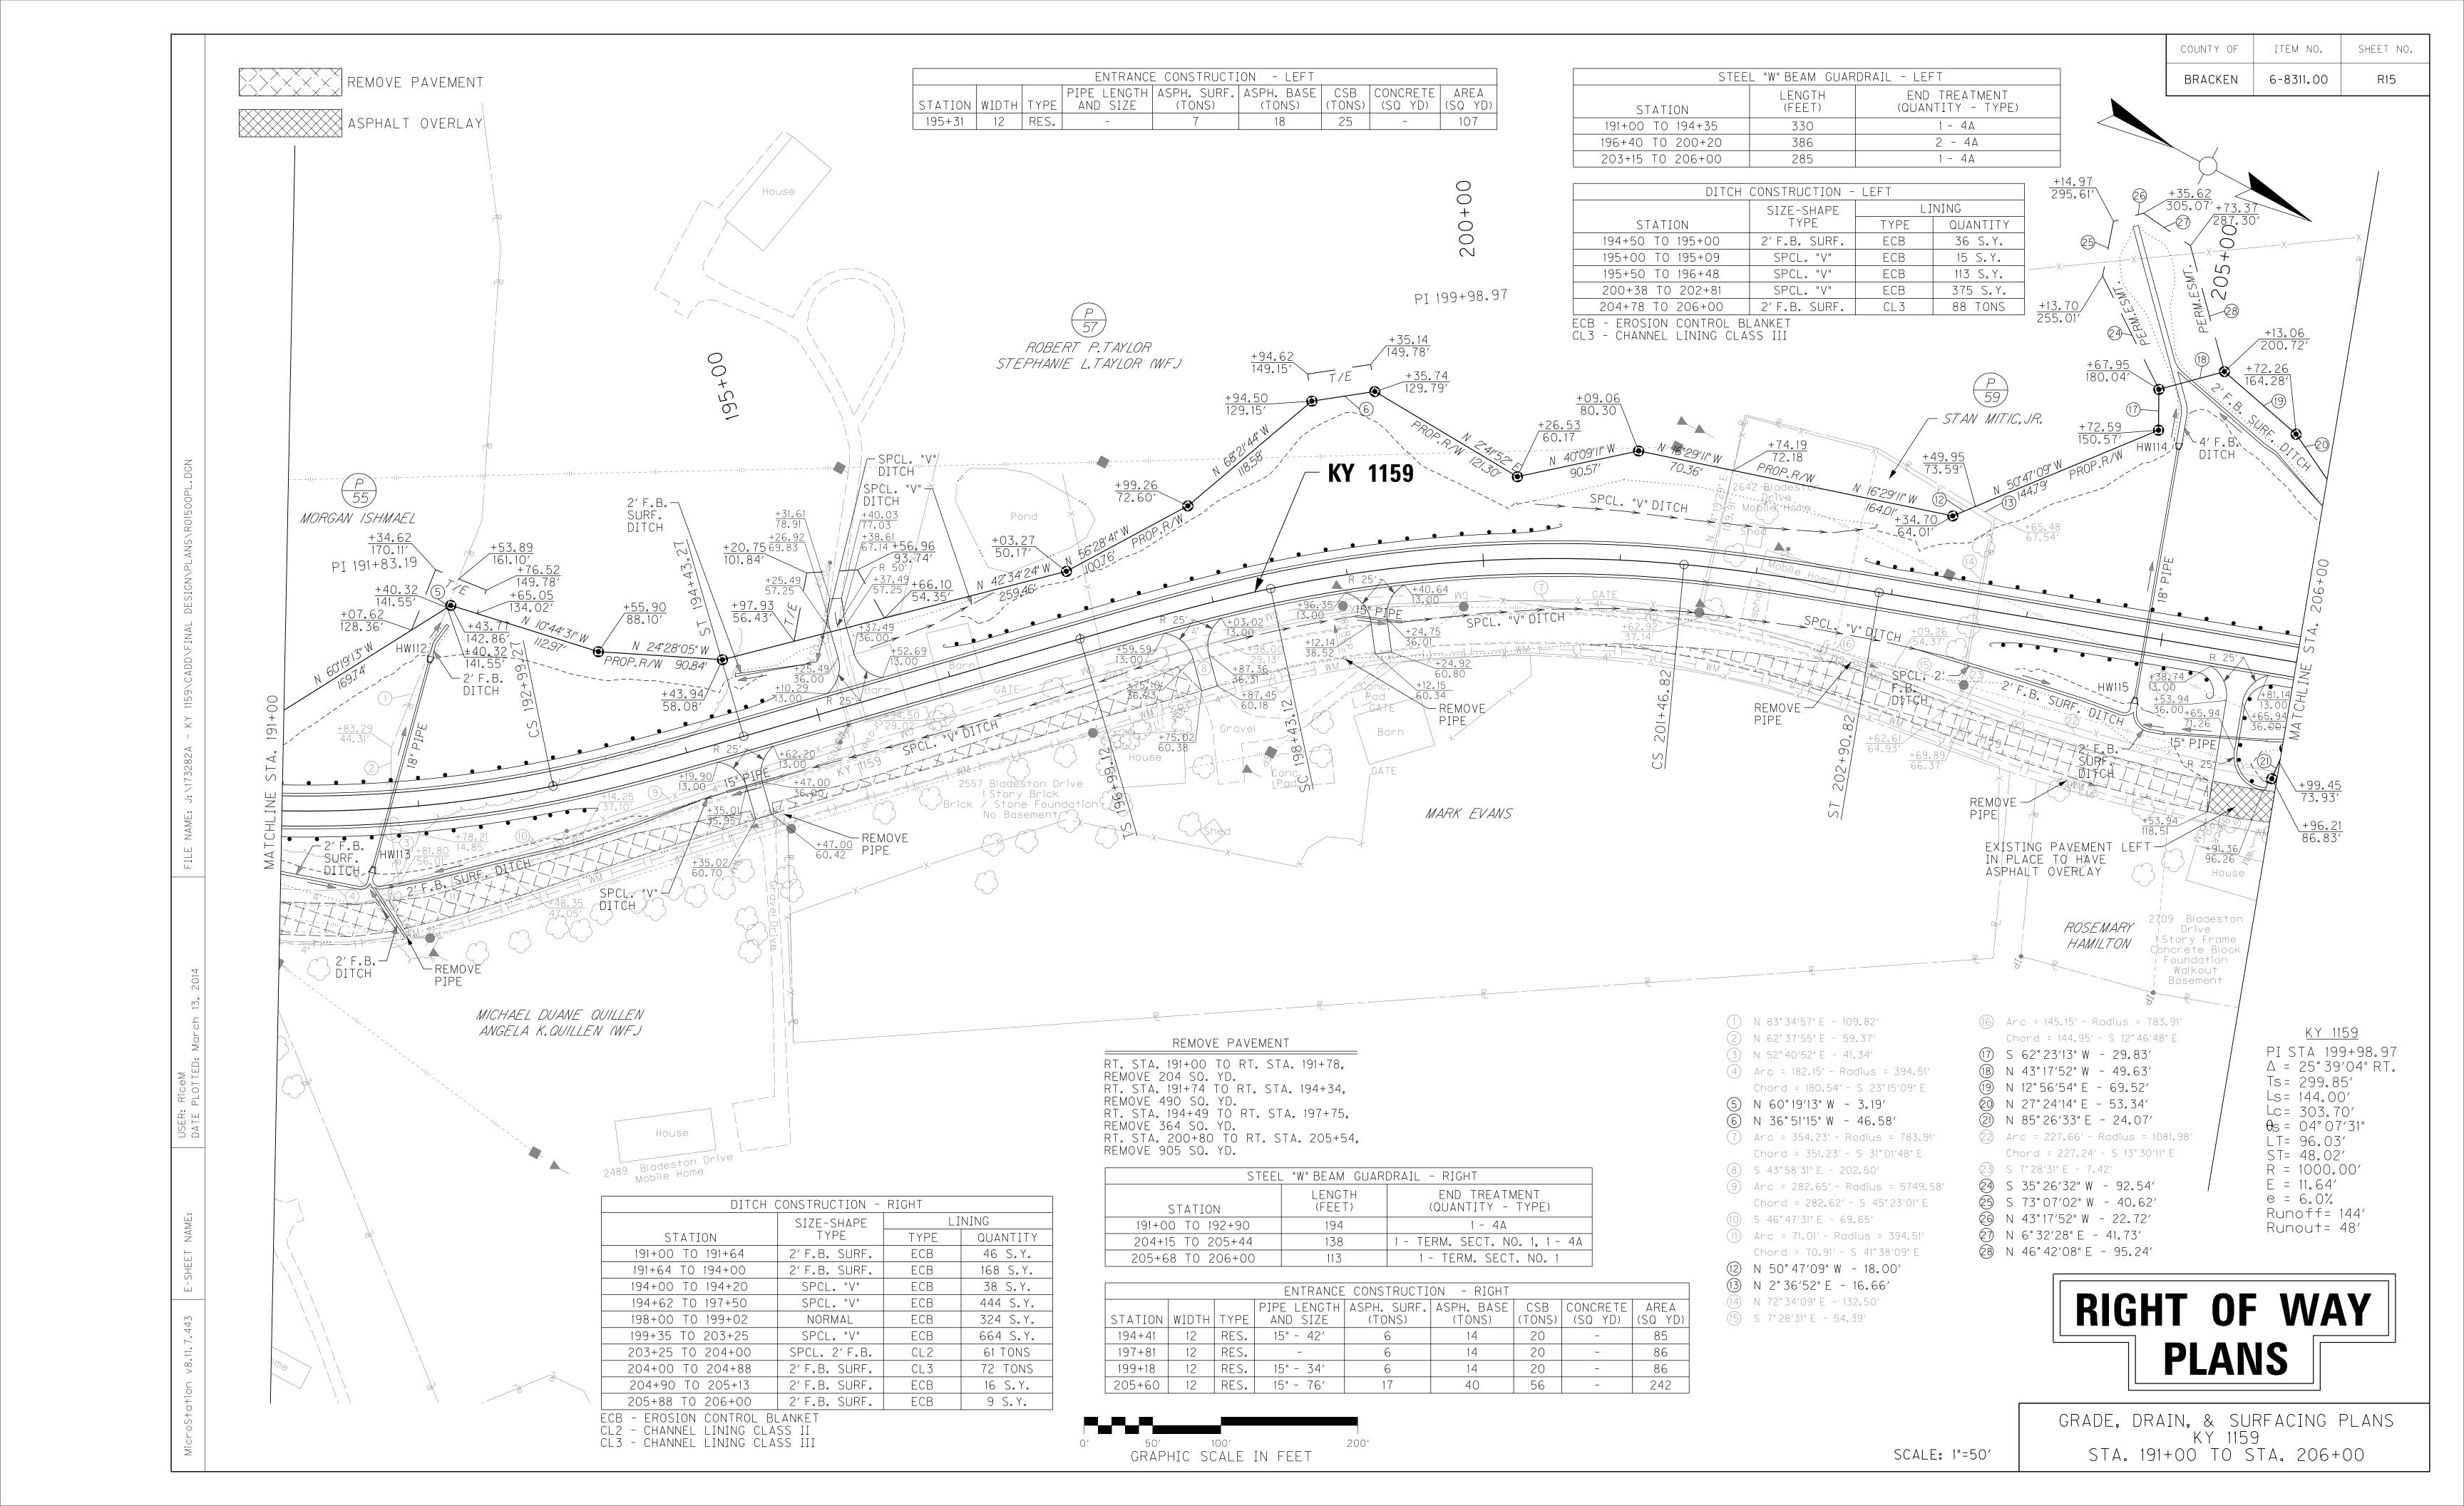


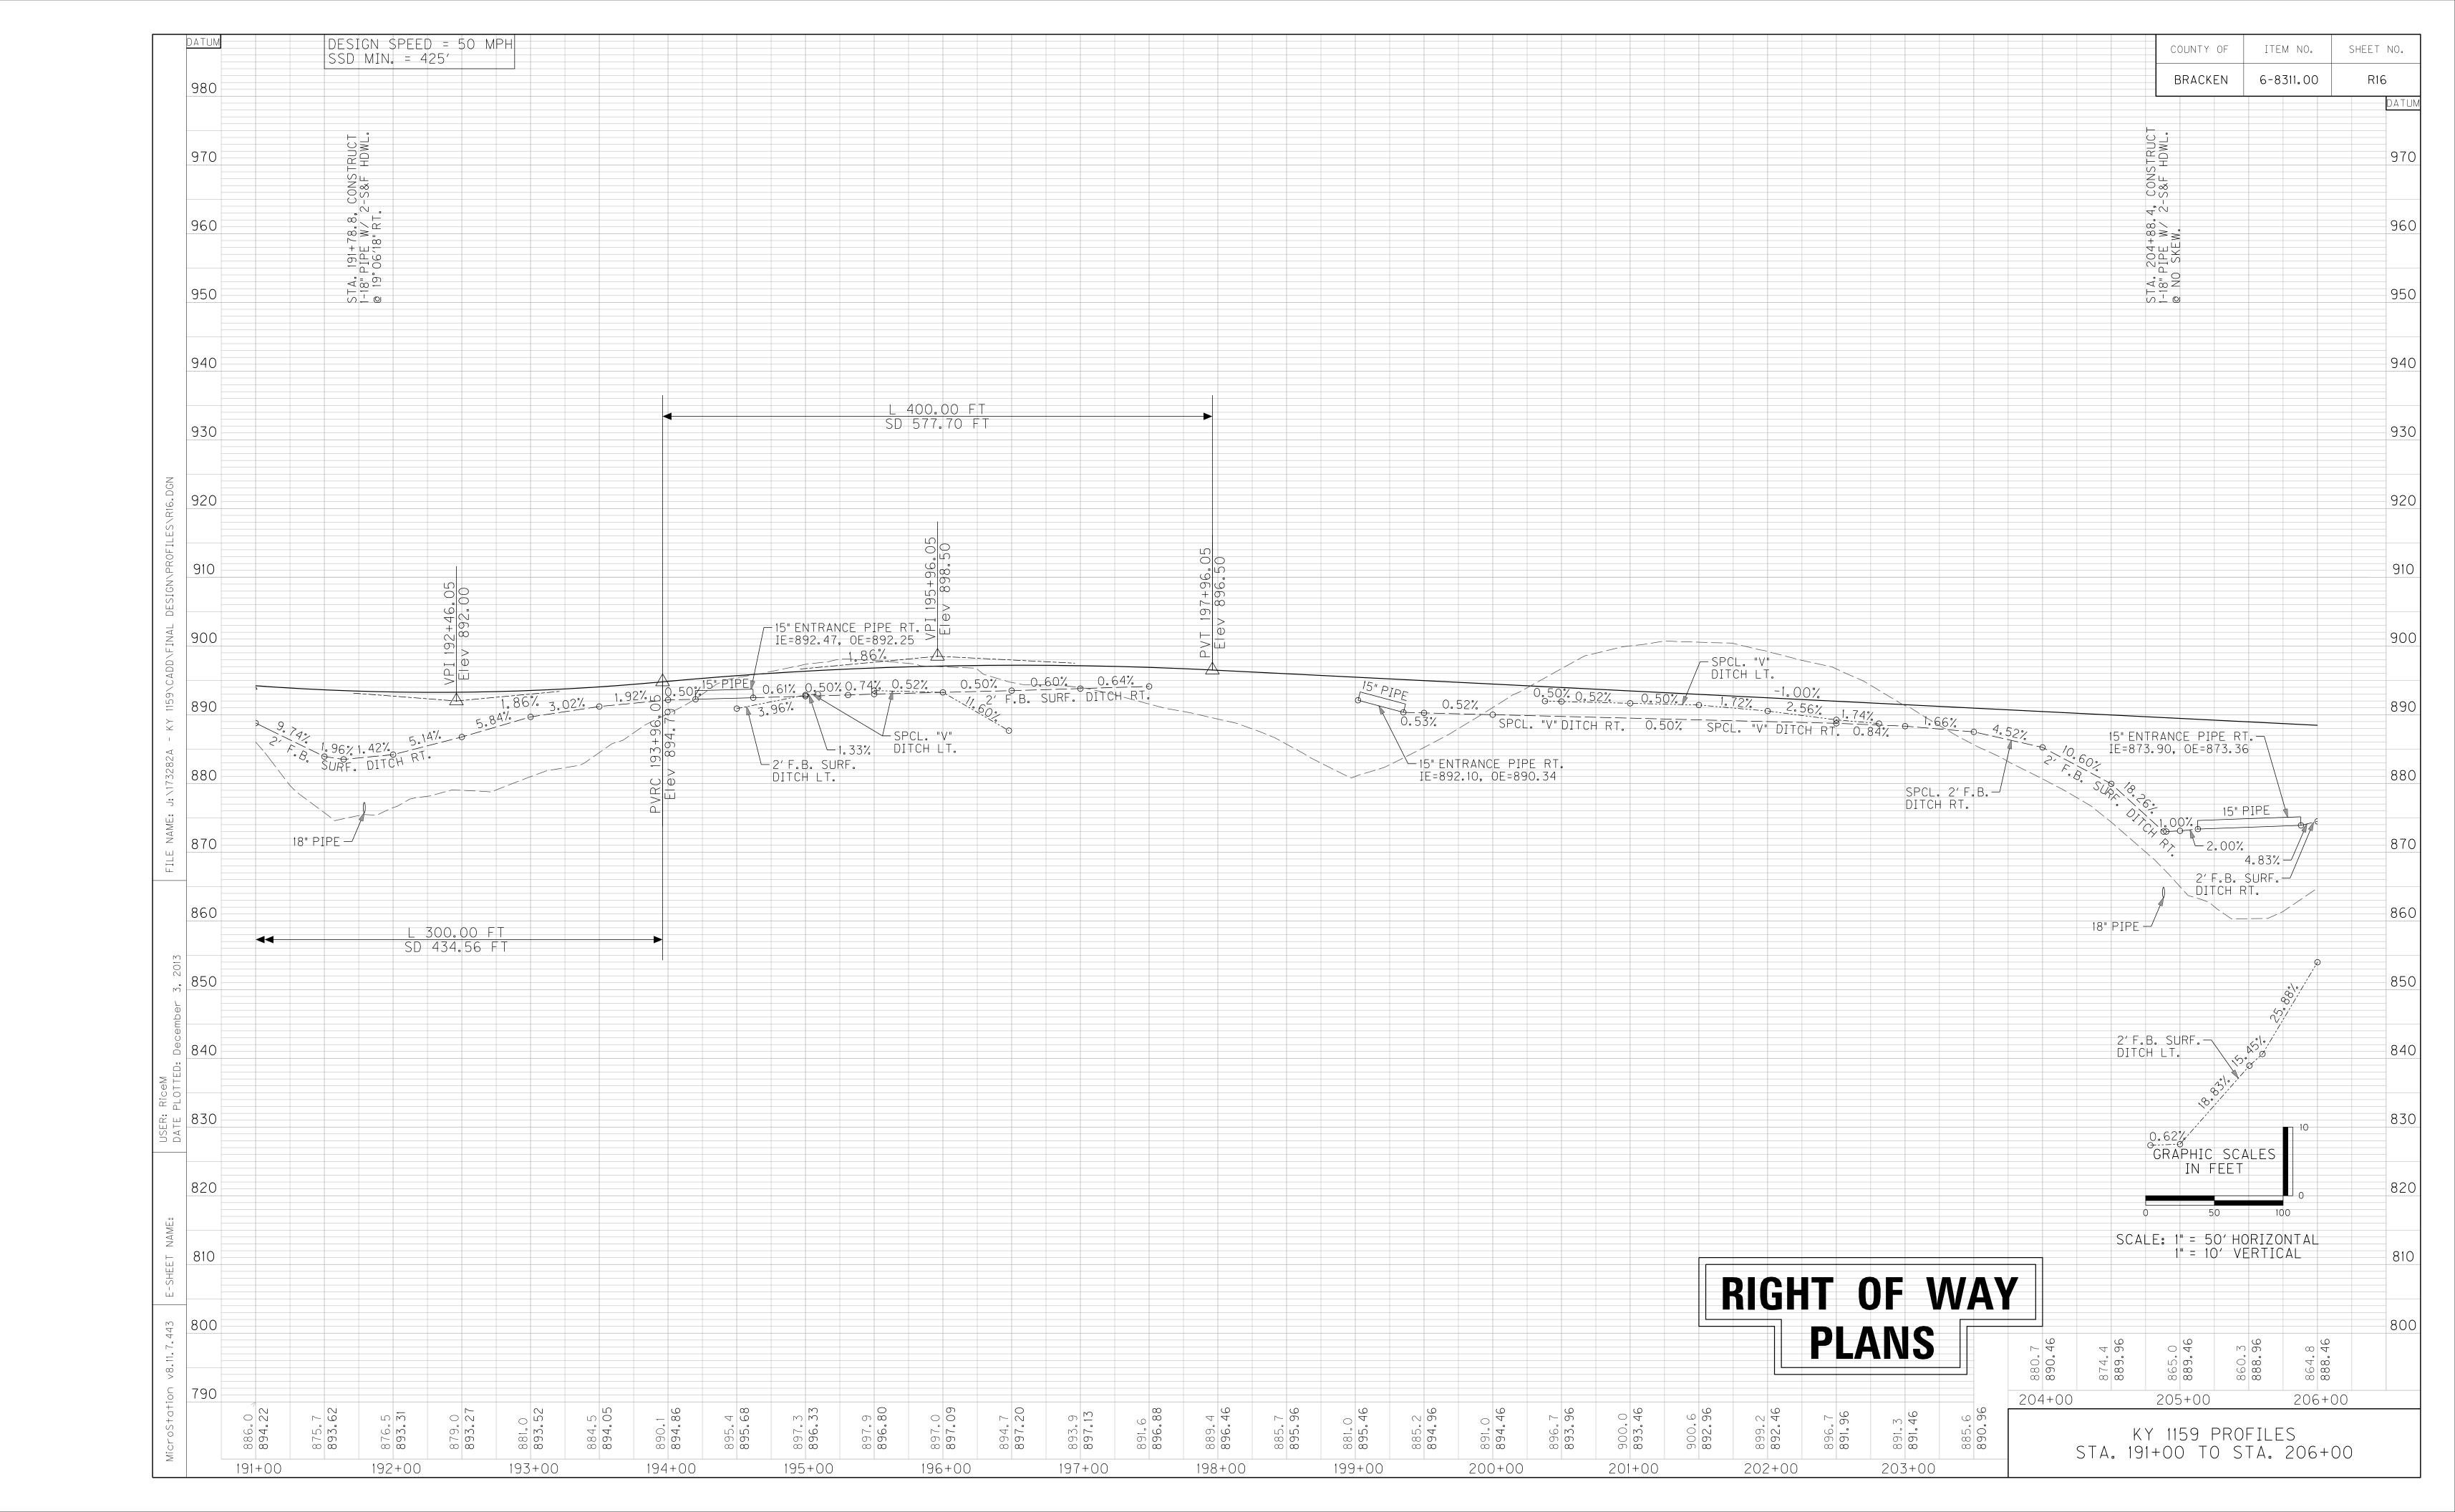


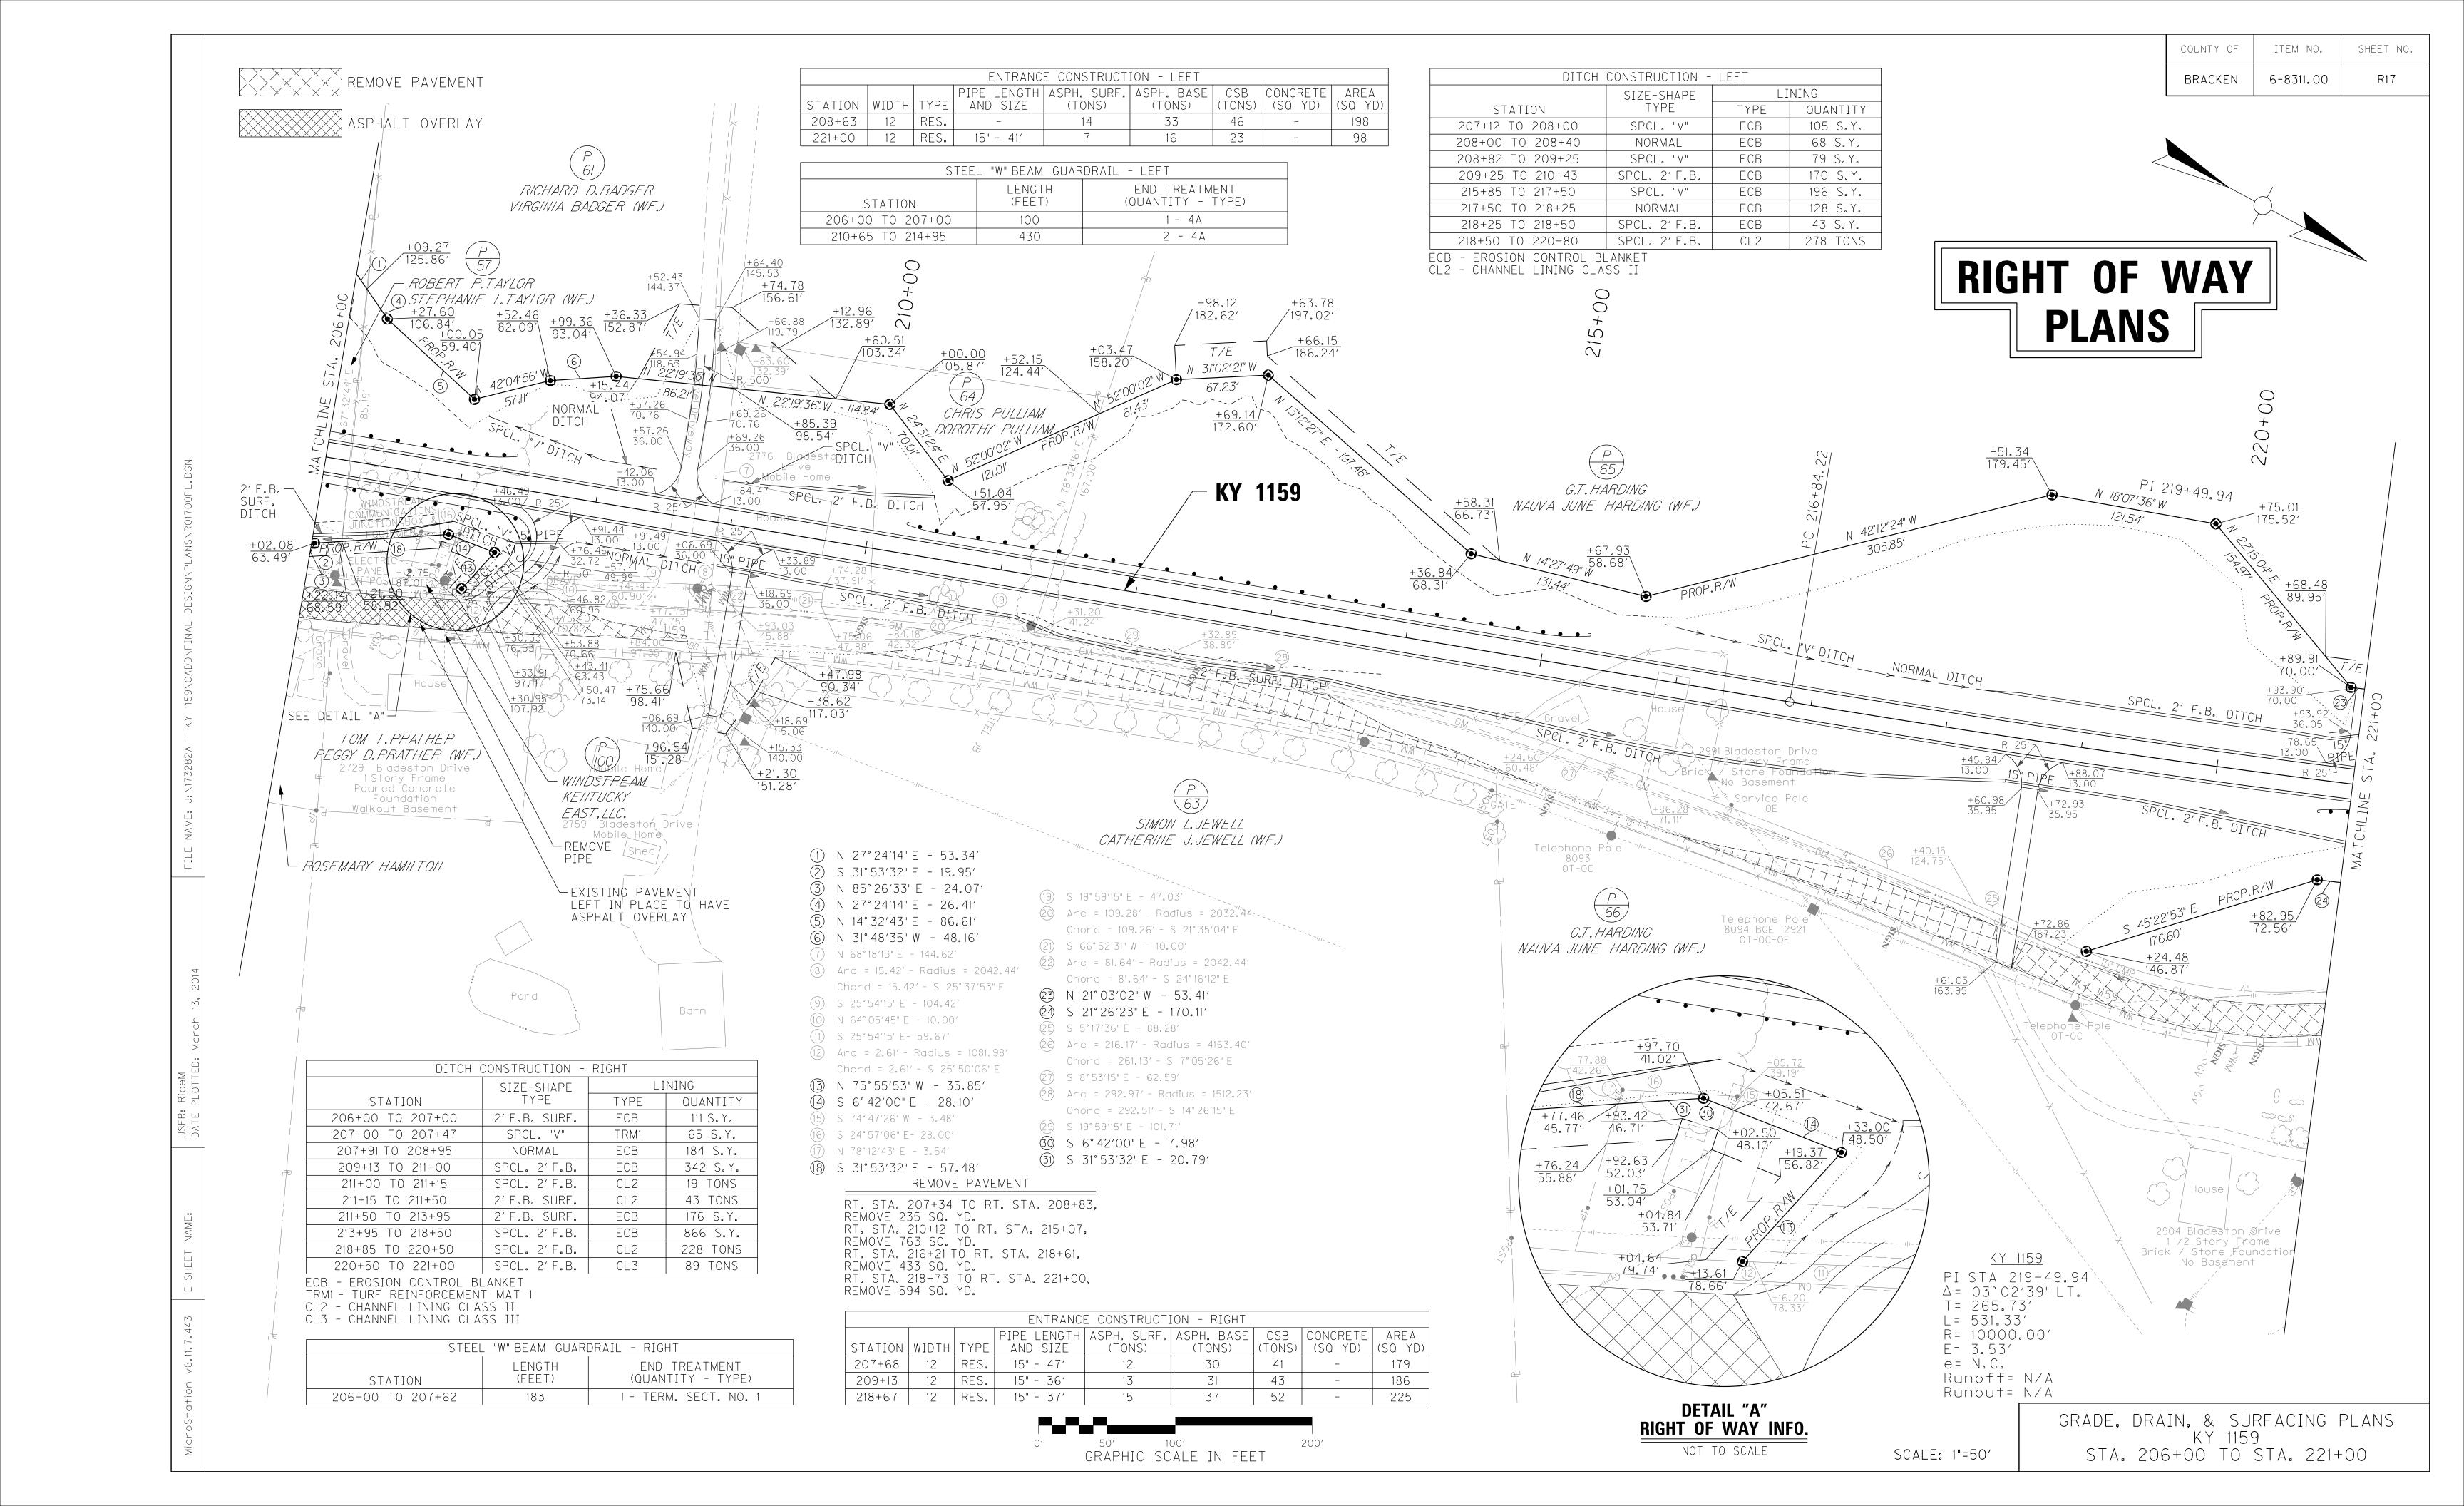


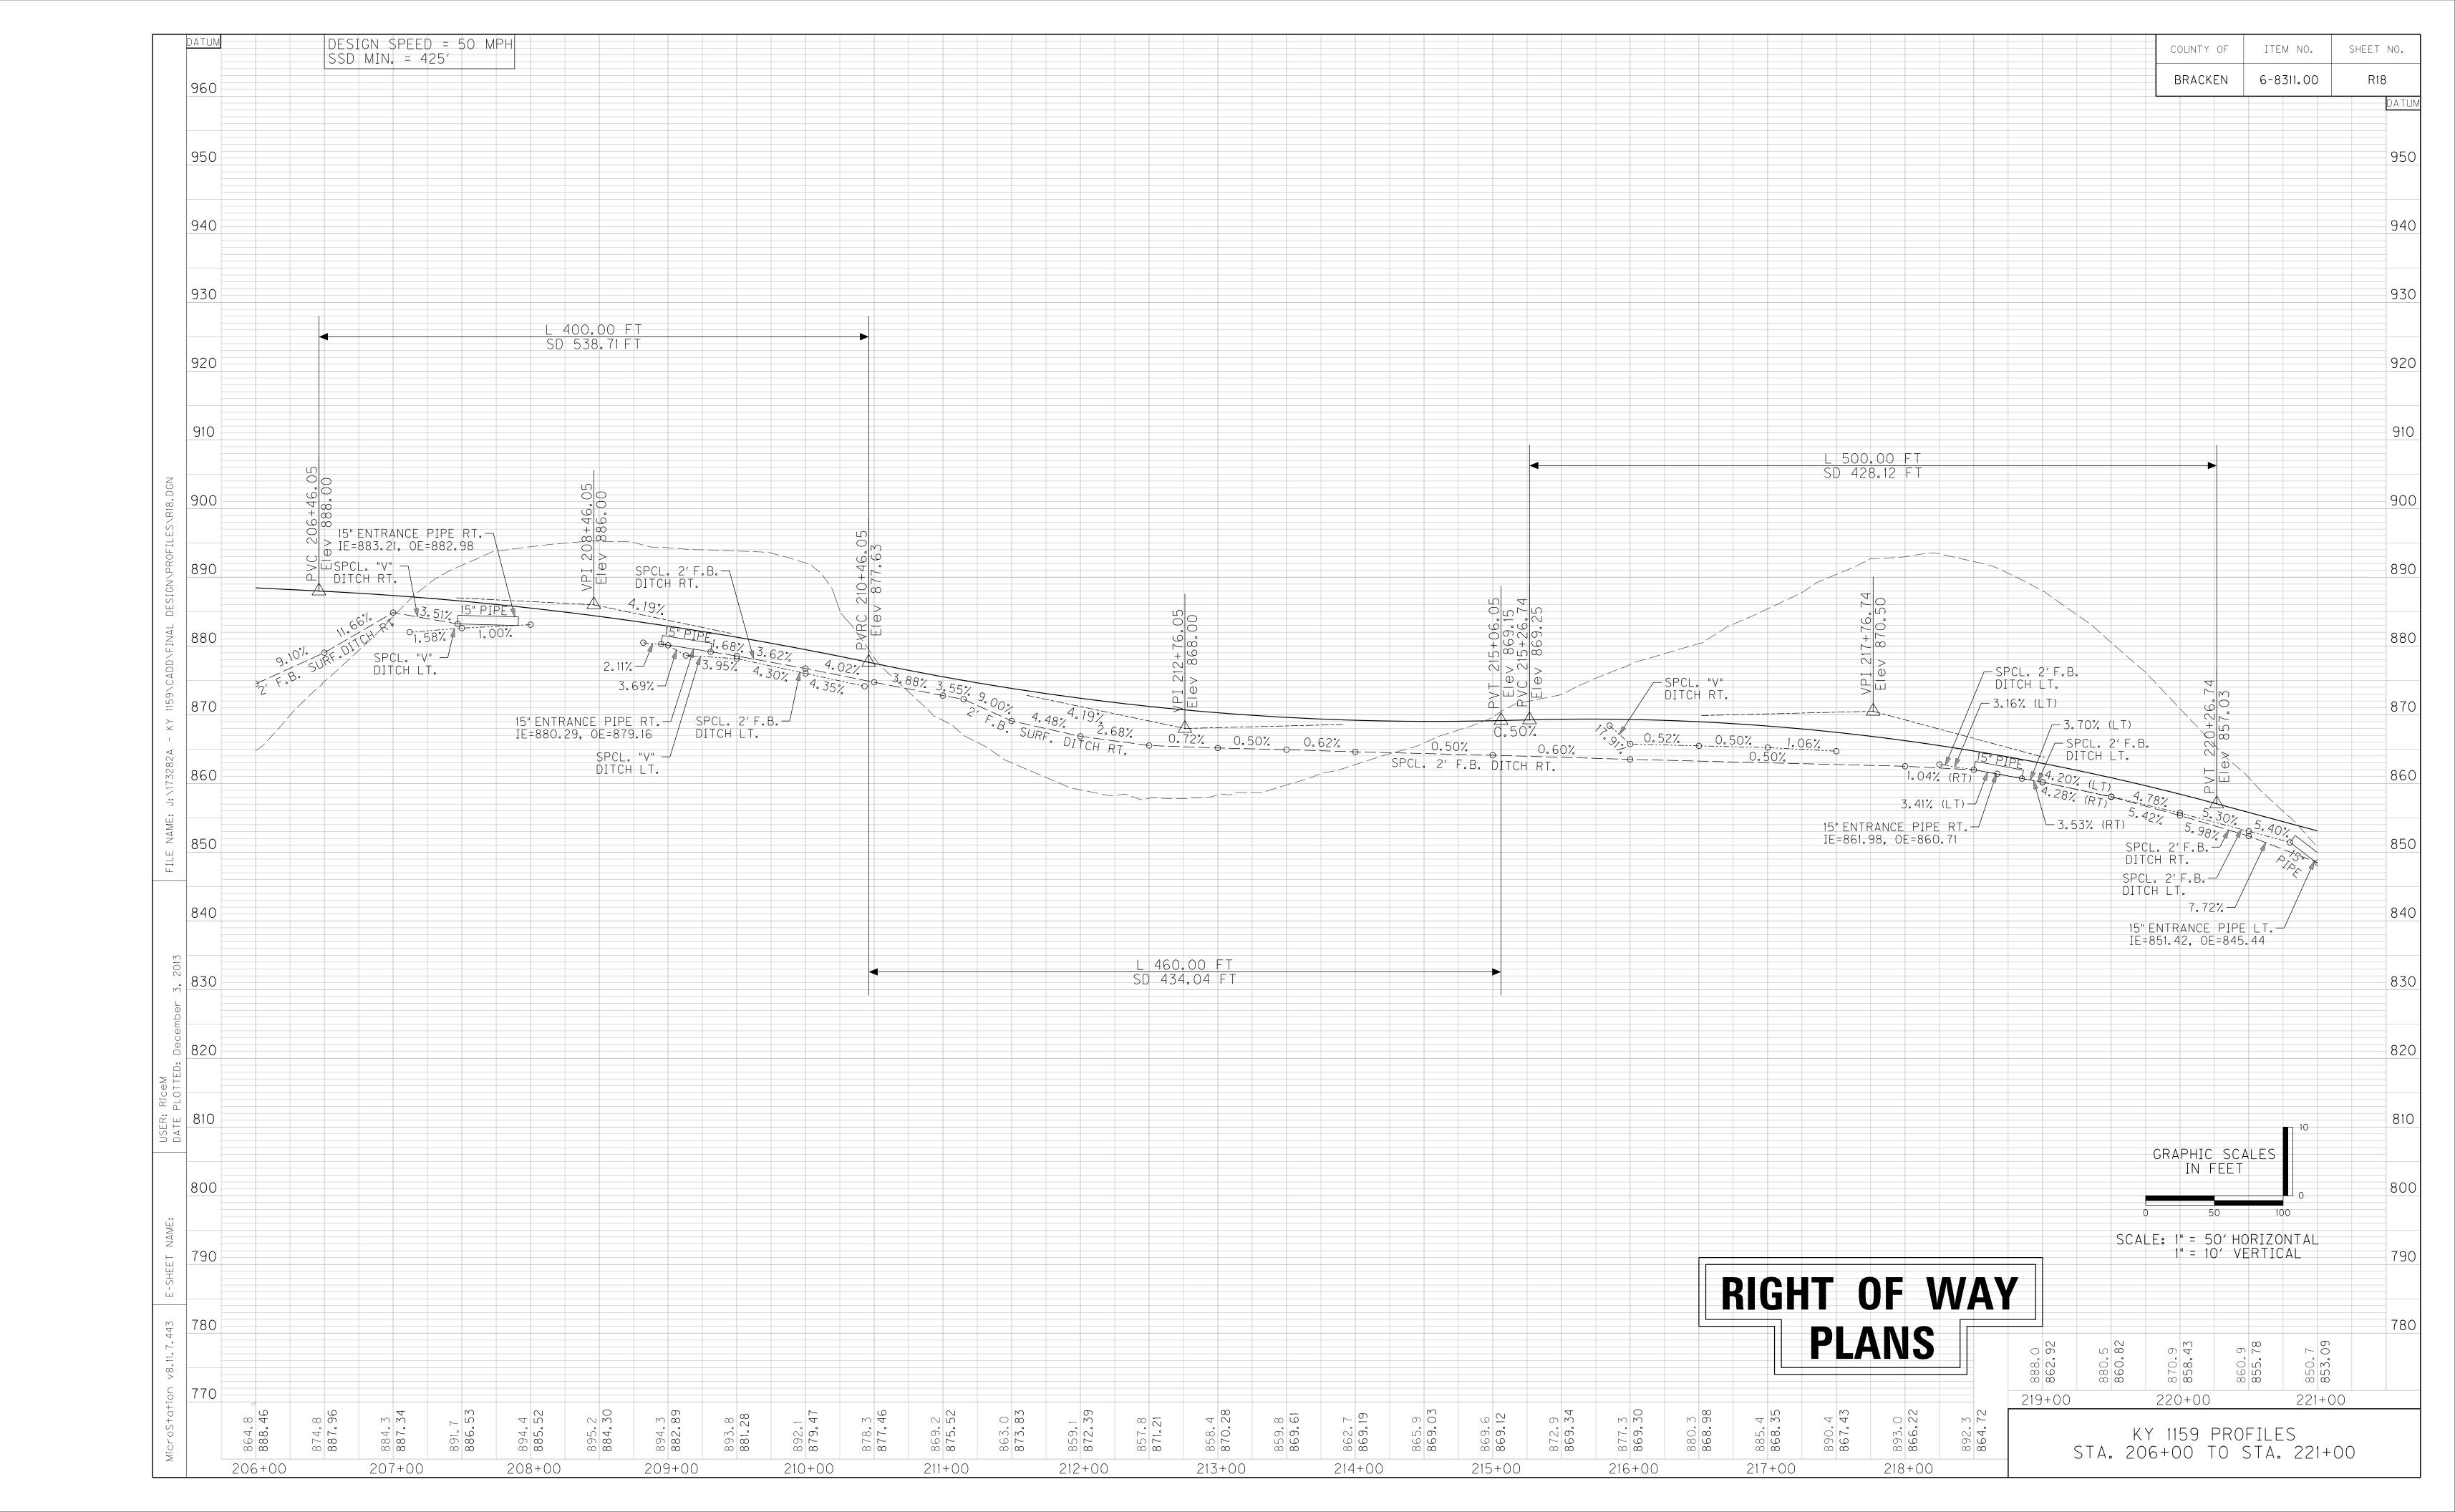


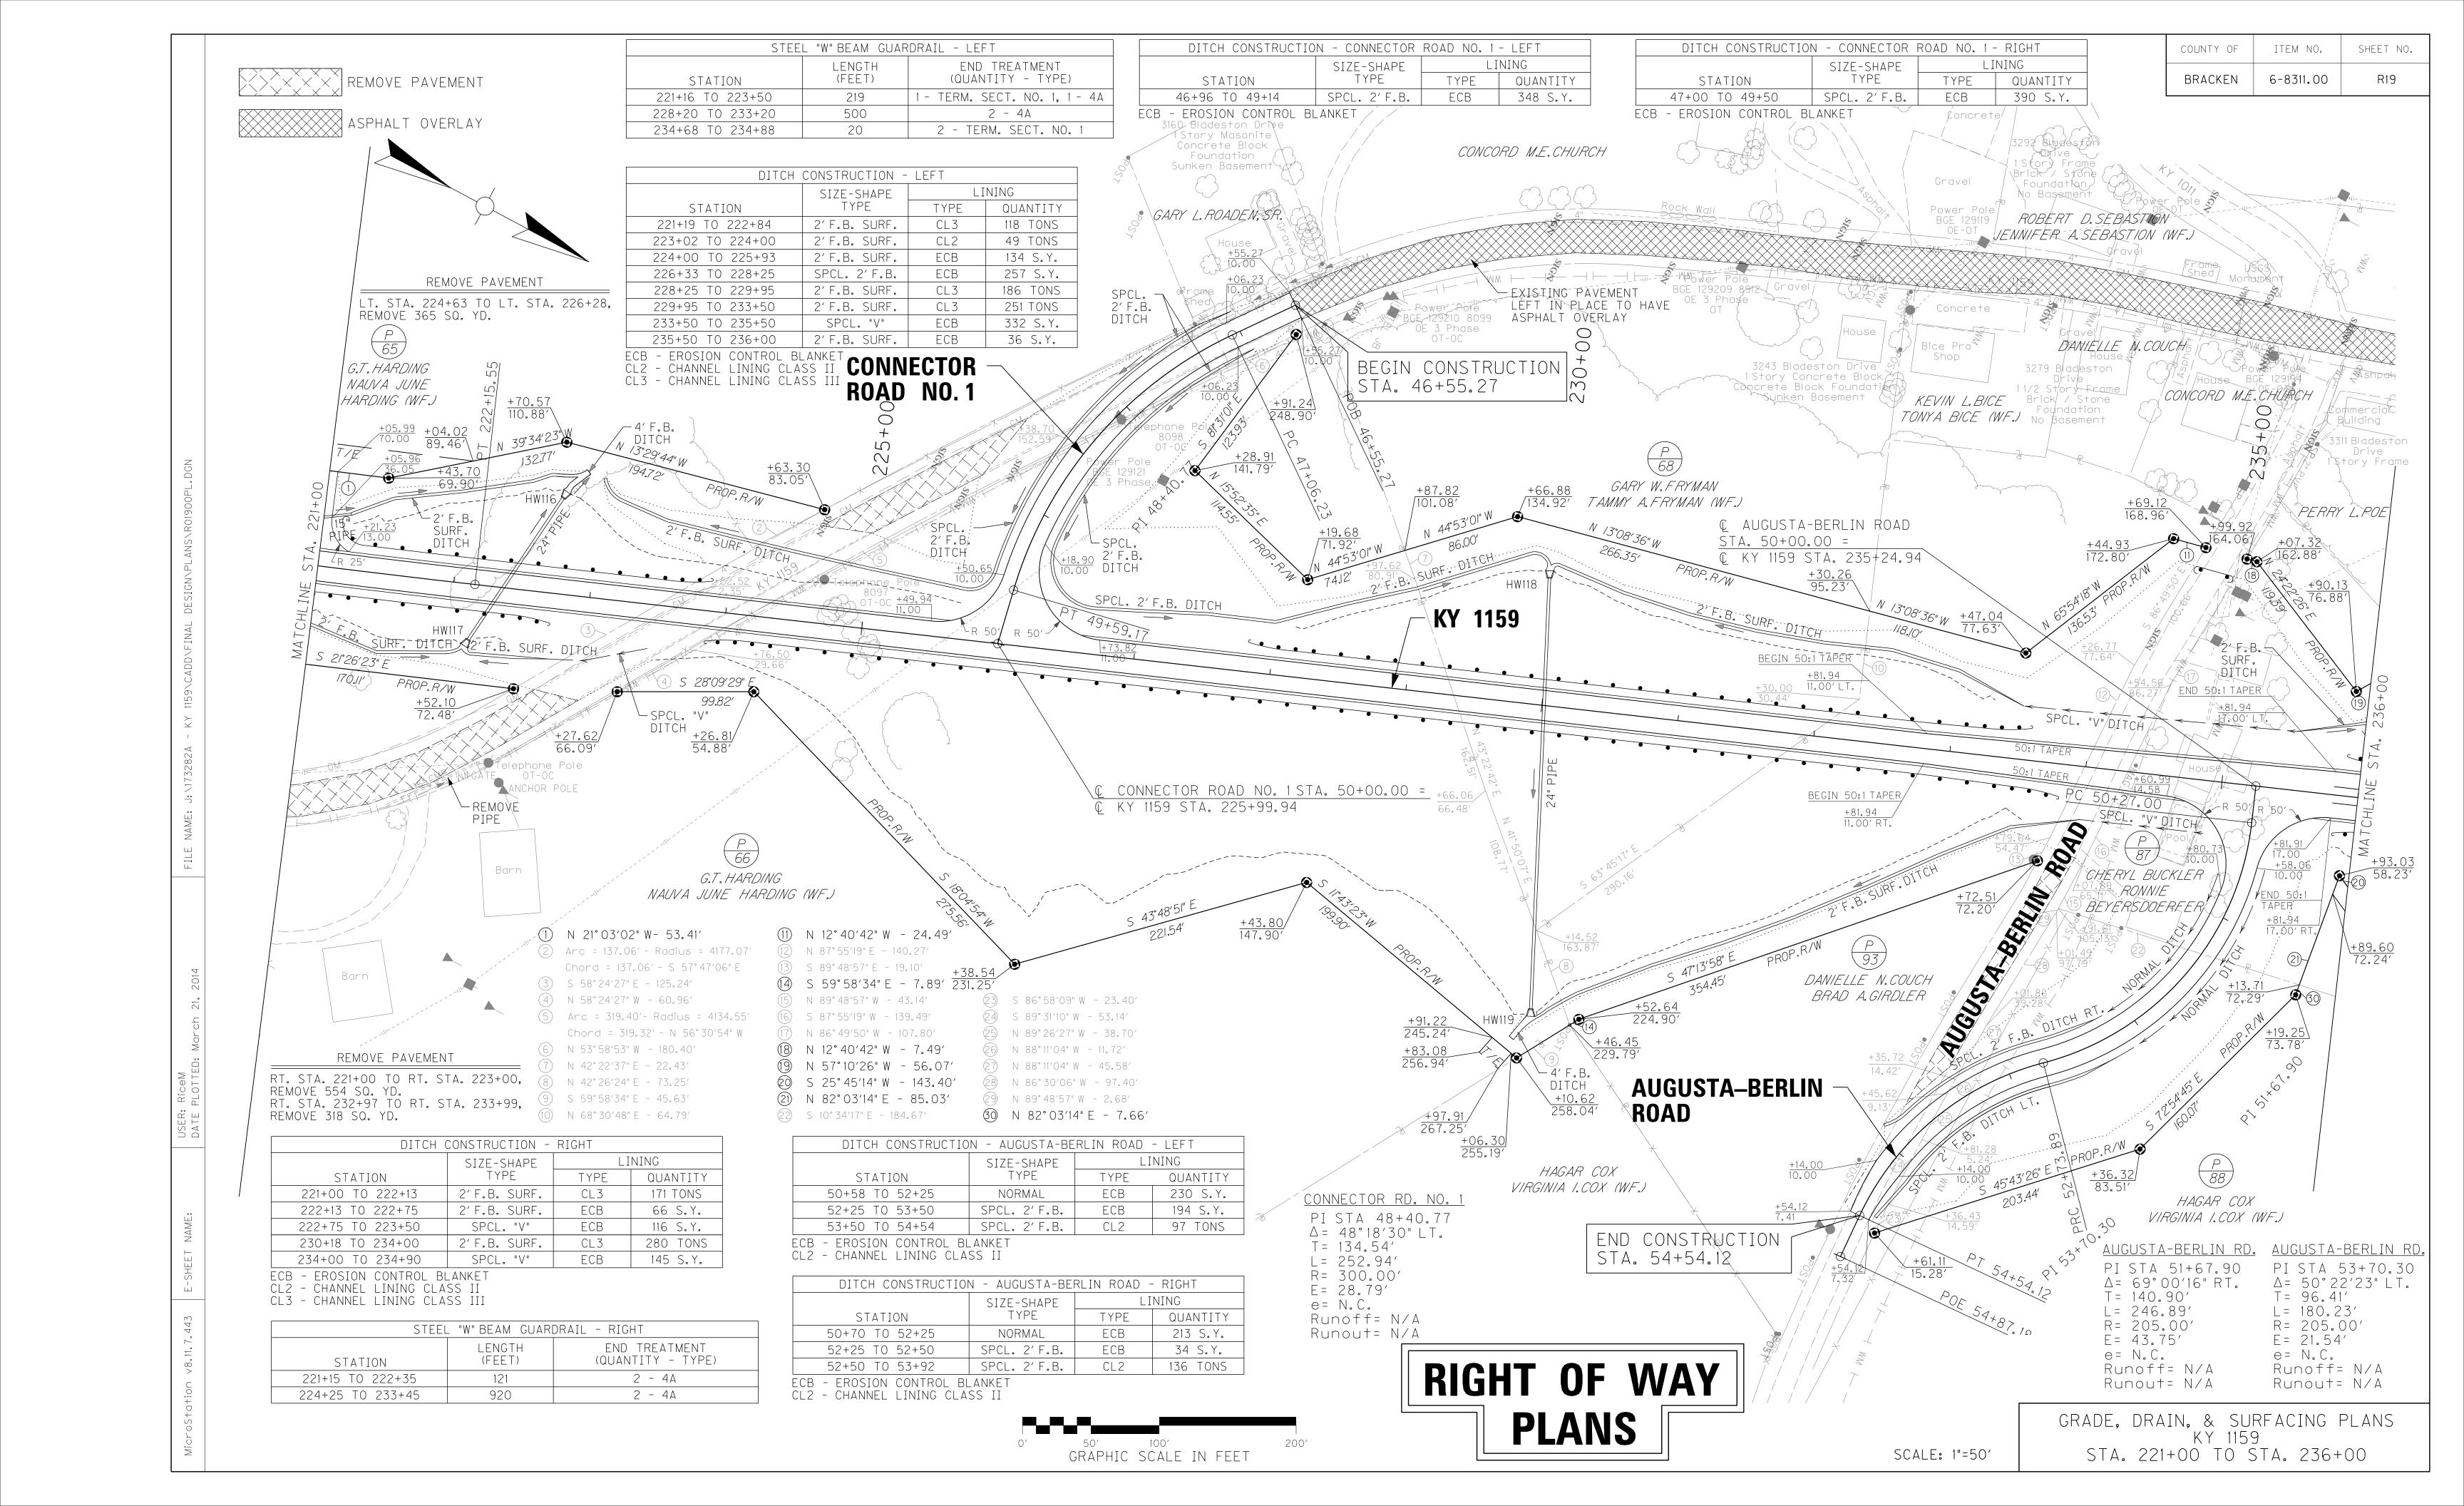


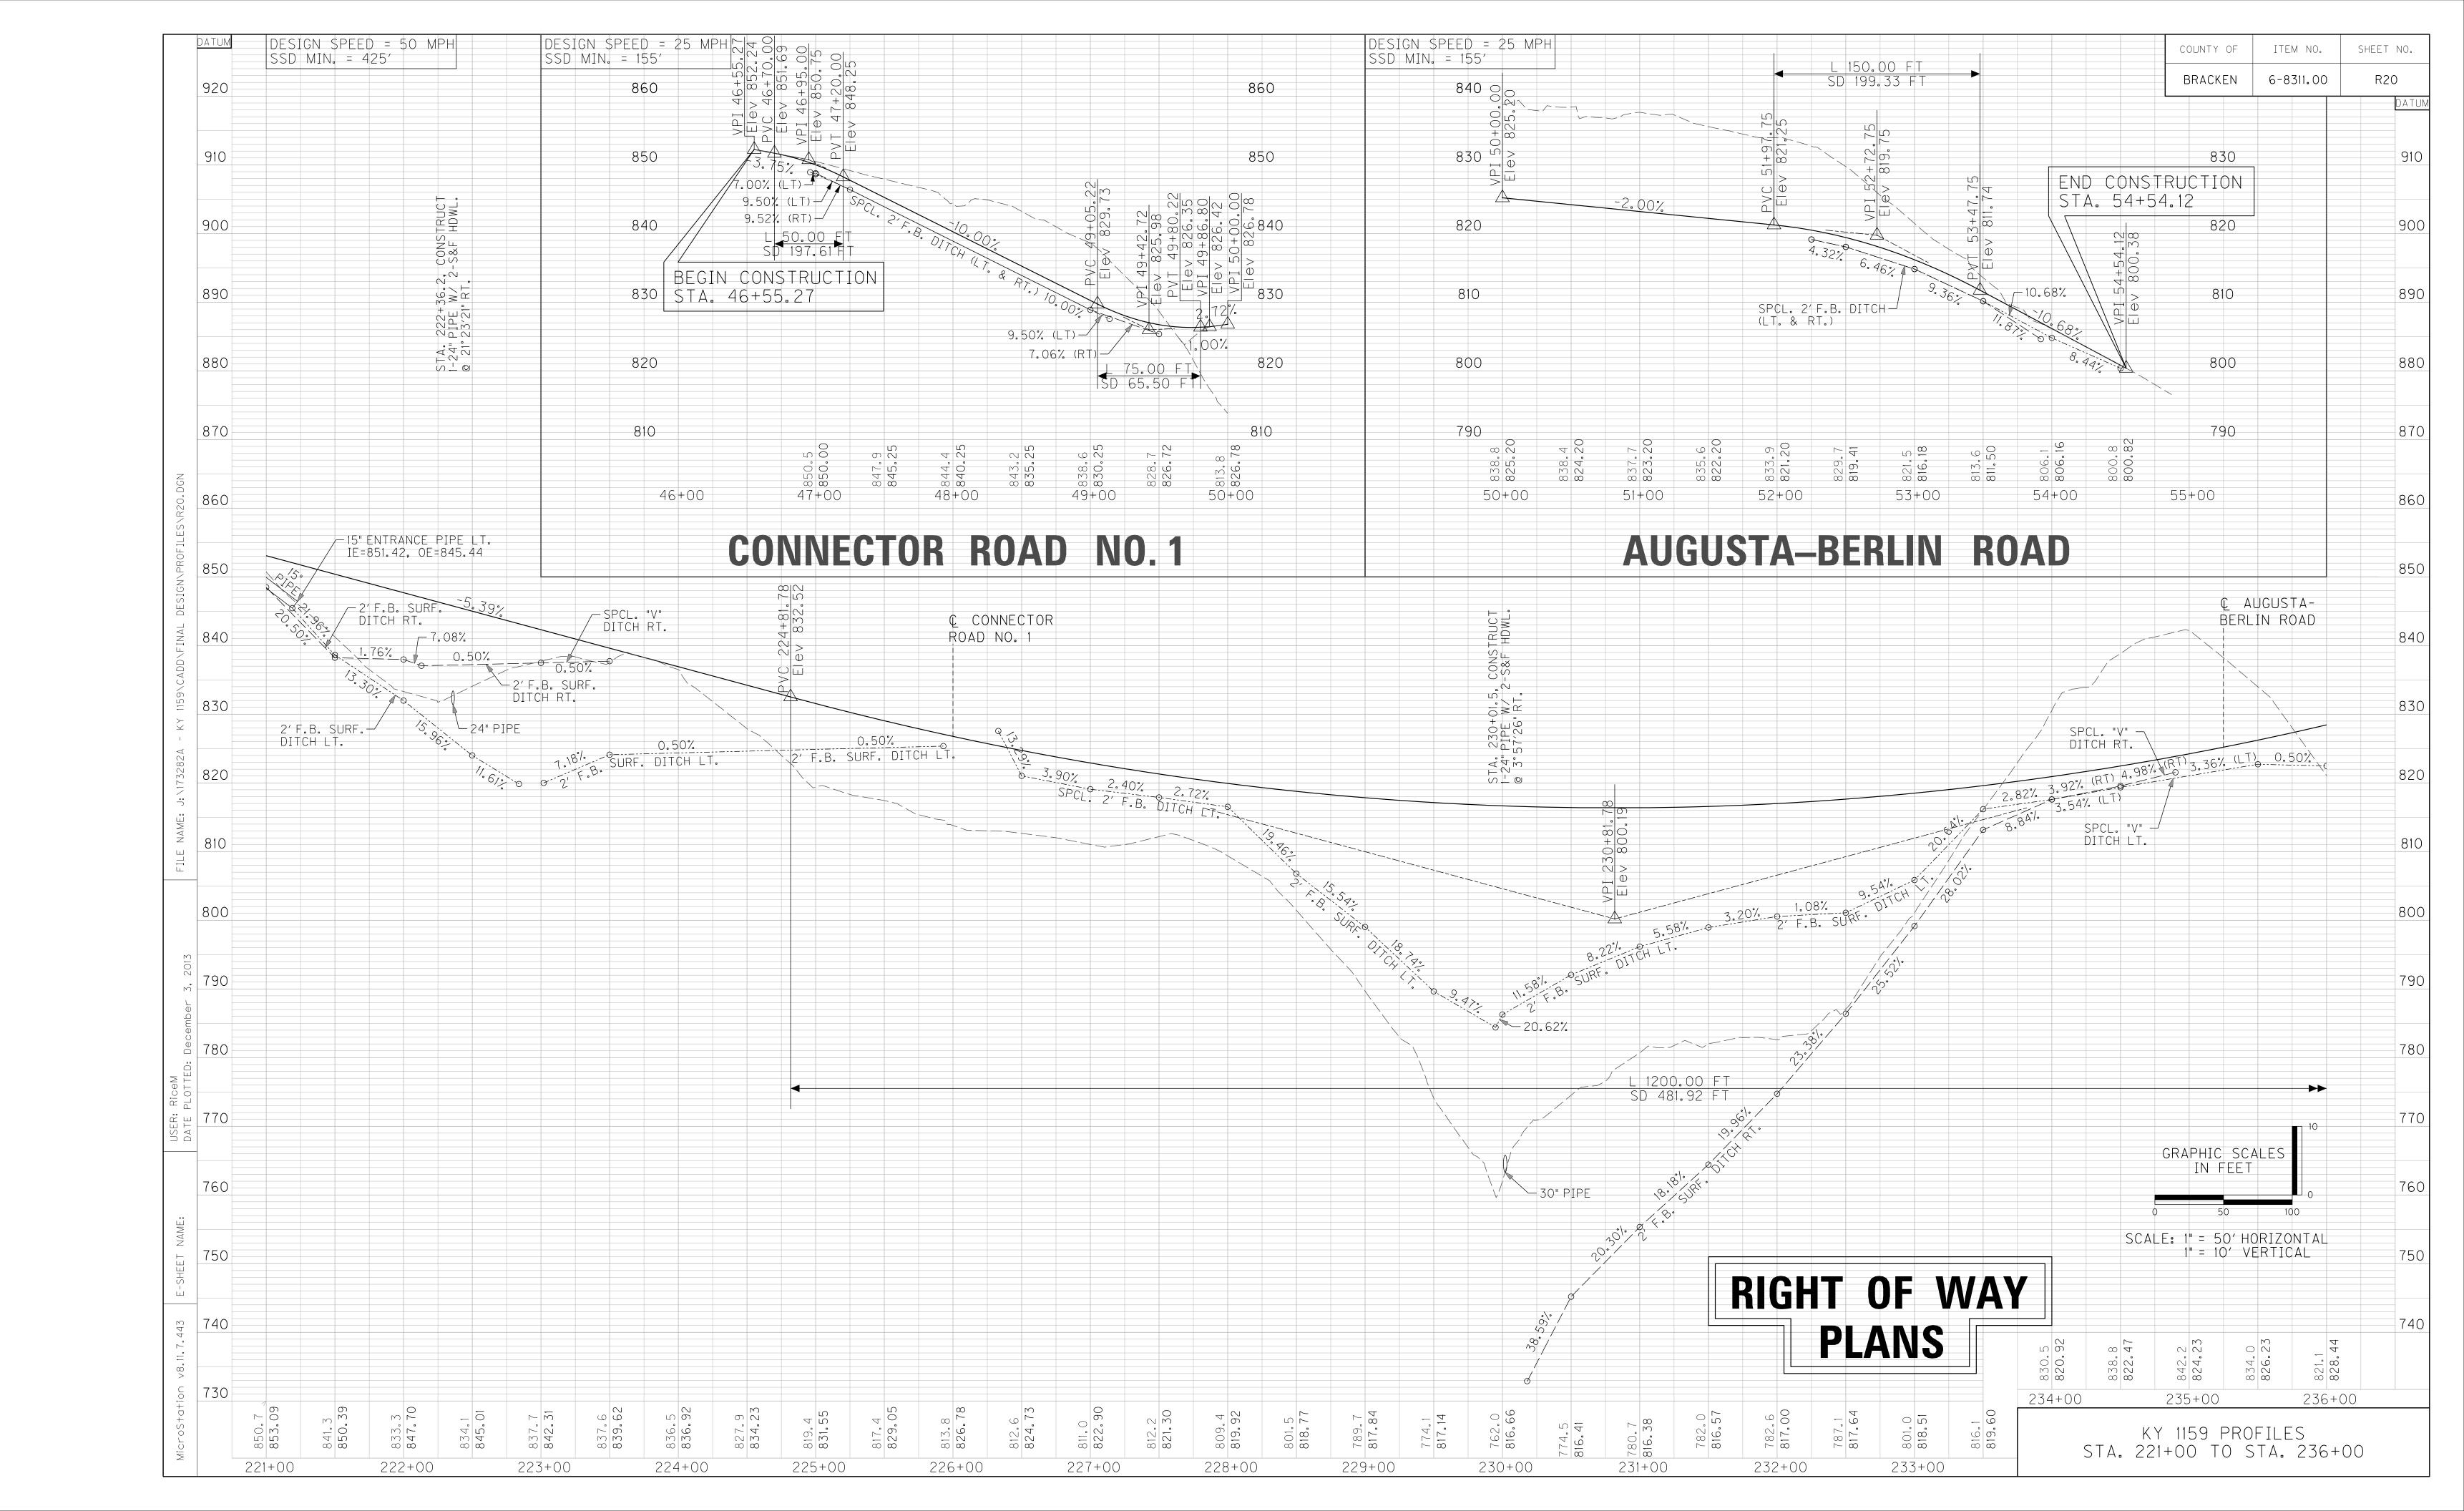


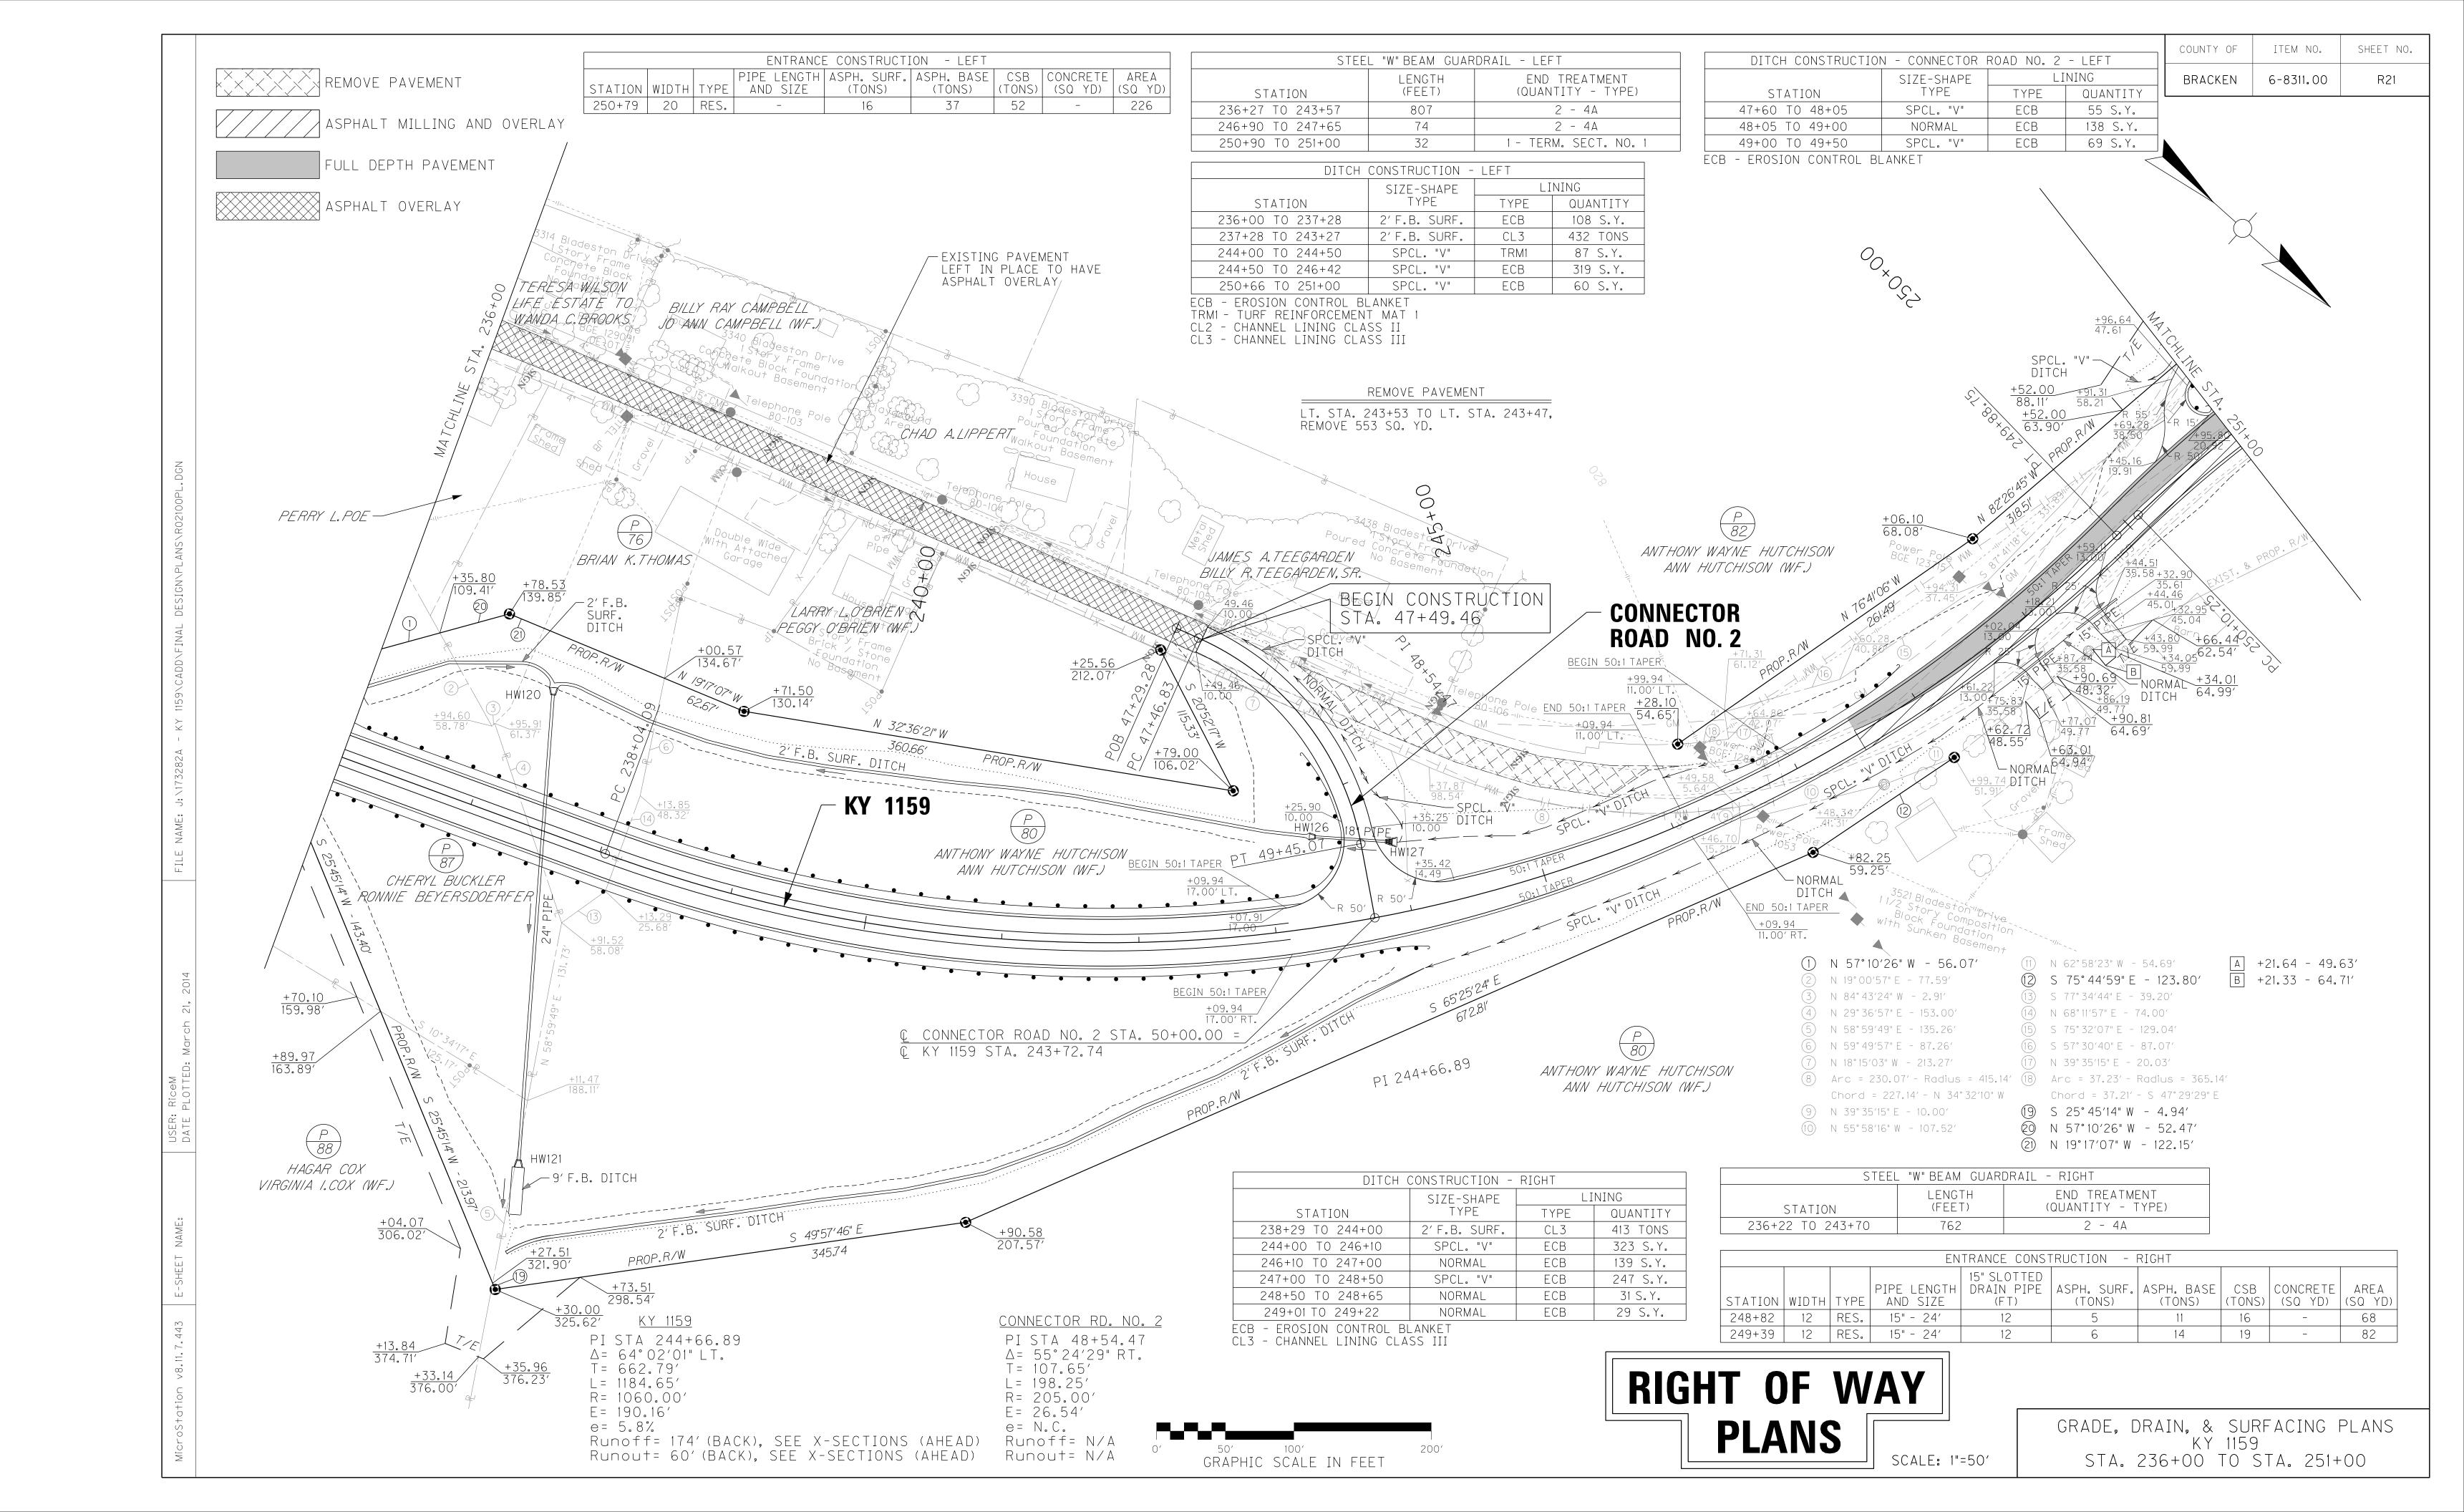


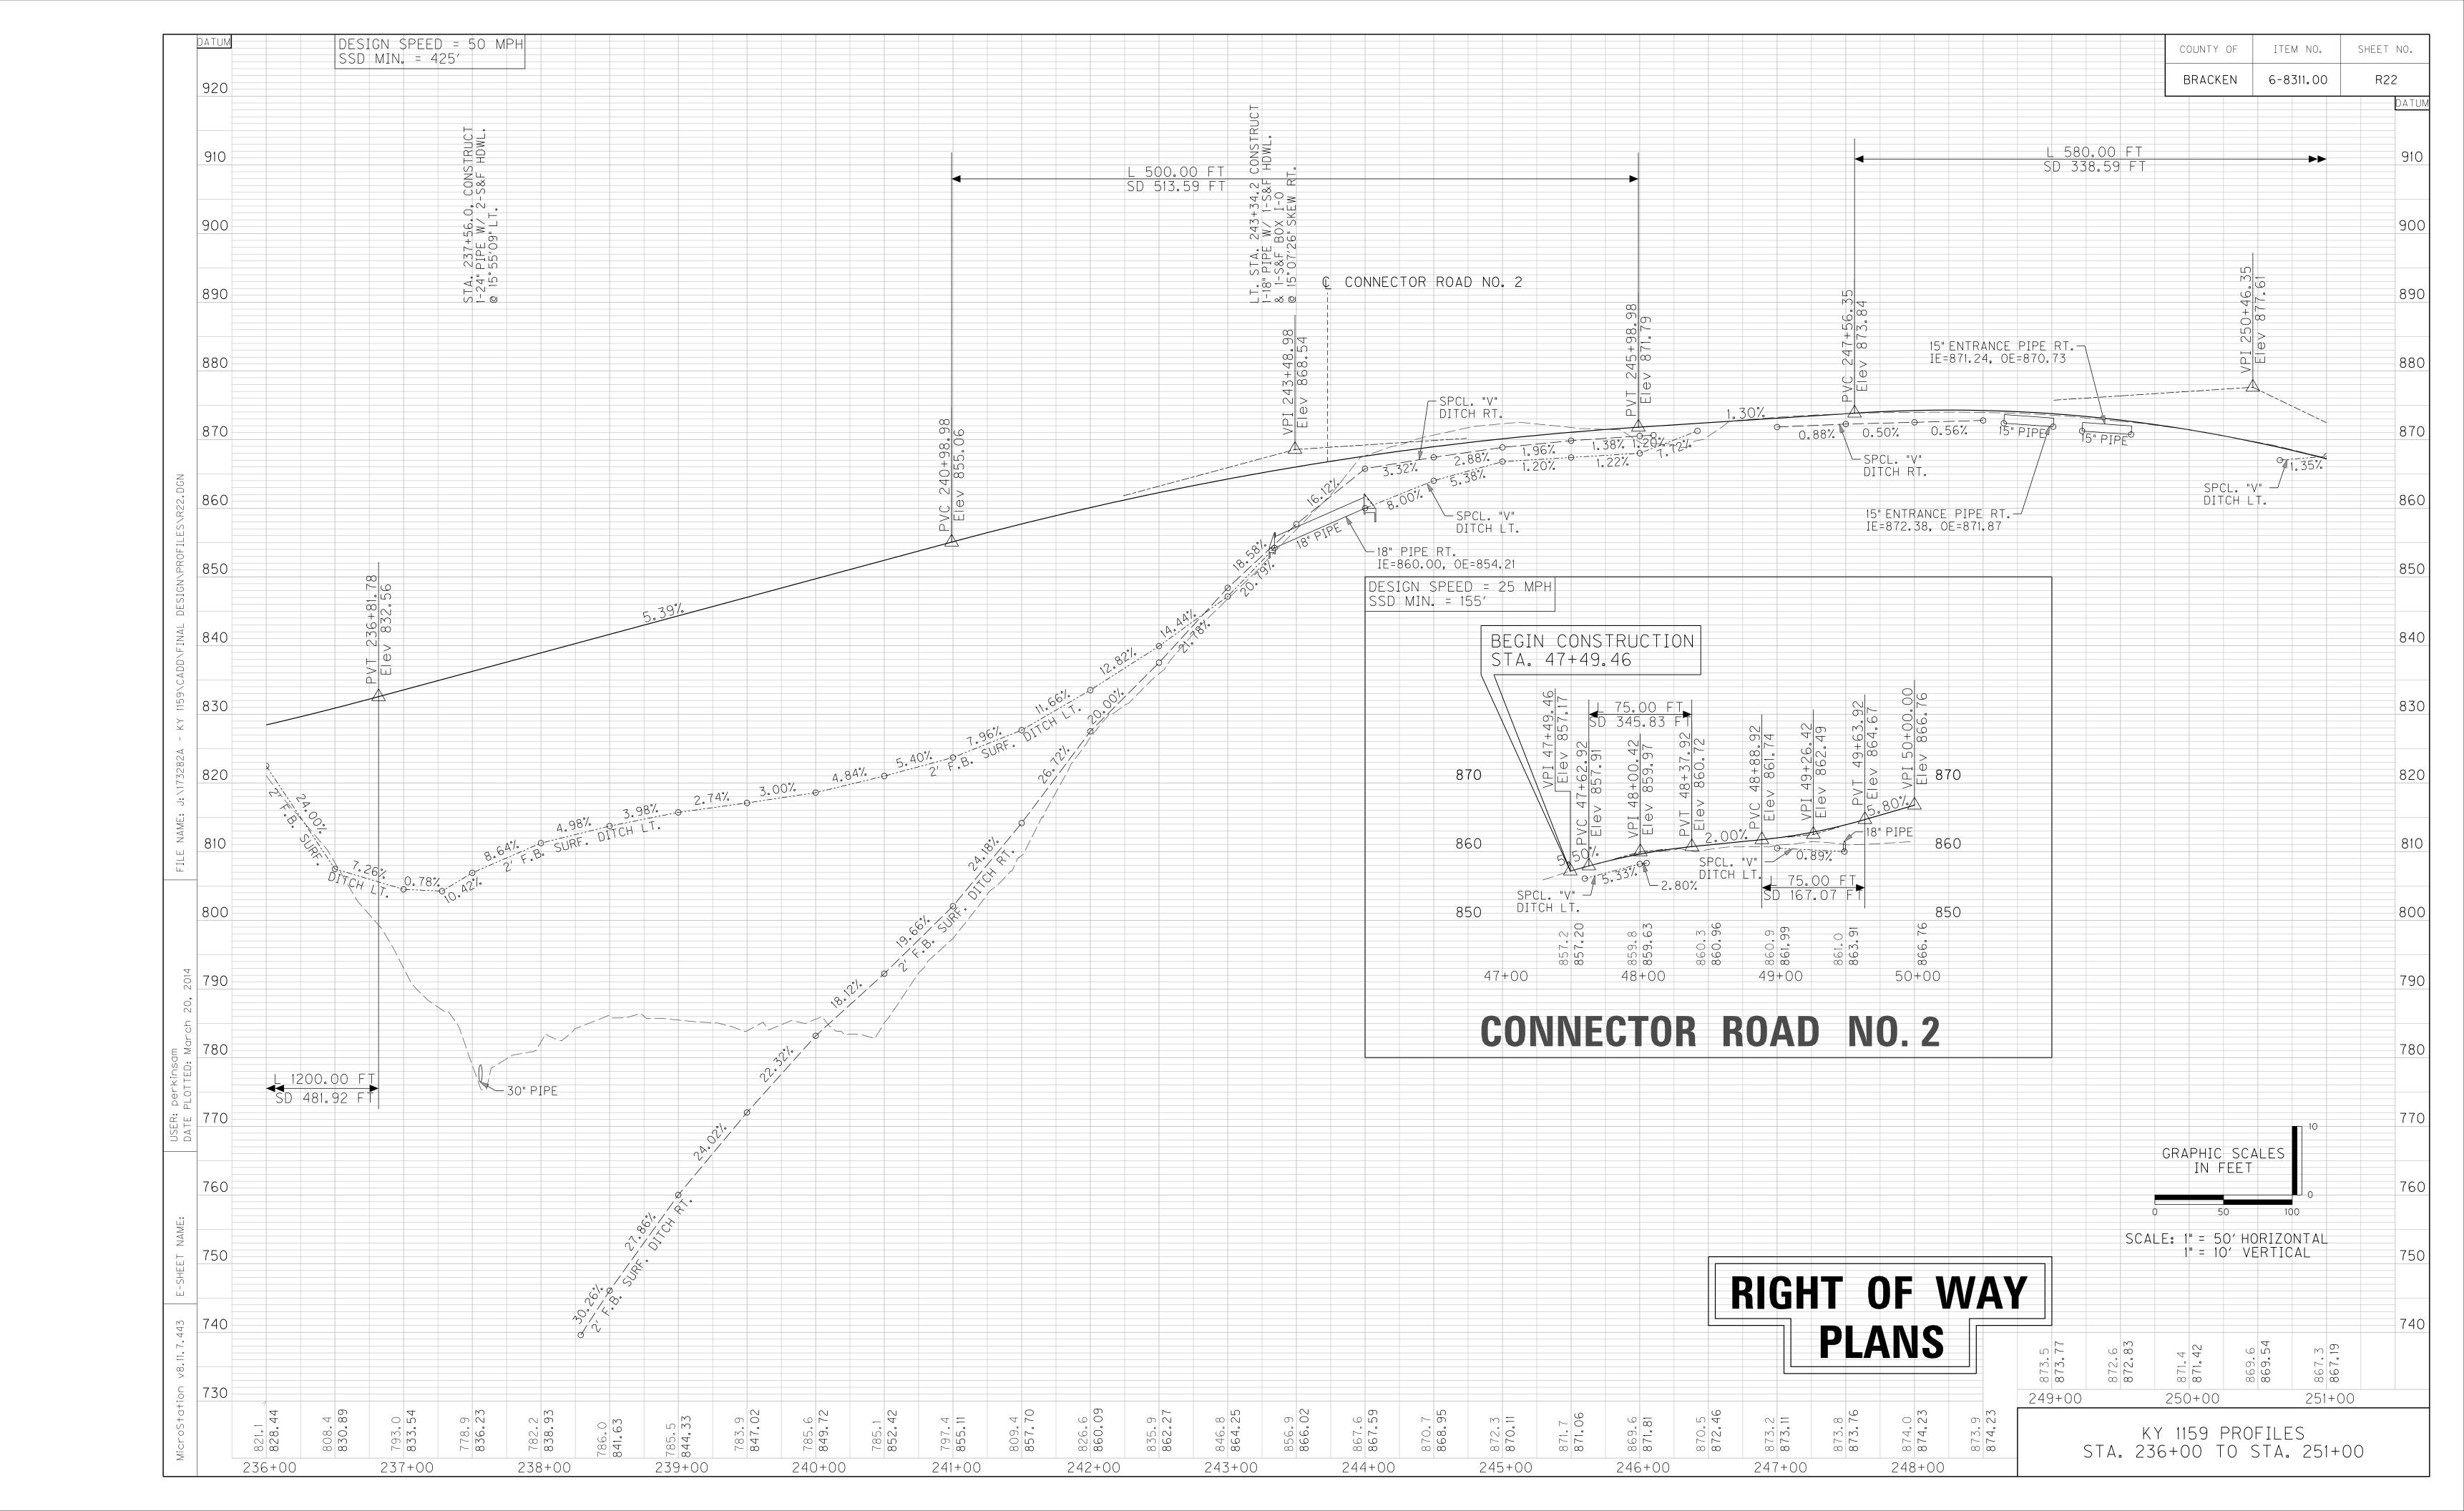

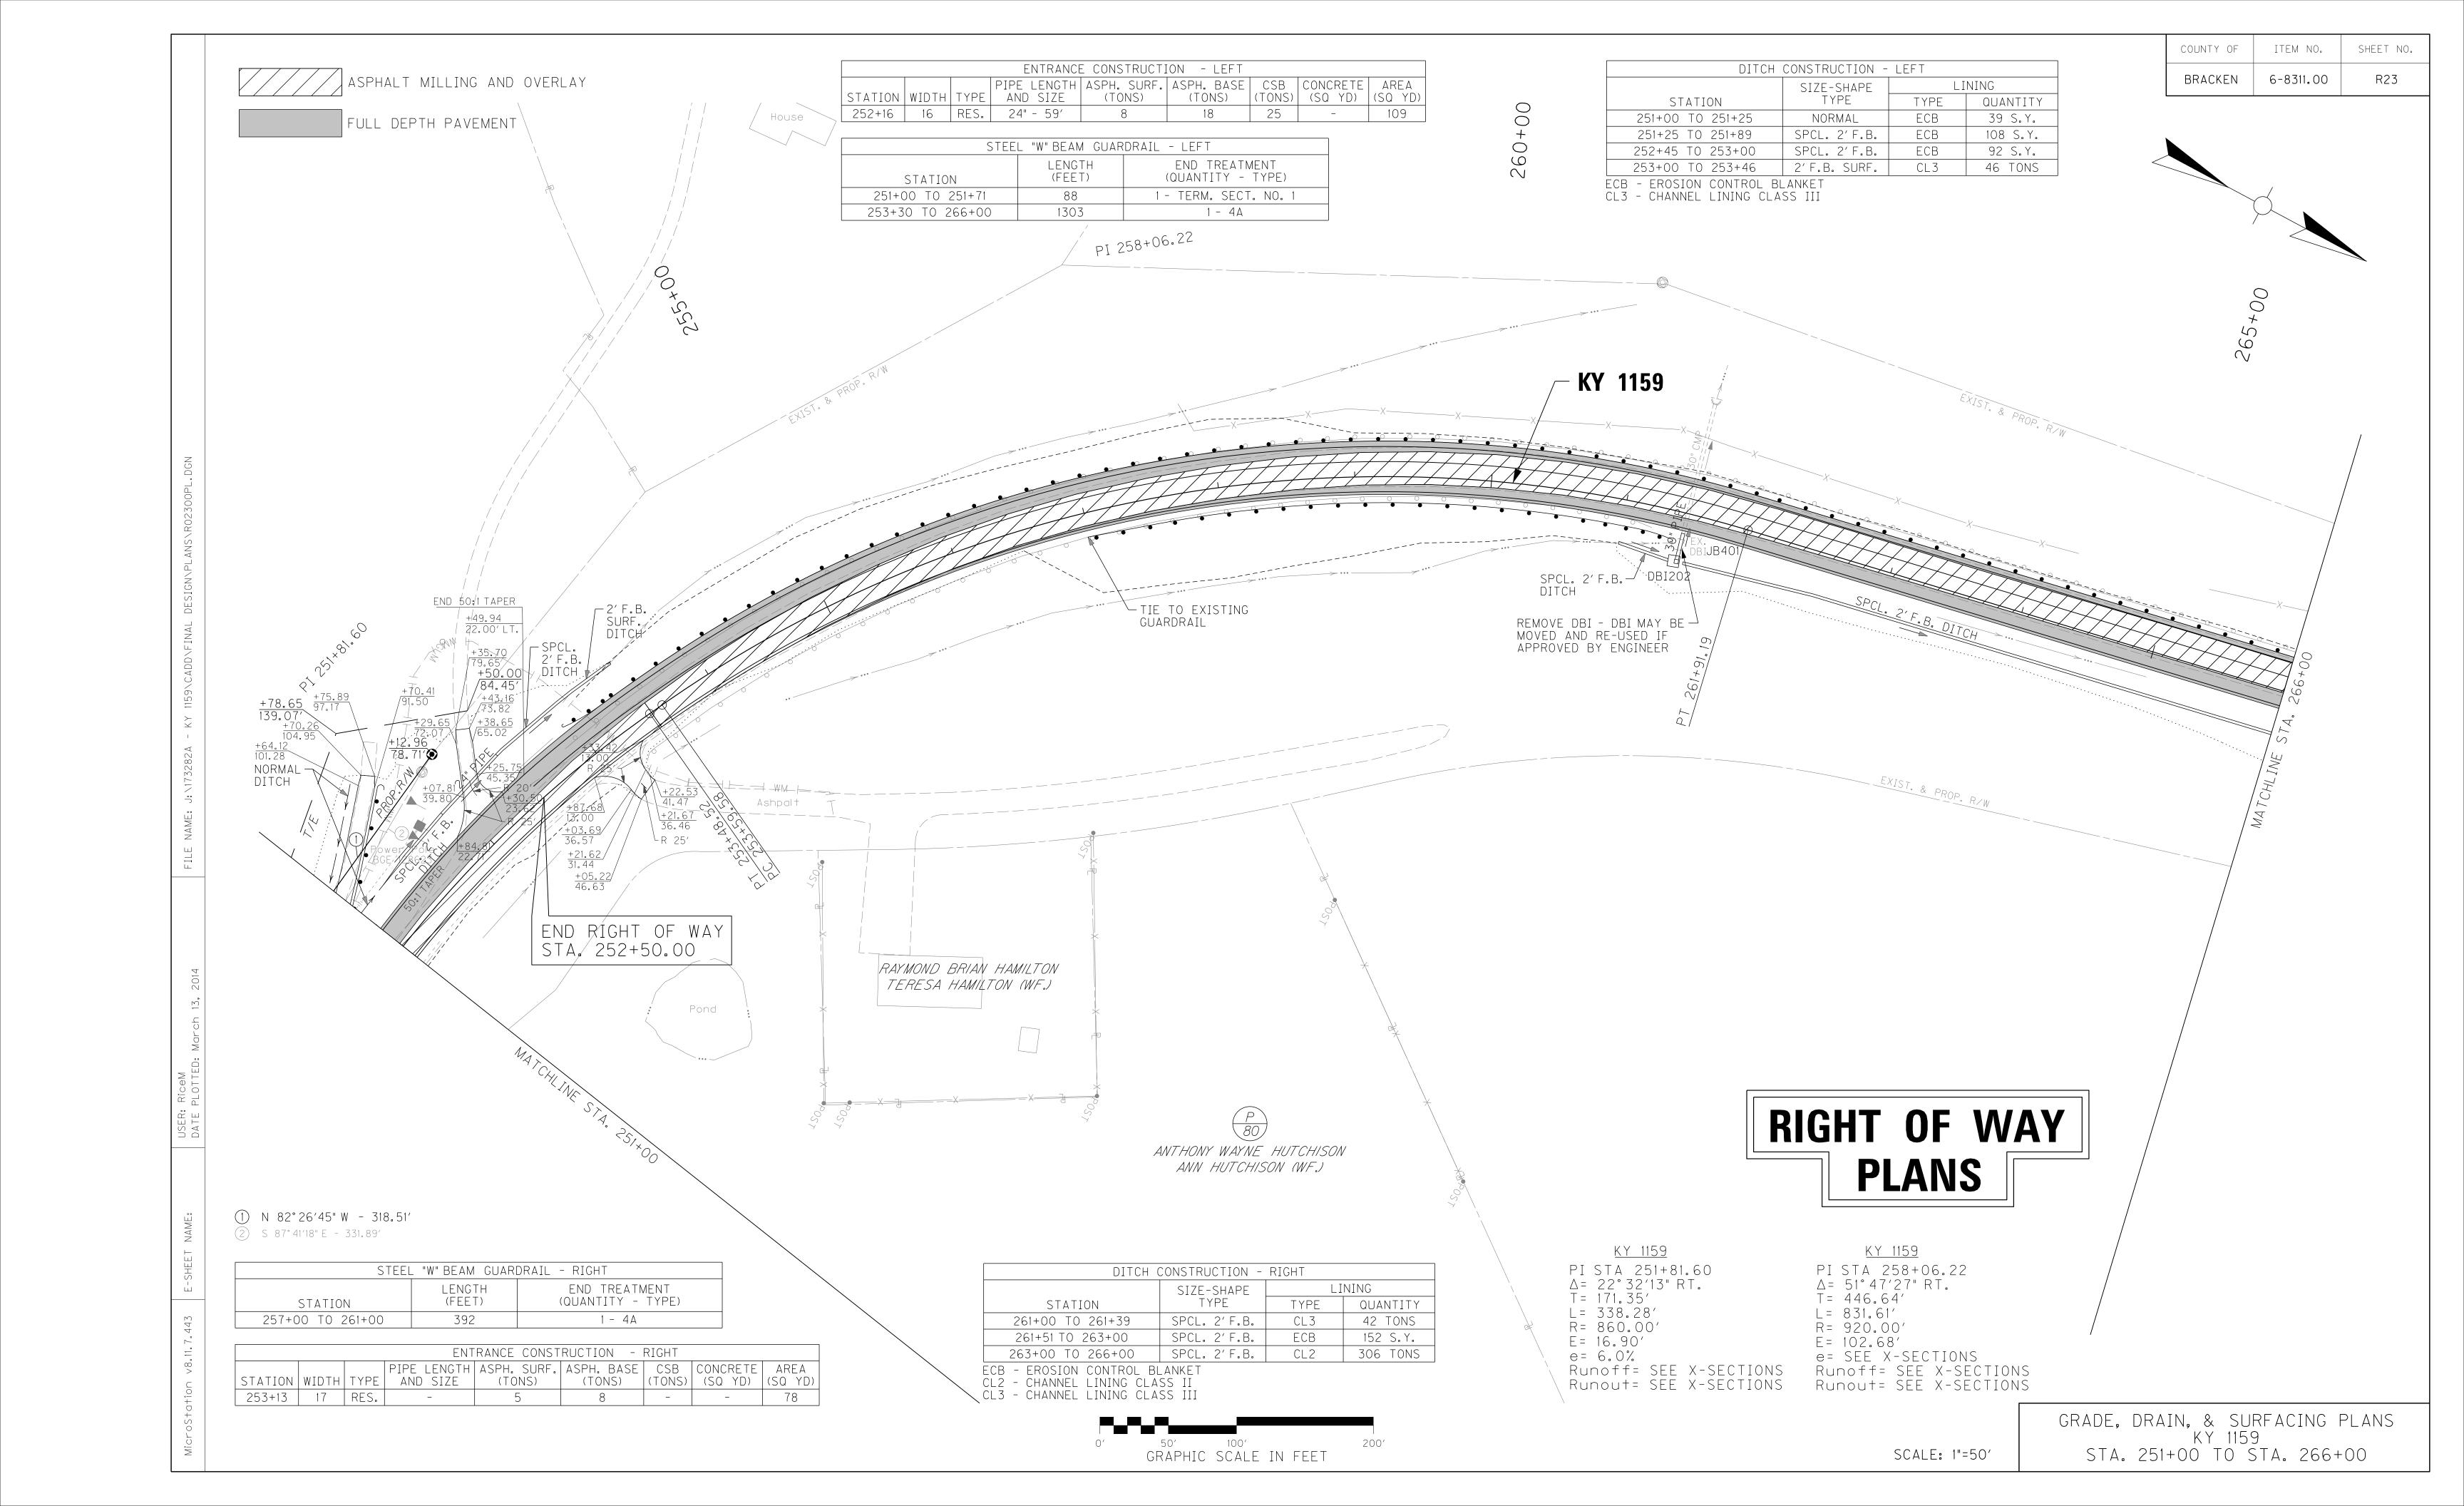


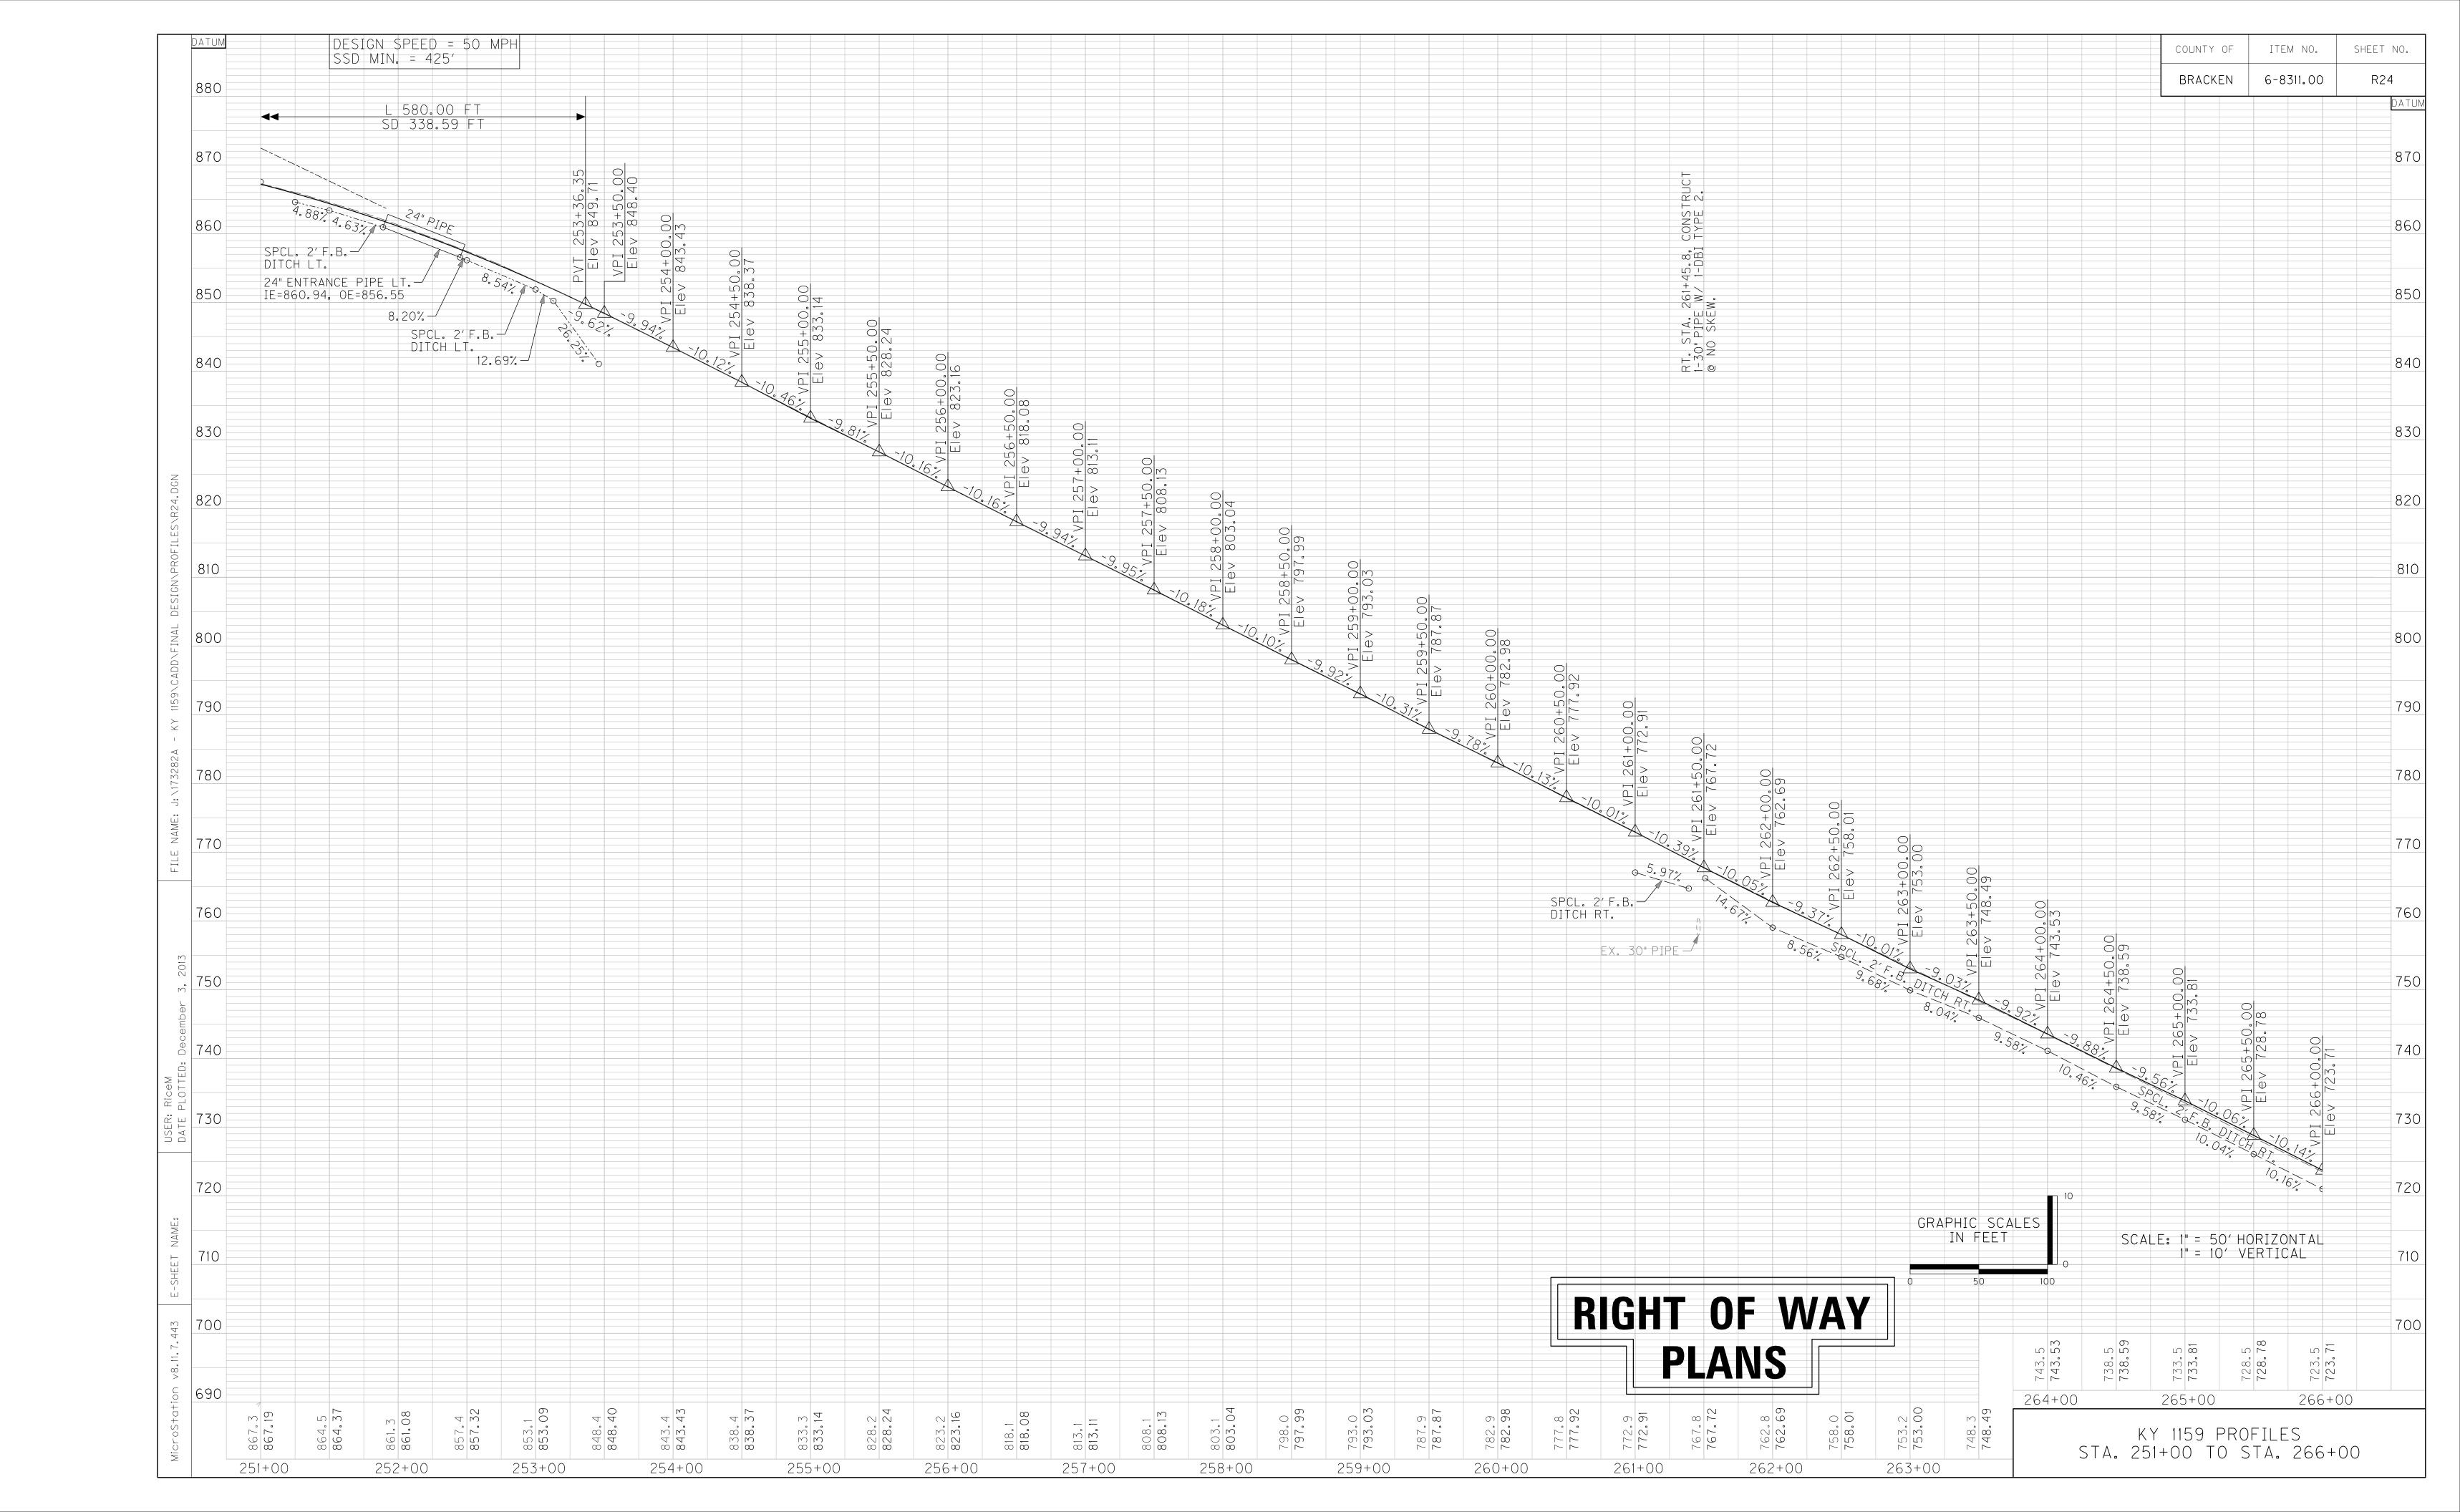

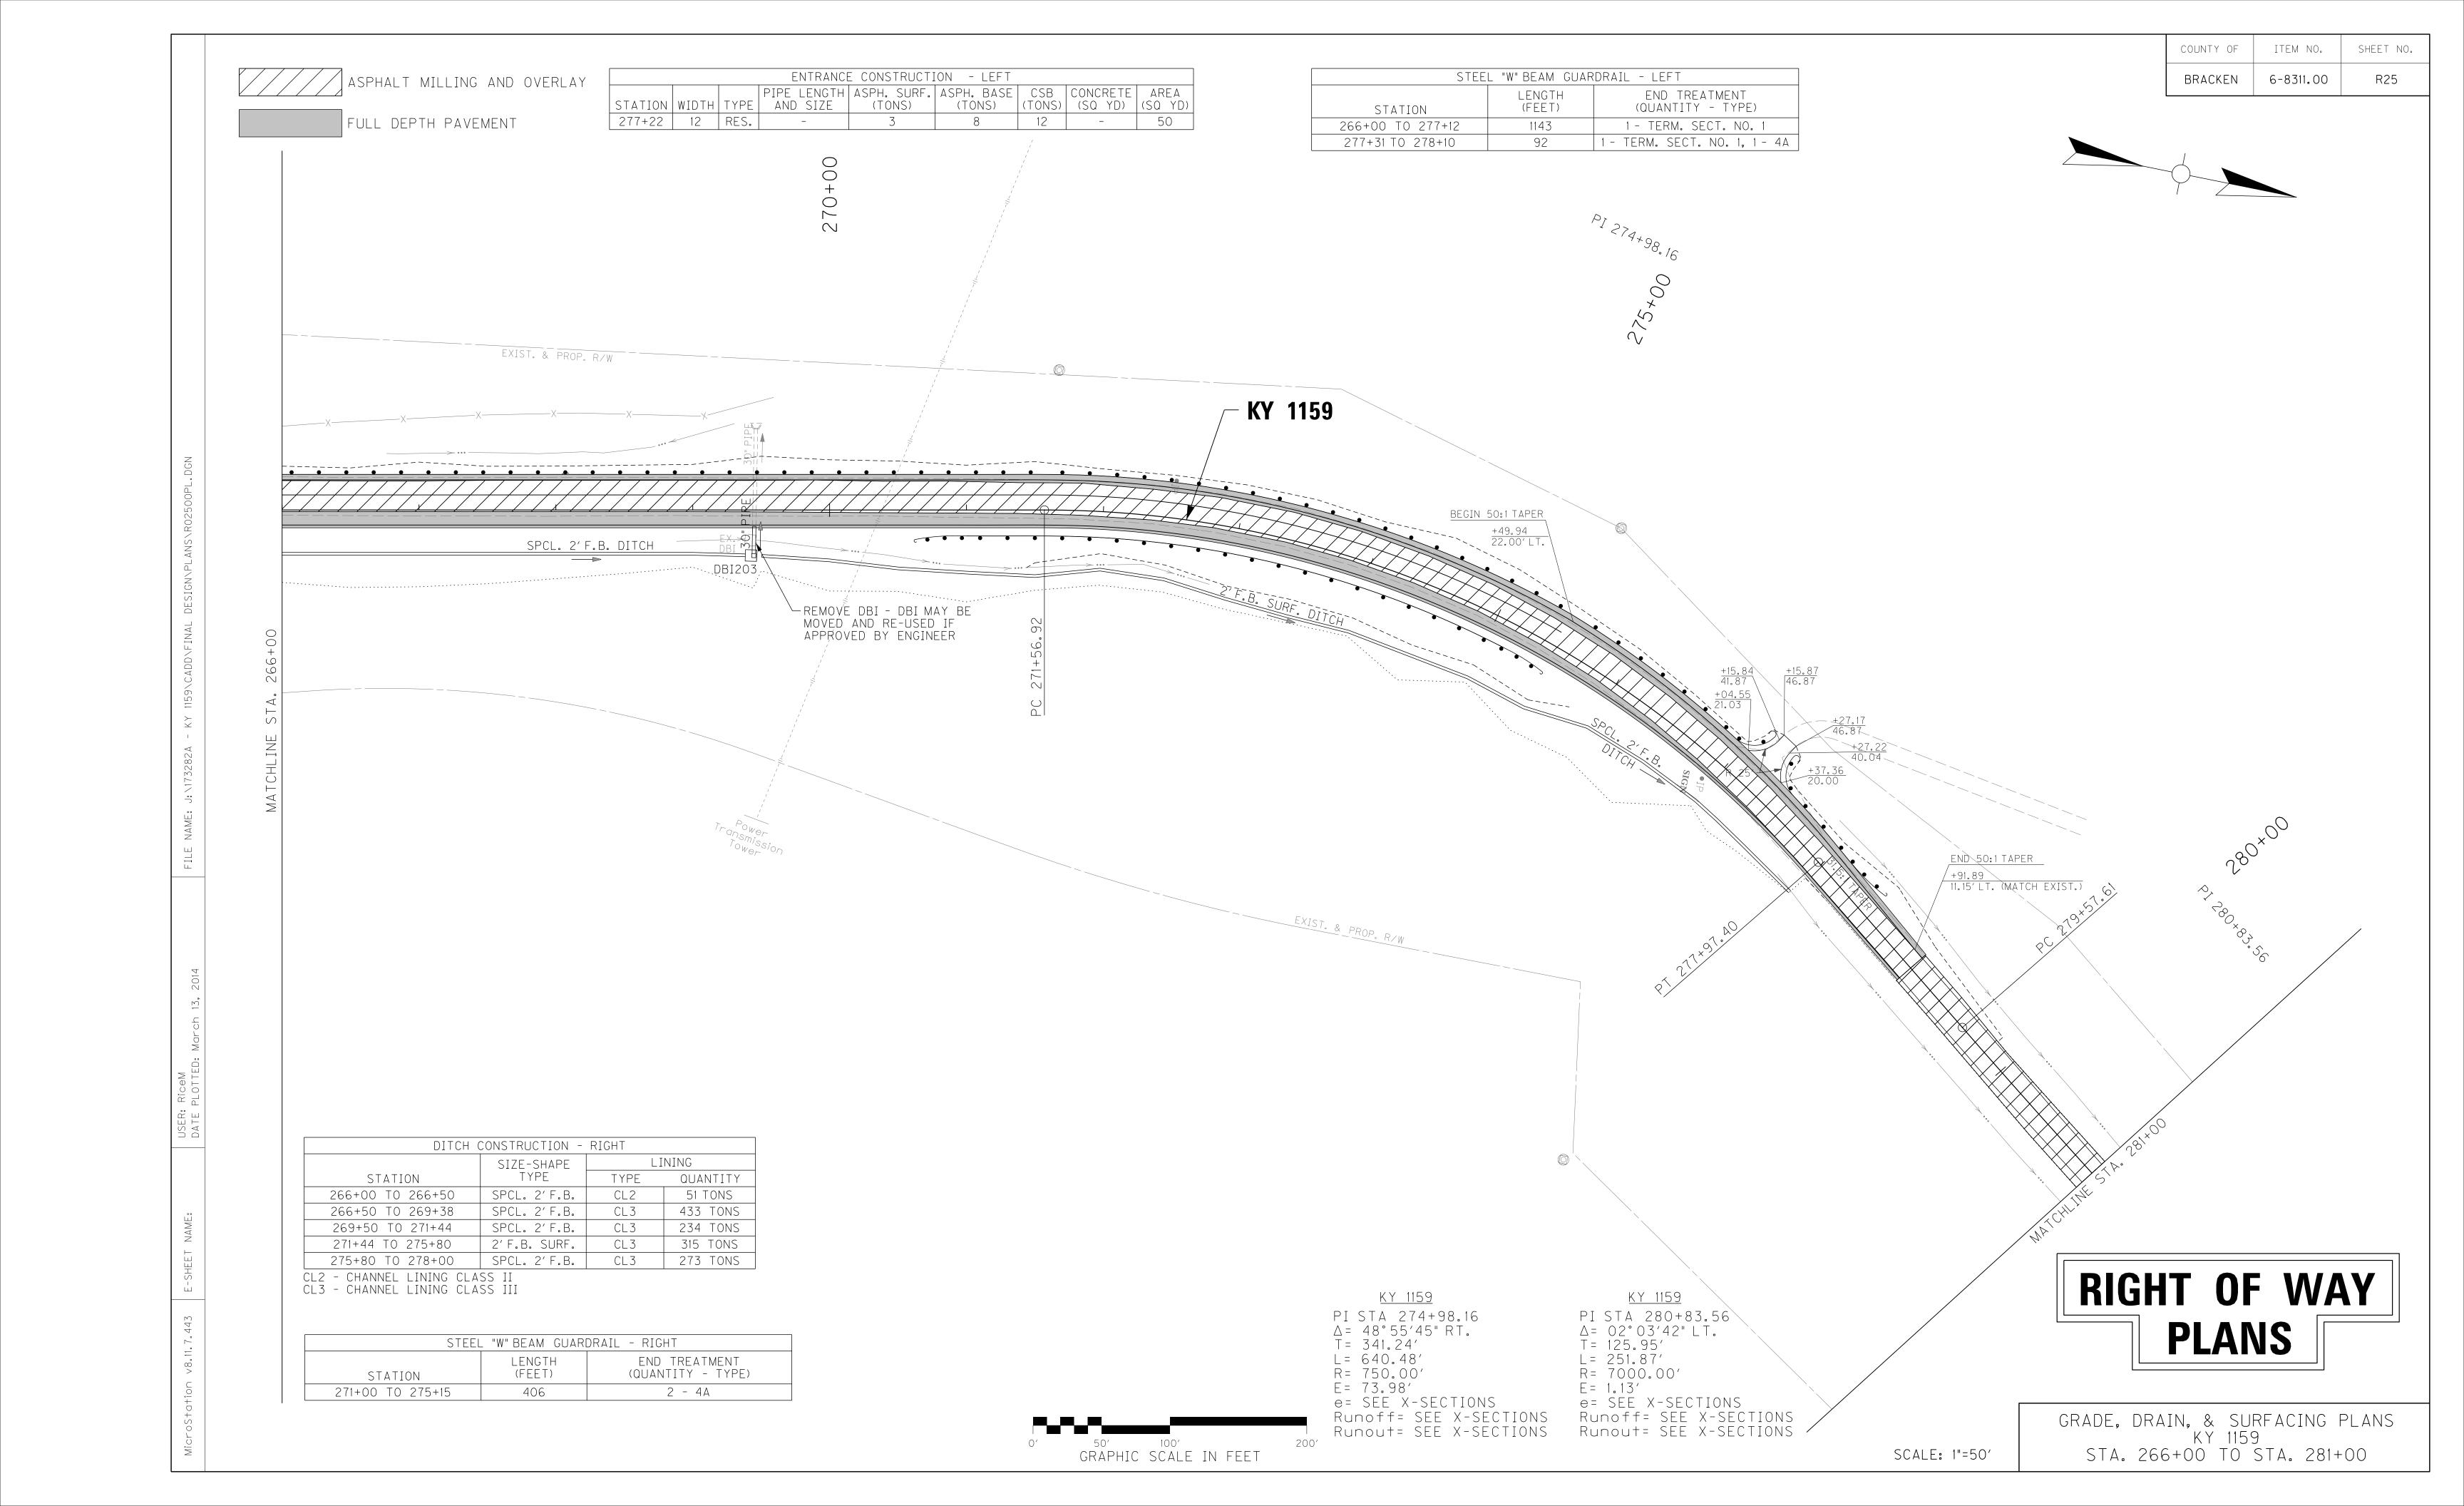

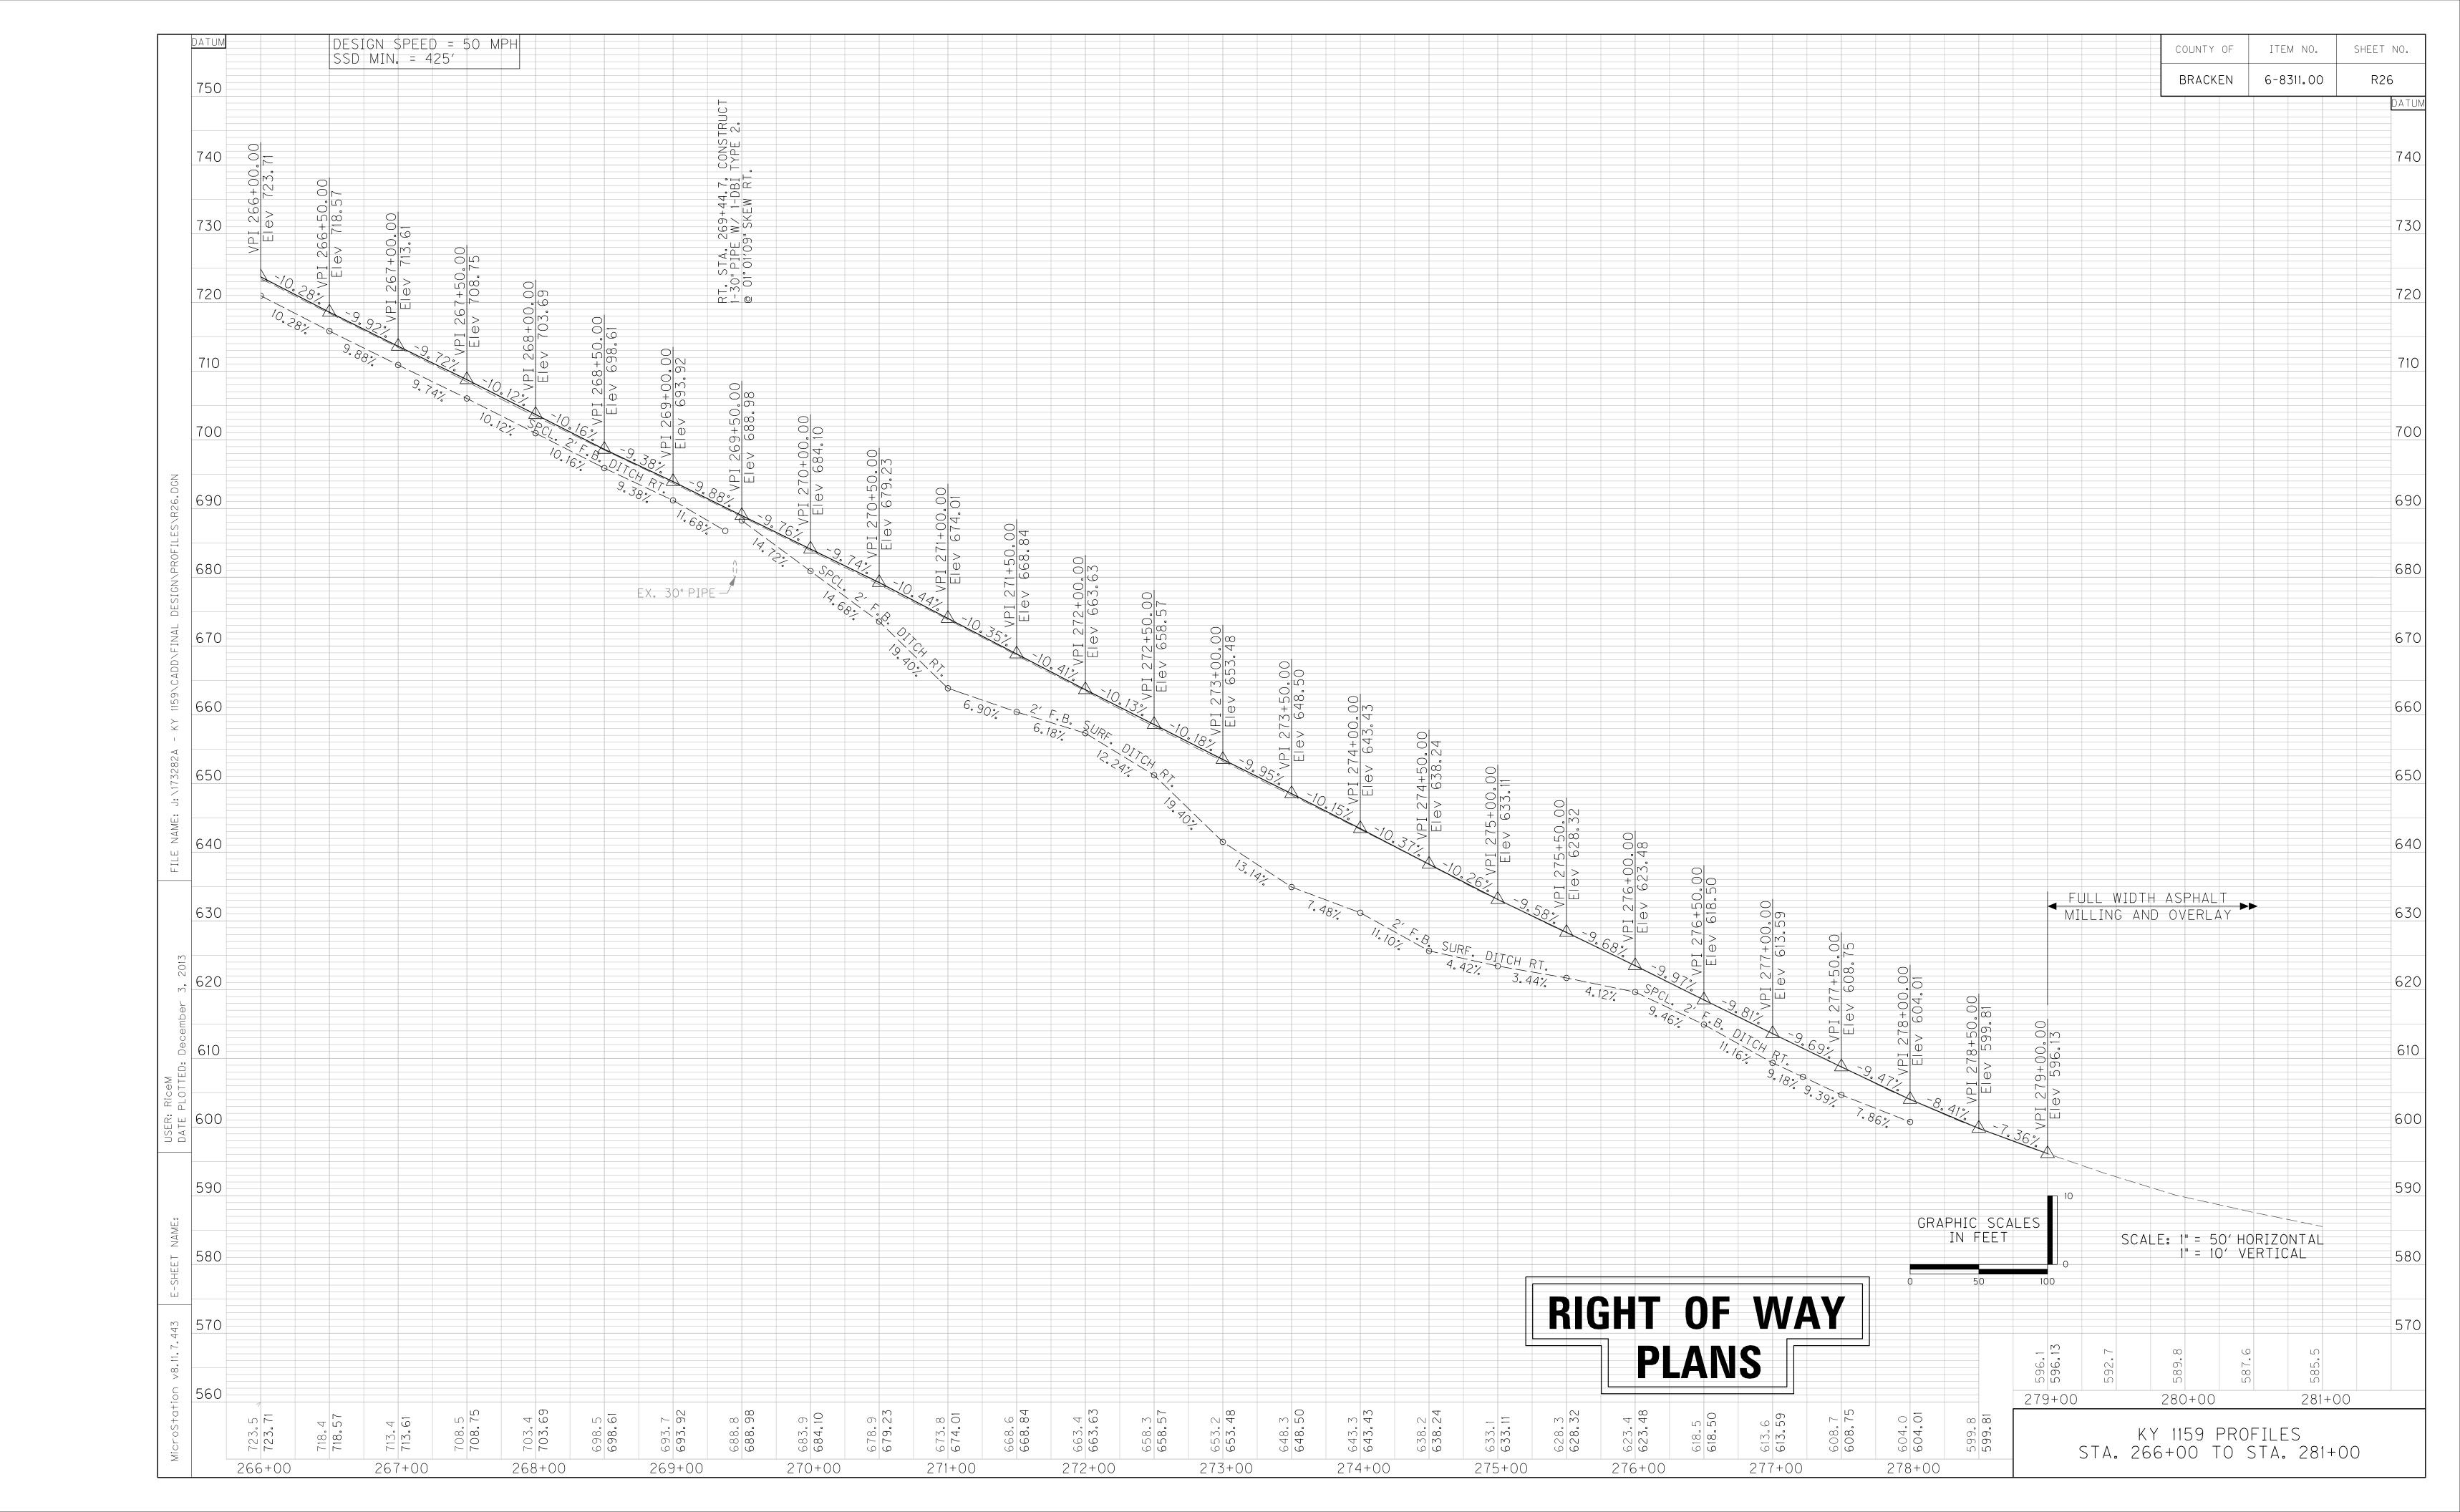

SHEET NO. ASPHALT MILLING AND OVERLAY 6-8311.00 R27 BRACKEN KY 1159 KY 1159 END CONSTRUCTION STA. 285+49.55 RIGHT OF WAY
PLANS <u>KY 1159</u> PI STA 283+40.13 \( \text{\Delta} = 29\cdot 03'15\cdot \text{\LT.}\)
\( \text{T} = 120.69'\)
\( \text{L} = 236.18'\)
\( \text{R} = 465.75'\)
\( \text{E} = 15.38'\)
\( \text{e} = SEE X-SECTIONS\)
\( \text{Runoff} = SEE X-SECTIONS\)
\( \text{Runout} = SEE X-SECTIONS\) GRADE, DRAIN, & SURFACING PLANS KY 1159 STA. 281+00 TO STA. 285+49.55 GRAPHIC SCALE IN FEET SCALE: 1"=50'

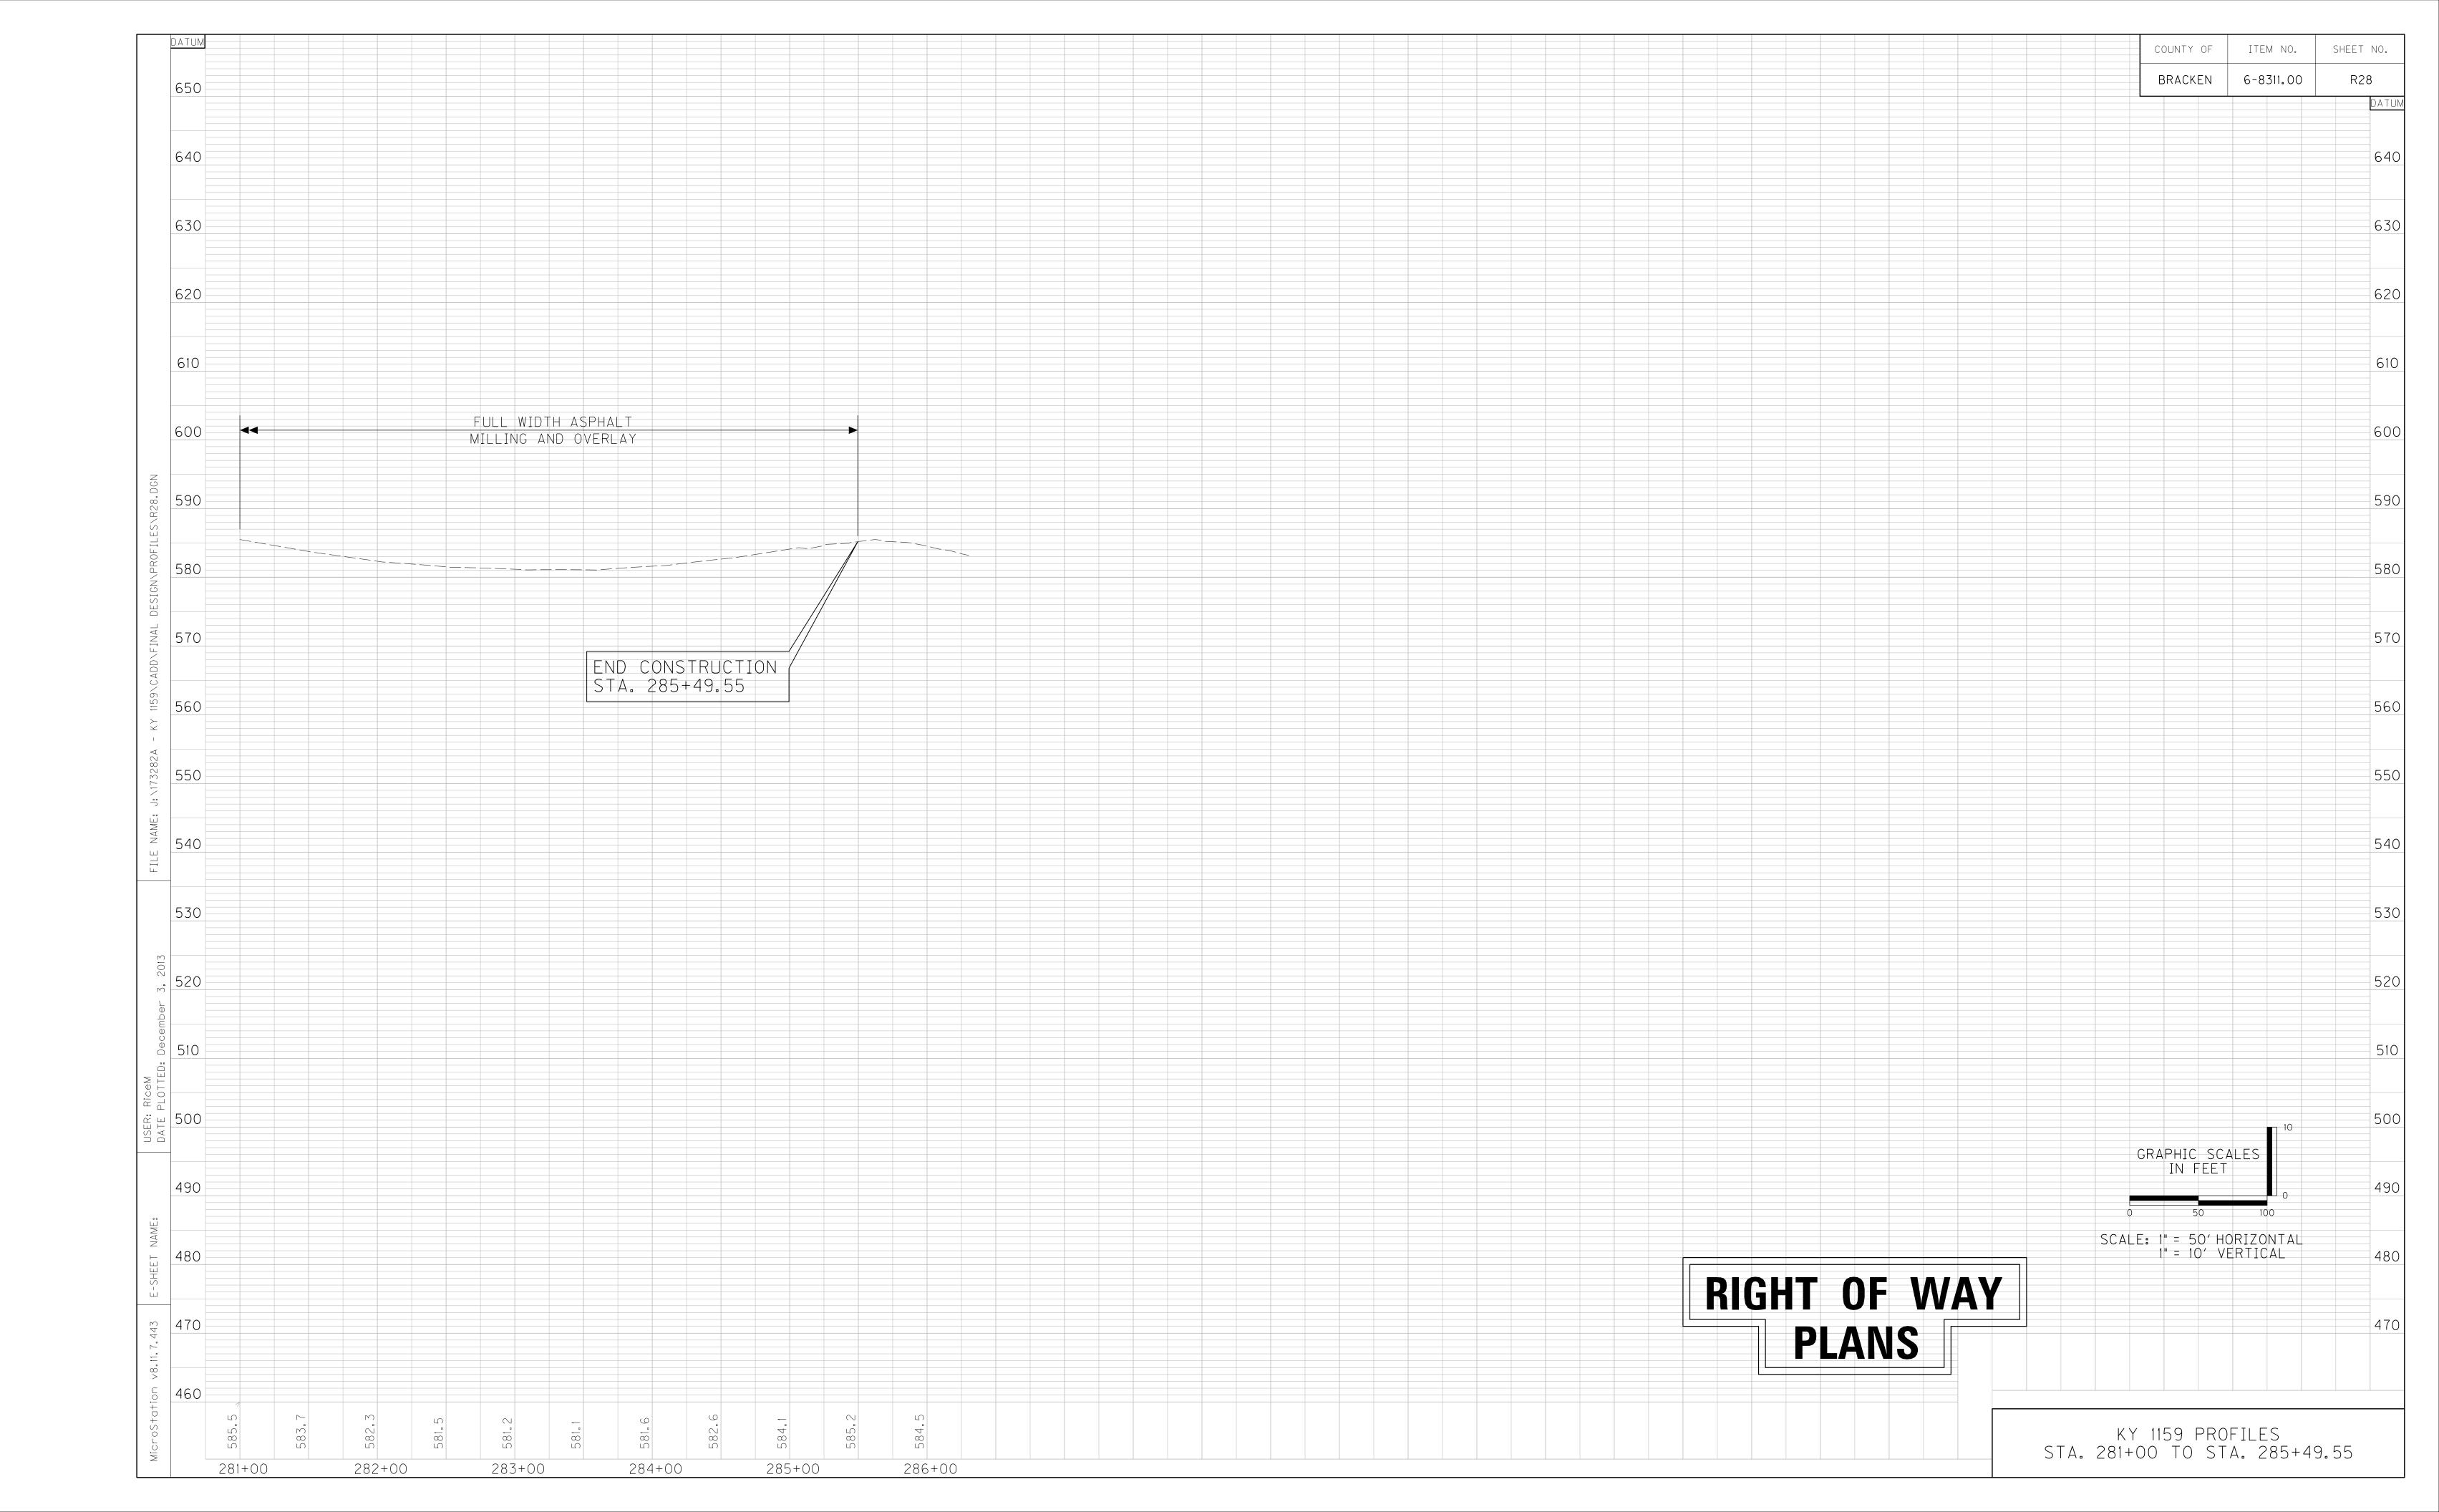

COUNTY OF	ITEM NO.	SHEET NO.
BRACKEN	6-8311.00	R29

## RIGHT OF WAY SUMMARY

SEE	NOT
SEE	1001

PARCEL	OWNER(S)	TOTAL ARE	EA OF TRACT	PERMANENT I	R/W ACQUIRED		MENTS TEMPORARY	L	AREA S	EVERED RIG	GHT	EXCESS P	URCHASED				SEWER S'	TED BY	BUILDINGS ACQUIRED NUMBER			SOURCE OF TITLE REMARKS
NO.	SWI24(6)	ACRES	SQ. FT.	ACRES	SQ. FT.	SQ. FT.	SQ. FT.	ACRES	SQ. FT.	ACRES	SQ. FT.	ACRES	SQ. FT.	ACRES	SQ. FT.	TVPF			R	F	S	1
1	CHARLES R. RECHTIN & CAROLE RECHTIN (WF.)	80.797	3,519,517		15,923		435			80.431	3,503,594			80.431	3,503,594							D.B. 118, PG. 309
2	JANET H. STORY		17,041				567				17,041				17,041							D.B. 138, PG. 177
3	PEGGY ISHMAEL		22,059				1,354		22,059						22,059							D.B. 180, PG. 225
4	KAREN S. RUMFORD		31,134		1,075		3,501				30,059				30,059							D.B. 143, PG. 229
5	DEBORAH H. SHARP		30,822				1,623		30,822						30,822							D.B. 141, PG. 123
6	MADHU RAM & SADHNA RAM (WF.)	19.499	849,361		3,467		2,469	19.419	845,894					19.419	845,894							D.B. 177, PG. 345
7	GILLIS THOMAS & ROGER THOMAS	1.006	43,831		13,442		507				30,389				30,389							D.B. 185, PG. 570
8	JOHN A. WEISS & BARBARA A. WEISS (WF.)	7.769	338,428	1.017	44,280		8,700	6.753	294,148					6.753	294,148					1		D.B. 143, PG. 402
10	JAMES A. CLOS & LEOMA J. CLOS (WF.)	28.257	1,230,883		23,735		6,911			27.712	1,207,148			27.712	1,207,148					1		D.B. 105, PG. 14
11	BILLY COLEMIRE & HELEN COLEMIRE (WF.)	3.409	148,515	1.526	66,458		2,261			1.884	82,057			1.884	82,057							D.B. 137, PG. 546
12	TONY RUMFORD & MICHAEL RUMFORD	71.583	3,118,159		27,415	7,099	4,838	70.954	3,090,744					70.954	3,090,744				1			D.B. 129, PG. 254 D.B. 157, PG. 124
13	CRYSTAL K. SMITH	3.559	155,049		495		10,835			3.548	154,554			3.548	154,554							D.B. 194, PG. 353
14	BRACKEN COUNTY WATER DISTRICT		625		625									0	0							D.B. 156, PG. 87
15	MICHAEL SCHALLER, JR. & DARLA SCHALLER (WF.), DAVID D. COMBS & ROSE COMBS (WF.)	71.663	3,121,638		39,379		5,194	70.759	3,082,259					70.759	3,082,259							D.B. 174, PG. 352
16	ROGER CARL & MARLENE CARL (WF.)	2.666	116,113				4,851			2.666	116,113			2.666	116,113							D.B. 160, PG. 114
17	TAMMY LA'NAI POE	1.012	44,089		13,329		3,259		30,760						30,760				1		1	D.B. 191, PG. 124
18	TERRY S. BURTON, JR.	49.225	2,144,230	3.436	149,660		11,093	45.789	1,994,570					45.789	1,994,570					1		D.B. 147, PG. 117
19	ERIC R. FEGAN ENTERPRISES, LLC.	1.003	43,684				2,106			1.003	43,684			1.003	43,684							D.B. 175, PG. 634 D.B 188, PG.438
20	KENTUCKY GAS TRANSMISSION CORPORATION		8,851		3,858		808		4,993						4,993							D.B. 89, PG. 264
21	TRENT RUMFORD	26.362	1,148,337				2,502			26.362	1,148,337			26.362	1,148,337							D.B. 171, PG. 598
22	TROY TUCKER	1.005	43,779				2,711			1.005	43,779			1.005	43,779							D.B. 167, PG. 526
23	WILLIAM G. STEWART & JUDITH ANN STEWART (WF.)		32,521				1,935				32,521				32,521							D.B. 113, PG. 78
24	WILLIAM W. ELLISON & NORMA ELLISON (WF.)	5.717	249,033				1,514			5.717	249,033			5.717	249,033							D.B. 153, PG. 638
25	DIANE REYNOLDS		25,450				2,420				25,450				25,450							D.B. 116, PG. 570; D.B. 97, PG. 722; D.B. 91, PG. 218
26	JASON H. SNAPP & AMY R. SNAPP (WF.)	1.005	43,769				983			1.005	43,769			1.005	43,769							D.B. 146, PG. 578
27	JEFFERY STIEN & THERESA STIEN (WF.)		13,508		8,578				4,930						4,930				1			D.B. 176, PG. 4
28	PAUL S. PUGH, II & CASSIE L. FUTRAN	1.424	62,042				4,141			1.424	62,042			1.424	62,042							D.B. 181, PG. 518
29	MICHAEL COOPER		27,198		20,123		4,358		7,075						7,075				1		1	D.B. 147, PG. 426
30	HAROLD MAINS & MARGIE MAINS (WF.)		35,314		4,485	5,973	5,589				30,829				30,829						1	D.B. 167, PG. 94
31	ERIC R. FEGAN ENTERPRISES, LLC.	4.751	206,939	1.299	56,585		14,229			3.452	150,354			3.452	150,354				1		Ţ	D.B. 194, PG. 79

NOTE: PERMANENT R/W ACQUIRED + AREA SEVERED = TOTAL AREA OF TRACT.

NOTE: PRIVATE SEWER SYSTEMS WERE NOT LOCATED BY SURVEYS. THEREFORE, IT IS UNKNOWN IF ANY ARE LOCATED ON PARCELS OR ARE AFFECTED BY PROJECT.



TYPE SEWER SYSTEM

1. PRIVATE - INDIVIDUAL

2. PRIVATE - MULTI PARTY

3. PUBLIC

4. NONE

5. NOT APPLICABLE

BUILDINGS ACQUIRED CODE C - COMMERICAL

C - COMMERICAL R - RESIDENTIAL F - FARM S - STORAGE \*INCLUDES HAZARDOUS WASTE (ust - underground storage tanks)

RIGHT OF WAY SUMMARY SHEET

COUNTY OF	ITEM NO.	SHEET NO.
BRACKEN	6-8311.00	R30

### RIGHT OF WAY SUMMARY

SEE	NOTE

		TOTAL ADD		PERMANENT F		EASE	MENTS	AREA SEVERED				EV.0E00 P.		PORTION		SEE SE	WER S'	/STEM	BUILDINGS ACQUIRED		$\top$	
PARCEL	OWNER(S)	TOTAL ARE	EA OF TRACT	PERMANENT	W ACQUIRED	PERMANENT	TEMPORARY	LE	LEFT R			EXCESS FUR	URCHASED	PORTION	REMAINING	SEWER	AFFEC BY PRO	TED		NGS ACQUIRED NUMBER	SOURCE OF TITLE	REMARKS
NO.		ACRES	SQ. FT.	ACRES	SQ. FT.	SQ. FT.	SQ. FT.	ACRES	SQ. FT.	ACRES	SQ. FT.	ACRES	SQ. FT.	ACRES	SQ. FT.	TYPE			c	R F S	-	
32	HAROLD MAINS & MARGIE MAINS (WF.)		15,453				2,972		15,453						15,453				十		D.B. 87, PG. 318	
33	BILLY D. ELLIS & MILDRED A. ELLIS (WF.)	2.822	122,941		6,522		2,974	2.673	116,419					2.673	116,419				十		D.B. 190, PG. 236	
34	BERNARD MARVIN CHRISTY & RUTH CHRISTY (WF.)		21,645		9,835		1,002		11,810						11,810					1	D.B. 83, PG. 132	
35	LUCILLE CHRISTY	3.608	157,154	1.941	84,548		2,390	1.667	72,606					1.667	72,606						D.B. 149, PG. 161	
36	STEVEN BRADLEY TUCKER	7.271	316,742				415			7.271	316,742			7.271	316,742						D.B. 176, PG. 576 D.B. 180, PG. 192	
37	JOSEPH BRENT HAY & RHONDA K. HAY (WF.)	7.060	307,544		9,409		5,951			6.844	298,135			6.844	298,135						D.B. 135, PG. 423	
38	STEVE LENOX & LINDA LENOX (WF.), RICHARD LENOX & JERIANN R. LENOX (WF.)		19,746		60		3,573				19,686				19,686						D.B. 121, PG. 85	
39	JERRY L. ANDERSON	1.510	65,774		13,693		1,500	1.196	52,081					1.196	52,081						D.B. 179, PG. 238	
40	RONALD A. NEELEY & DEBRA L. NEELEY (WF.)	2.682	116,811		17,258		6,007	2.285	99,553					2.285	99,553						D.B. 173, PG. 9 D.B. 179, PG. 355	
41	PHYLLIS N. PARSONS	6.608	287,843	1.789	77,927		894			4.819	209,916			4.819	209,916						D.B. 180, PG. 391	
42	BOBBY ANDERSON & MARLENE ANDERSON (WF.)	1.113	48,476		26,464		658		22,012						22,012						D.B. 167, PG. 401	
43	RICKEY A. FLORER & TAMARA D. FLORER (WF.)	1.001	43,600		4,105		781		39,495						39,495						D.B. 170, PG. 529	
44	ERIC R. FEGAN ENTERPRISES, LLC. & TERRY S. BURTON, JR.	21.551	938,753	3.237	140,984		1,880	17.783	774,606		23,163			18.314	797,769						D.B. 199, Pg. 577	
45	JoANN CAMPBELL & MICHAEL JAY CAMPBELL	5.162	224,873		10,705		12,364			4.917	214,168			4.917	214,168						D.B. 199, Pg. 466	
46	PERRY POE & WANDA JOYCE POE		21,951				3,764				21,951				21,951						D.B. 97, Pg. 515	
47	BETTY BAKER		29,370				1,972				29,370				29,370						D.B. 185, PG. 670	
50	VERNON DALE WOLFE	1.076	46,861		20,552		1,211		26,309						26,309					1	D.B. 145, PG. 138	
51	ROBERT A. COOPER & IDA LEE COOPER (WF.)	62.113	2,705,628	1.204	52,438		13,213	60.909	2,653,190					60.909	2,653,190					1	D.B. 83, PG. 559	
55	MORGAN ISHMAEL	8.700	378,963	1.584	68,978		2,958	7.116	309,985					7.116	309,985					1	D.B. 198, PG. 749	
57	ROBERT P. TAYLOR & STEPHANIE L. TAYLOR (WF.)	24.862	1,082,987	3.886	169,260	7,029	3,811	20.963	913,144		583			20.976	913,727					2	D.B. 173, PG. 204	
59	STAN MITIC, JR.		28,587		22,857				5,730						5,730					1 1	D.B. 175, PG. 637 D.B. 177, PG. 24	
61	RICHARD D. BADGER & VIRGINIA BADGER (WF.)	13.208	575,324		38,974		4,627	12.259	533,990		2,360			12.313	536,350						D.B. 108, PG. 167	
63	SIMON L. JEWELL & CATHERINE J. JEWELL (WF.)	152.620	6,648,120				2,837			152.620	6,648,120			152.620	6,648,120						D.B. 152, PG. 409	
64	CHRIS PULLIAM & DOROTHY PULLIAM	1.036	45,146		34,288		1,721		10,858						10,858					1	D.B. 187, PG. 669	
65	G.T. HARDING & NAUVA JUNE HARDING (WF.)	43.805	1,908,159	5.433	236,680		5,677	38.000	1,655,280		16,199			38.372	1,671,479					1	D.B. 95, PG. 631	
66	G.T. HARDING & NAUVA JUNE HARDING (WF.)	24.797	1,080,162	3.576	155,792		261		15,462	20.866	908,908			21.221	924,370						D.B. 95, PG. 631	
68	GARY W. FRYMAN & TAMMY A. FRYMAN (WF.)	3.155	137,424	1.336	58,192			1.819	79,232					1.819	79,232						D.B. 136, PG. 478	
76	BRIAN K. THOMAS	1.244	54,200		18,993				35,207						35,207						D.B. 175, PG. 375	
80	ANTHONY WAYNE HUTCHISON & ANN HUTCHISON (WF.)	32.665	1,422,907	5.397	235,078		2,561		33,012	26.511	1,154,817			27.269	1,187,829						D.B. 183, PG. 619	
82	ANTHONY WAYNE HUTCHISON & ANN HUTCHISON (WF.)	15.572	678,298		10,429		8,820	15.332	667,869					15.332	667,869						D.B. 183, PG. 619	

NOTE: PERMANENT R/W ACQUIRED + AREA SEVERED = TOTAL AREA OF TRACT.

NOTE: PRIVATE SEWER SYSTEMS WERE NOT LOCATED BY SURVEYS. THEREFORE, IT IS UNKNOWN IF ANY ARE LOCATED ON PARCELS OR ARE AFFECTED BY PROJECT.



TYPE SEWER SYSTEM

1. PRIVATE - INDIVIDUAL

2. PRIVATE - MULTI PARTY

3. PUBLIC

4. NONE

5. NOT APPLICABLE

BUILDINGS ACQUIRED CODE C - COMMERICAL

C - COMMERICAL R - RESIDENTIAL F - FARM S - STORAGE \*INCLUDES HAZARDOUS WASTE (ust - underground storage tanks)

RIGHT OF WAY SUMMARY SHEET

COUNTY OF	ITEM NO.	SHEET NO.
BRACKEN	6-8311.00	R31

### RIGHT OF WAY SUMMARY

SEE	NOTE

		1		T		FASFN	MENTS		ΔRFΔ S	EV ERED							NOTE EWER SYS	TEM			
PARCE		TOTAL ARE	EA OF TRACT	PERMANENT F	W ACQUIRED		TEMPORARY	LI	EFT		GHT	EXCESS PU	JRCHASED	PORTION F	REMAINING	SEWER	AFFECT	ED   B	UILDINGS ACQUIRED NUMBER		
NO.	OWNER(S)	ACRES	SQ. FT.	ACRES	SQ. FT.	SQ. FT.	SQ. FT.	ACRES	SQ. FT.	ACRES	SQ. FT.	ACRES	SQ. FT.	ACRES	SQ. FT.	I IYPE I	BY PROJE	NO C		SOURCE OF TITLE	REMARKS
83	EDWARD B. KERN & MARY K. KERN (WF.)	77.333	3,368,625		3,768		5,638	77.246	3,364,857					77.246	3,364,857					D.B. 120, PG. 46	
86	STEVE ROBERTS		20,376				788		20,376						20,376					D.B. 174, PG. 361	
87	CHERYL BUCKLER & RONNIE BEYERSDOERFER	2.075	90,368	1.802	78,511		1,575		6,785		5,072				11,857				1 1 1	D.B. 179,Pg. 174	
88	HAGAR COX & VIRGINIA I. COX (WF.)	12.633	550,289		41,557		4,120			11.679	508,732			11.679	508,732					D.B. 81,Pg. 332	
90	BOBBY ANDERSON & MARLENE ANDERSON (WF.)	11.000	479,160		770			10.982	478,390					10.982	478,390					D.B. 143, Pg. 202	
93	DANIELLE N. COUCH & BRAD A. GIRDLER	3.083	134,297	1.424	62,018				25,344	1.077	46,935			1.659	72,279					D.B. 194, PG. 595	
100	WINDSTREAM KENTUCKY EAST, LLC.		1,173		61		246				1,112				1,112					D.B. 196, PG. 274	
_																					

NOTE: PERMANENT R/W ACQUIRED + AREA SEVERED = TOTAL AREA OF TRACT.

NOTE: PRIVATE SEWER SYSTEMS WERE NOT LOCATED BY SURVEYS. THEREFORE, IT IS UNKNOWN IF ANY ARE LOCATED ON PARCELS OR ARE AFFECTED BY PROJECT.




TYPE SEWER SYSTEM
1. PRIVATE - INDIVIDUAL 2. PRIVATE - MULTI PARTY 3. PUBLIC 4. NONE 5. NOT APPLICABLE


BUILDINGS ACQUIRED CODE C - COMMERICAL R - RESIDENTIAL F - FARM


S - STORAGE

\*INCLUDES HAZARDOUS WASTE (UST - UNDERGROUND STORAGE TANKS)


RIGHT OF WAY SUMMARY SHEET

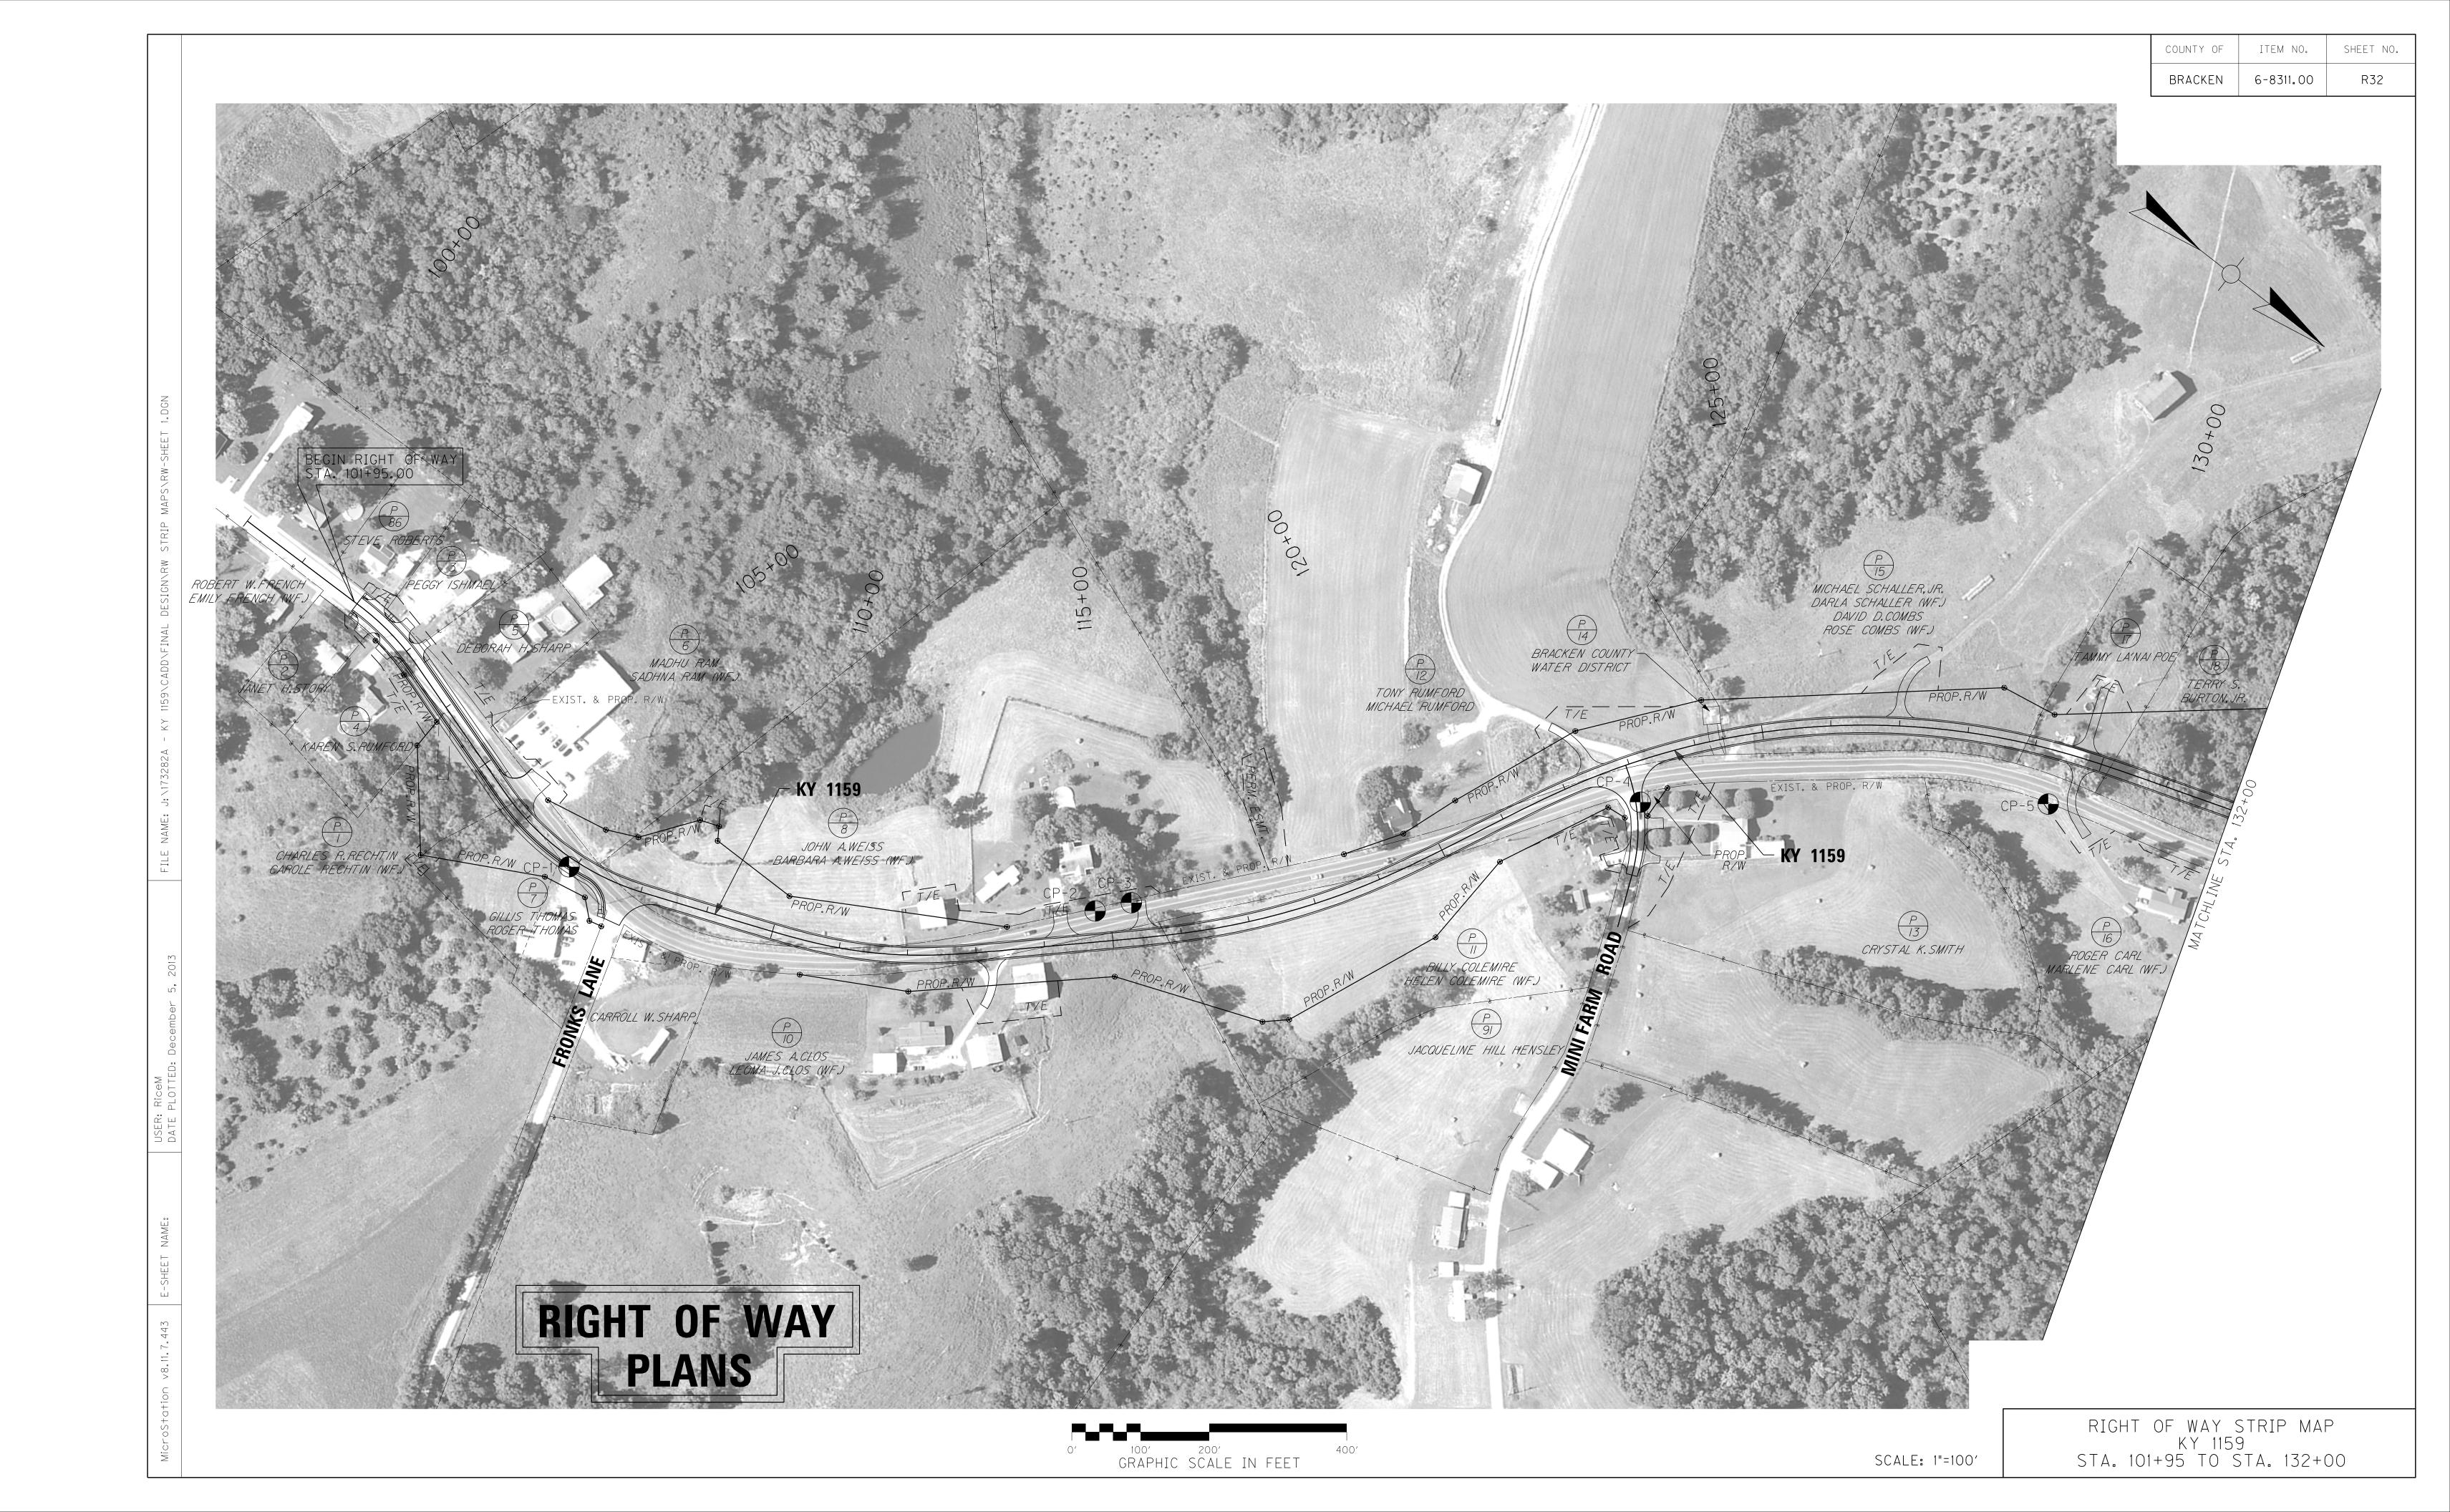

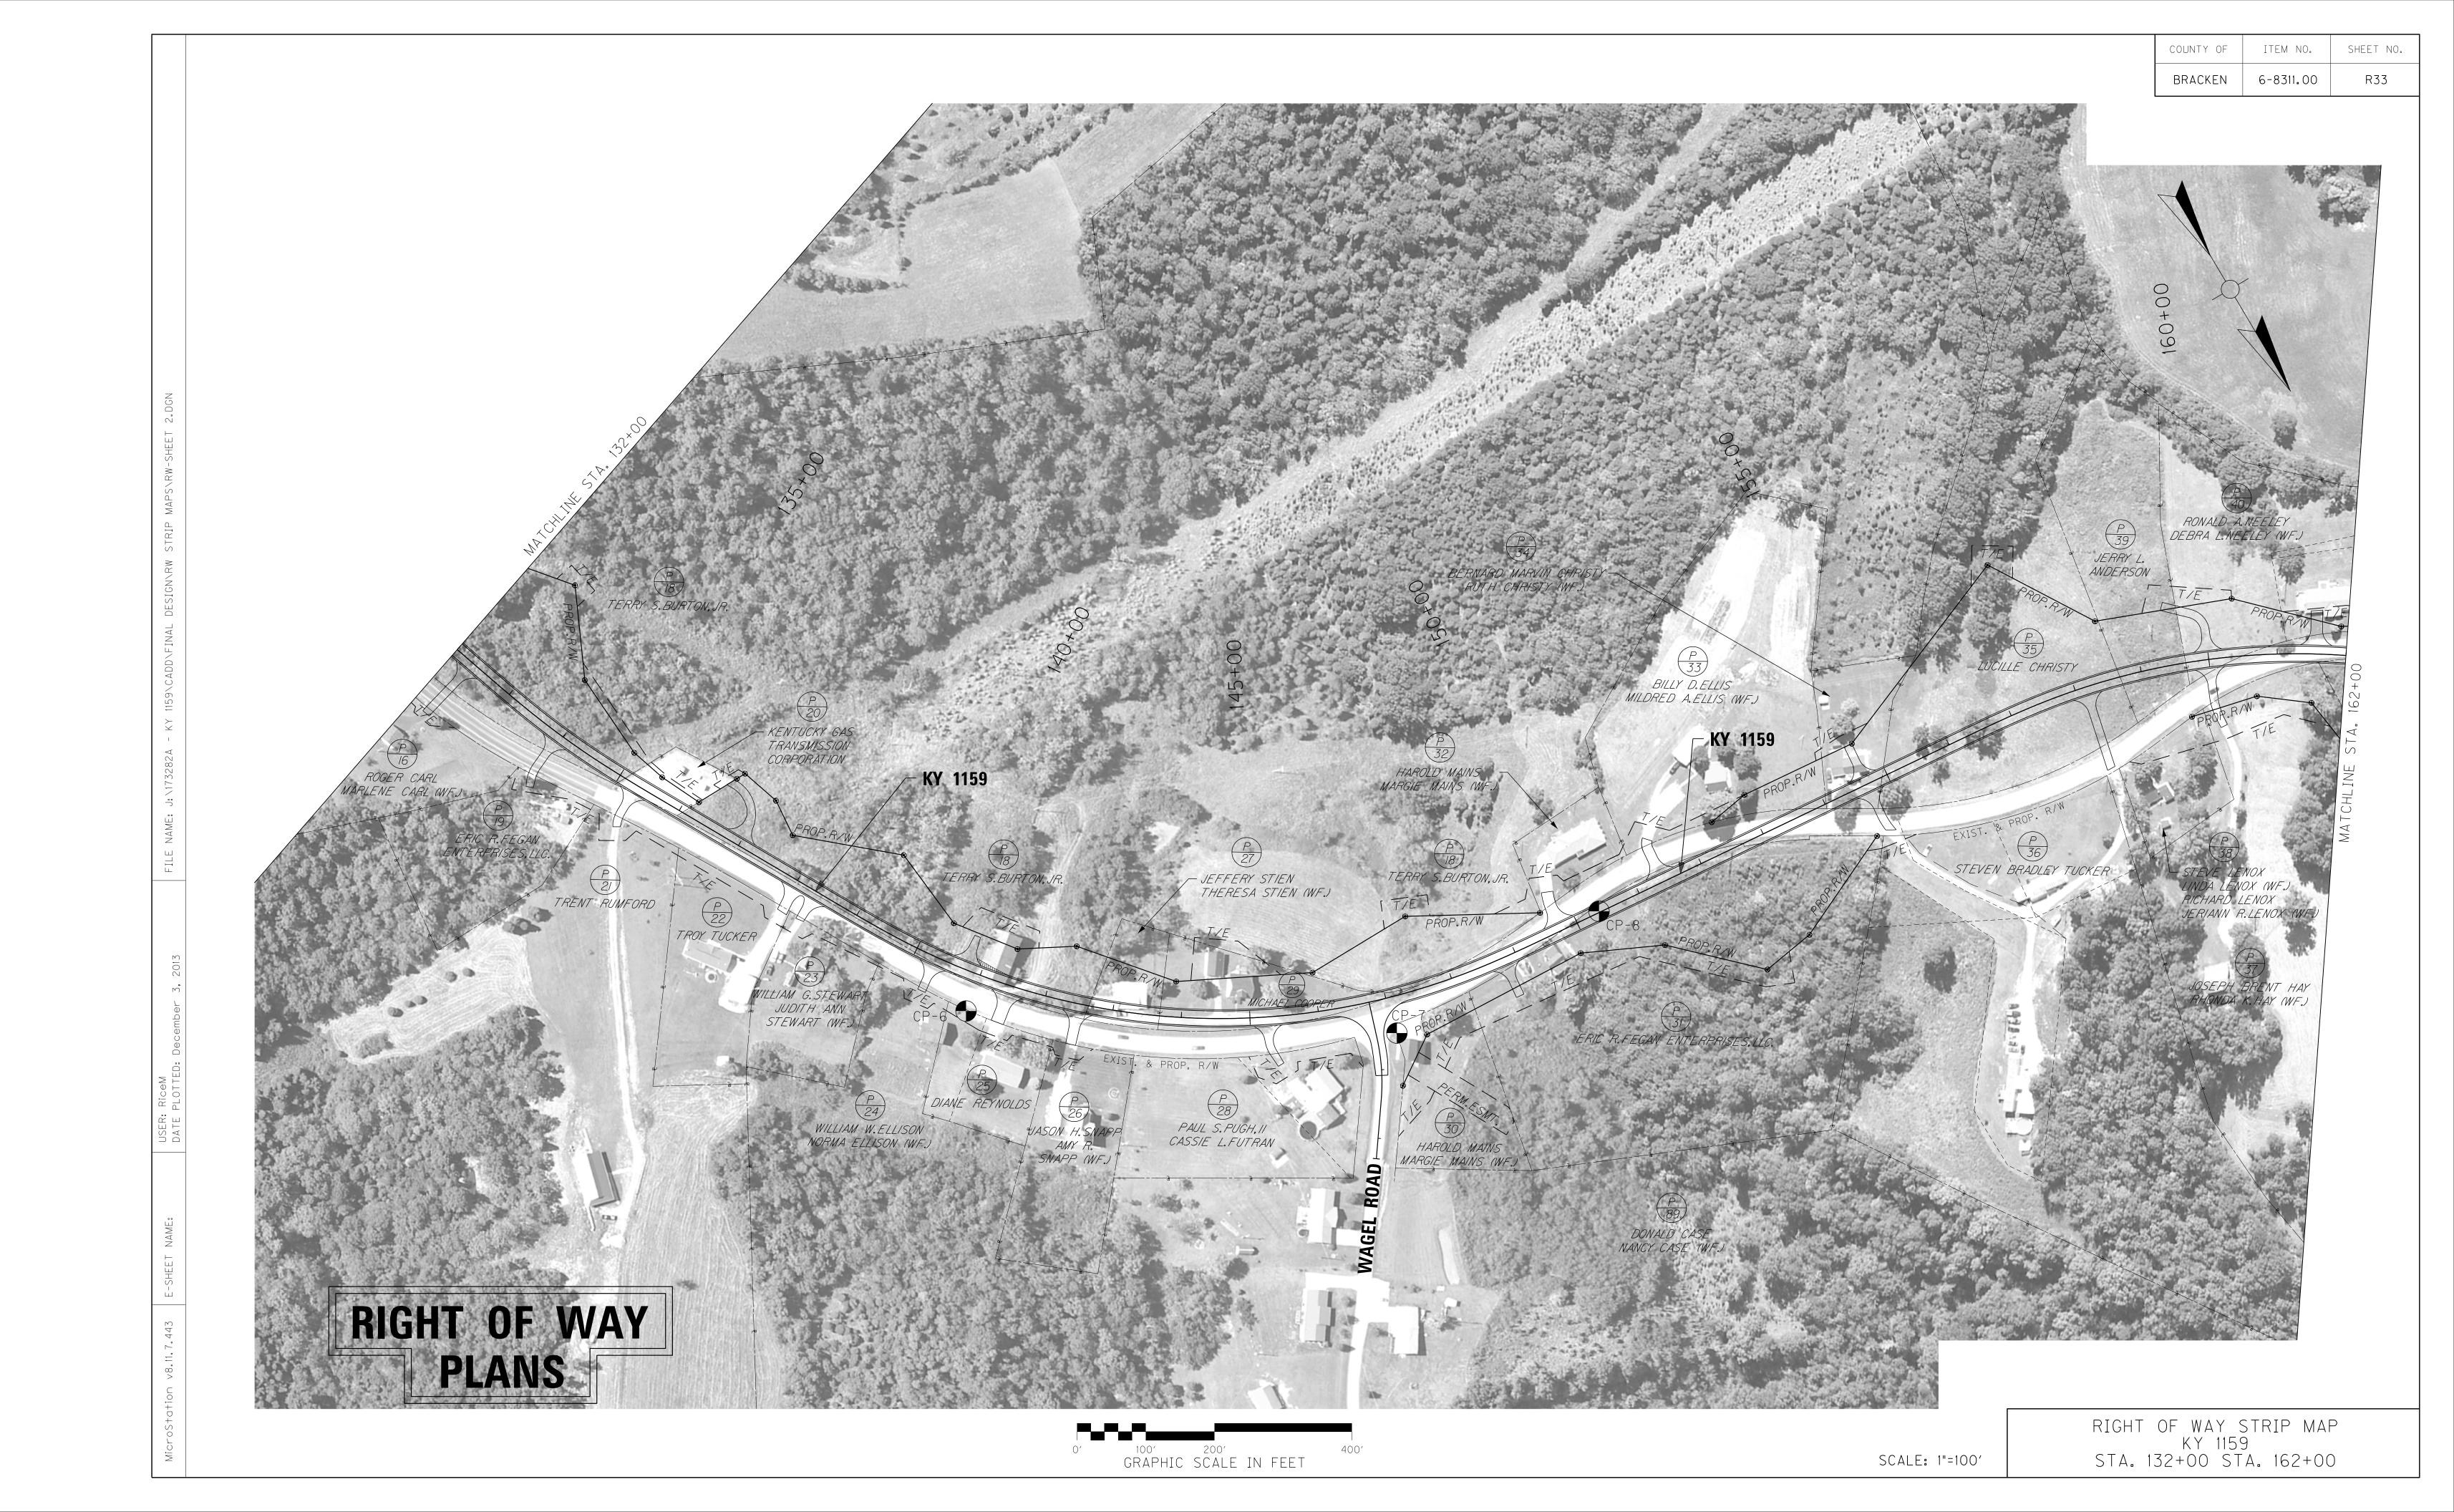

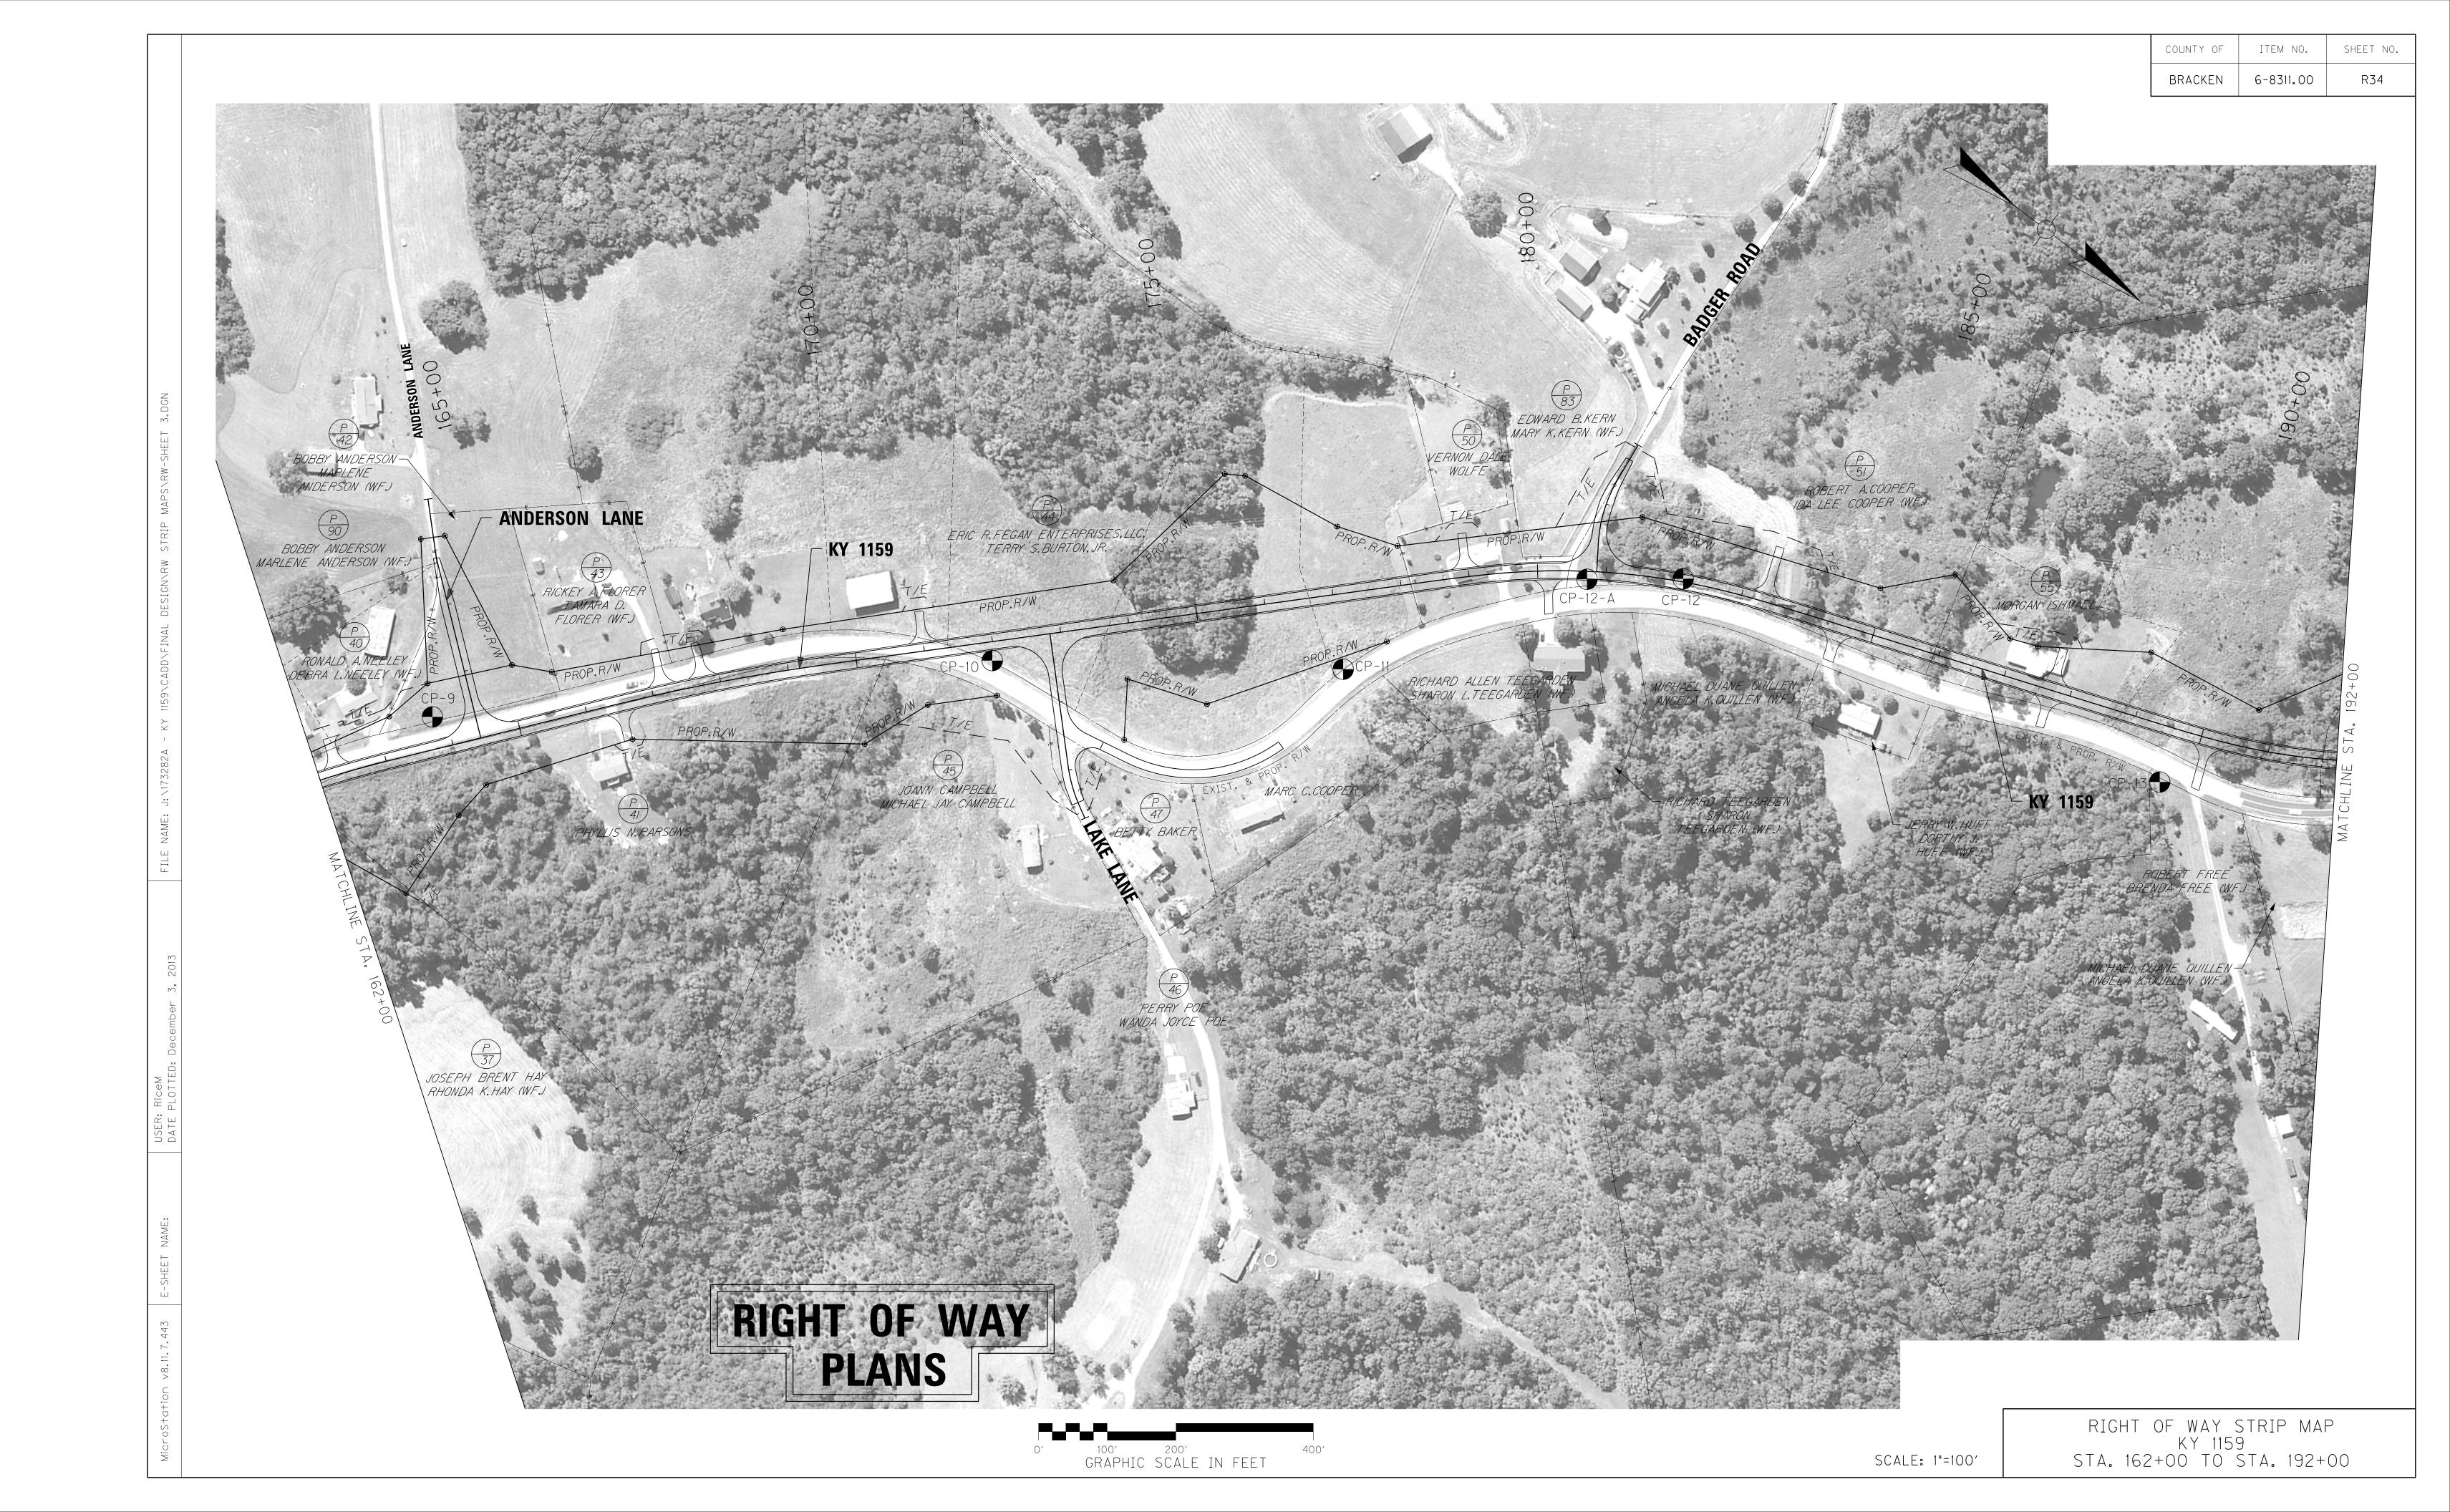

KY 1159 **KY** 1159 RIGHT OF WAY
PLANS RIGHT OF WAY STRIP MAP KY 1159 STA. 192+00 TO STA. 222+00 100' 200' GRAPHIC SCALE IN FEET SCALE: 1"=100'

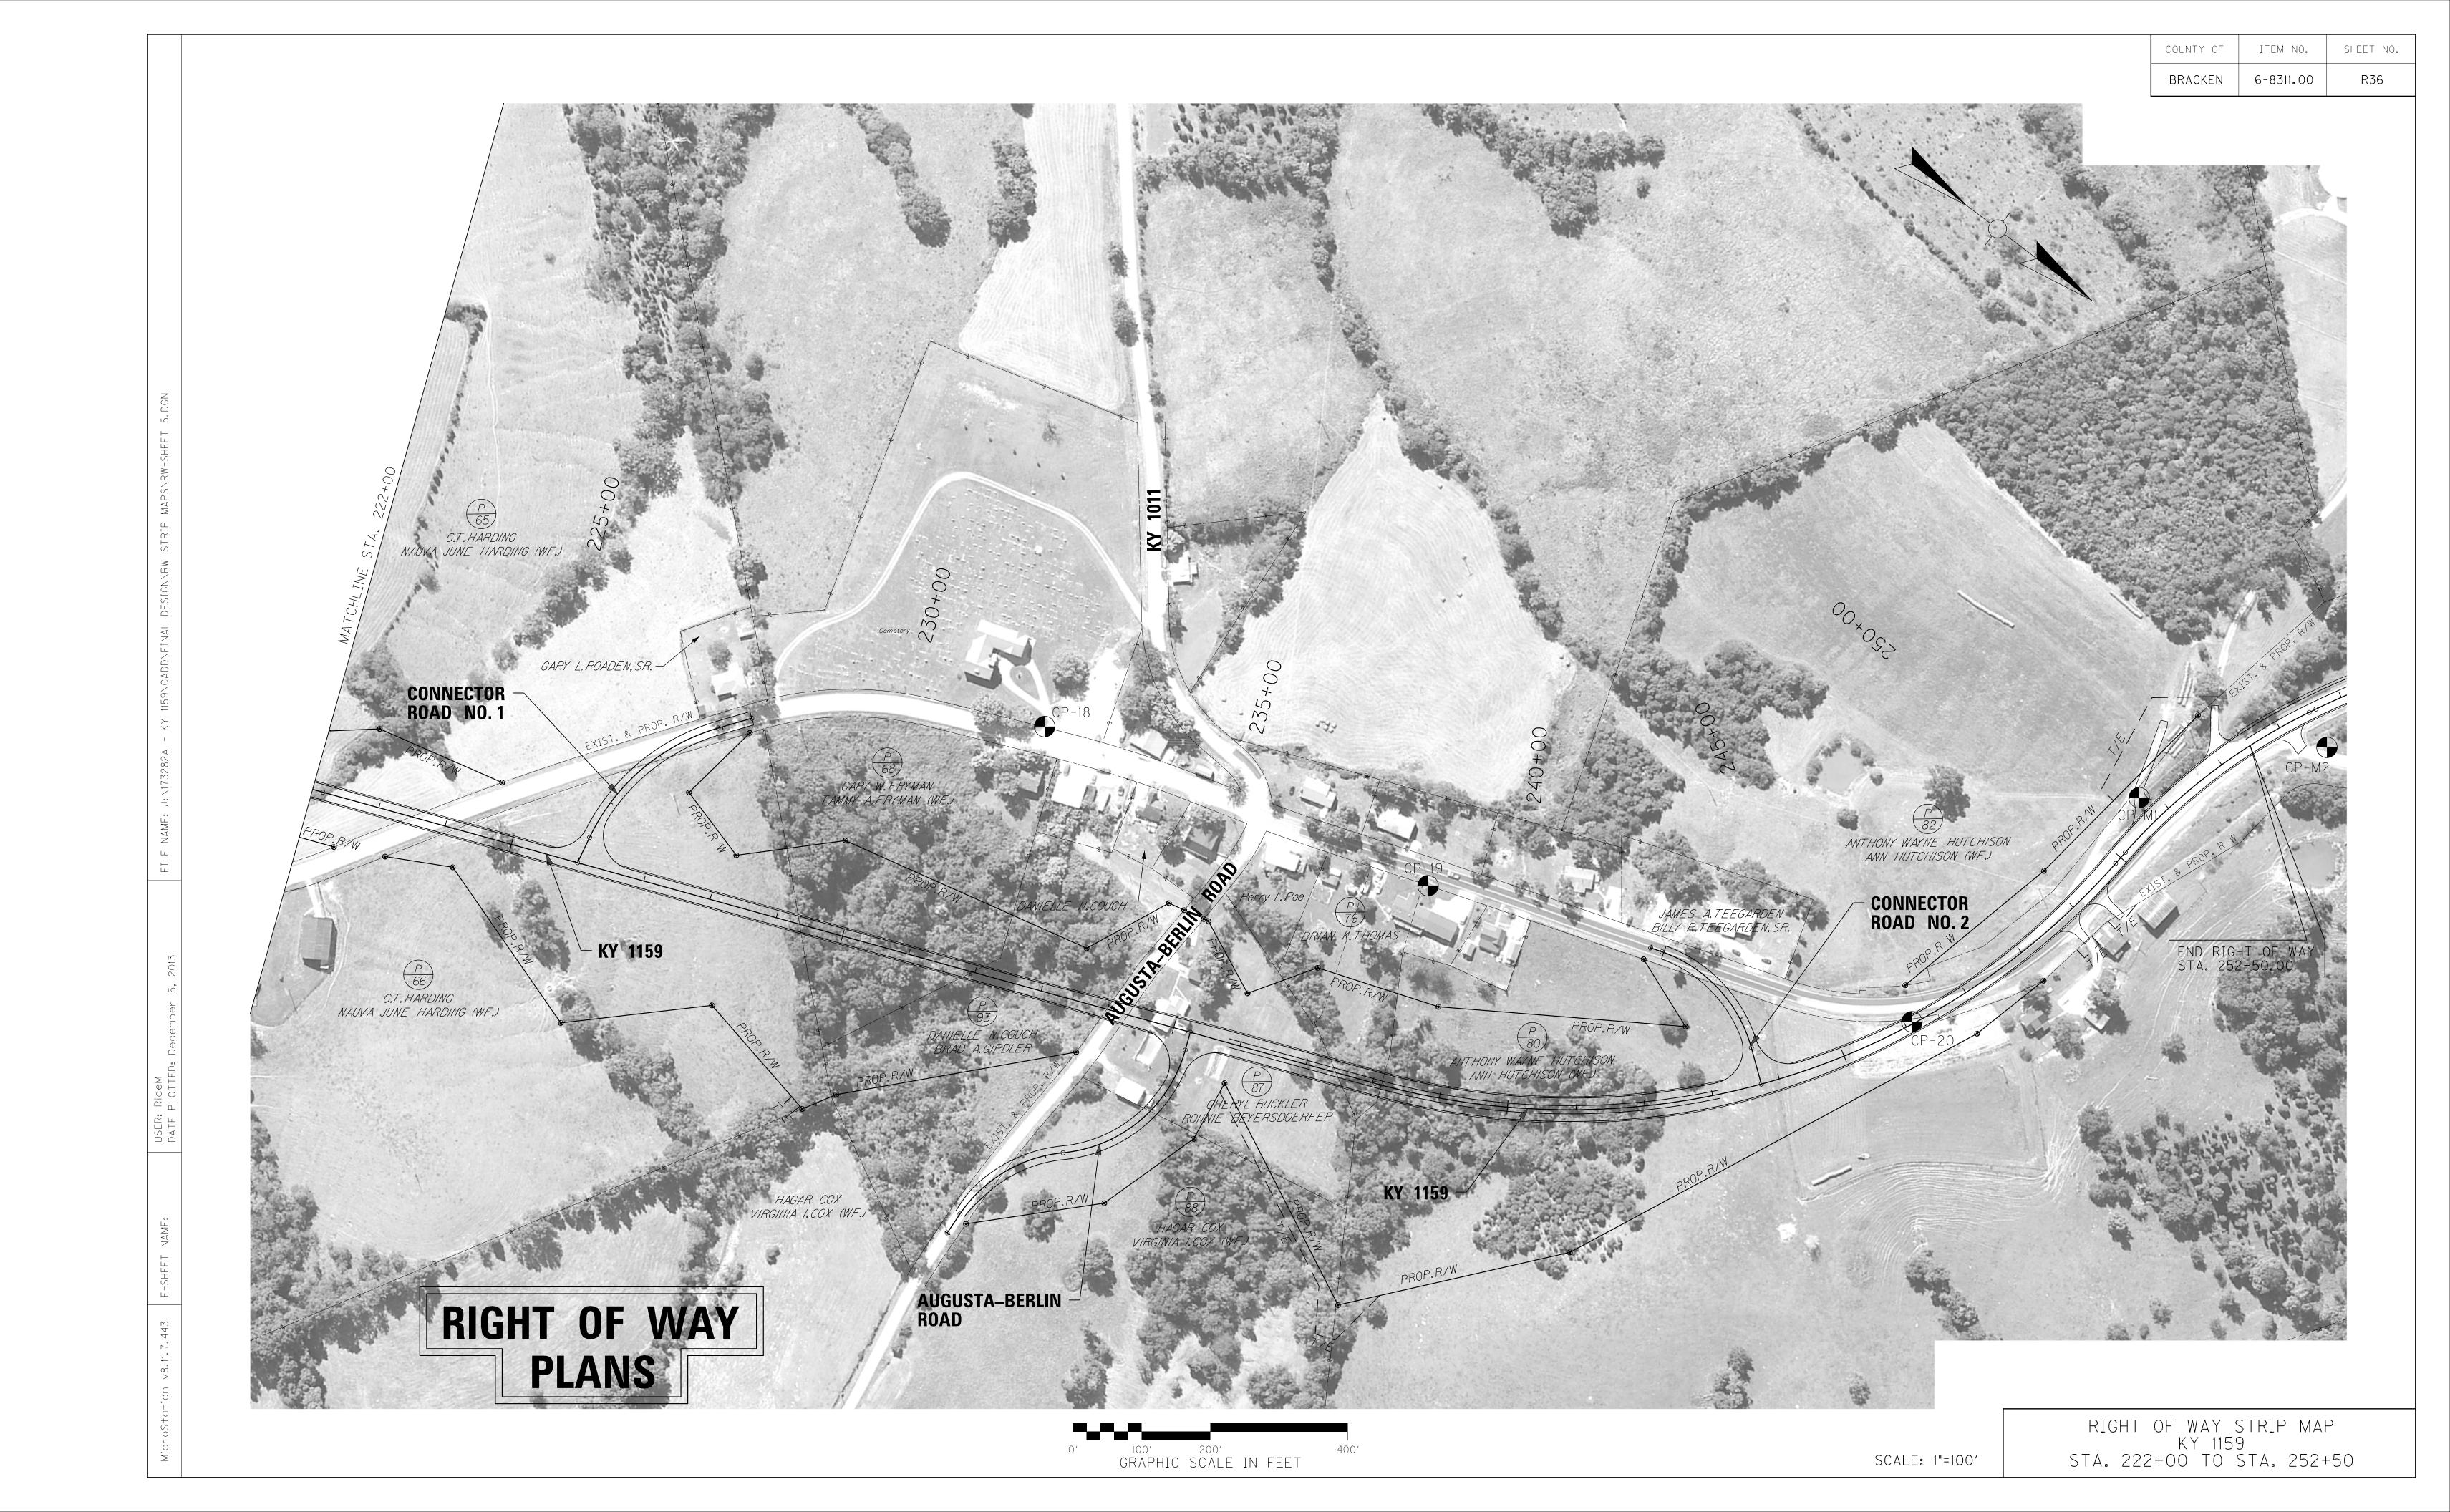

DOINE	DESCRIPTION	Pro	ject Coordin	ates		State Plane	Coordinate
POINT	DESCRIPTION	NORTH (Y)	EAST (X)	ELEV. (Z)	STATION and OFFSET	NORTH (Y)	EAST (X)
CP-1	BRASS DISC IN CONCRETE	4145364.971	5400855.770	928.884	106 + 91.35, 12.13' RIGHT	4145250.517	5400706.651
CP-2	IRON PIN & CAP	4146008.429	5400436.114	938.233	114 + 77.97, 45.12' LEFT	4145893.957	5400287.007
CP-3	BRASS DISC IN CONCRETE	4146042.639	5400394.251	936.217	115 + 31.88, 52.27' LEFT	4145928.166	5400245.145
CP-4	IRON PIN & CAP	4146536.866	5399823.667	940.836	122 + 97.69, 57.71' RIGHT	4146422.379	5399674.577
CP-5	IRON PIN & CAP	4147006.765	5399461.120	908.166	129 + 40.95, 77.95' RIGHT	4146892.265	5399312.040
CP-6	IRON PIN & CAP	4148052.071	5398935.553	916.847	140 + 98.86, 55.98' RIGHT	4147937.542	5398786.487
CP-7	IRON PIN & CAP	4148399.370	5398412.579	909.870	147 + 03.35, 53.03' RIGHT	4148284.832	5398263.582
CP-8	IRON PIN & CAP	4148396.881	5398069.131	909.502	150 + 36.04, 1.64' LEFT	4148282.343	5397920.089
CP-9	IRON PIN & CAP	4148705.456	5396772.313	903.397	163 + 80.74, 46.58' LEFT	4148590.909	5396623.307
CP-10	IRON PIN & CAP	4149305.005	5396214.755	900.245	171 + 96.03, 27.33' RIGHT	4149190.442	5396065.764
CP-11	IRON PIN & CAP	4149719.371	5395916.203	890.064	177 + 00.12, 109.33' RIGHT	4149604.796	5395767.221
CP-12	IRON PIN & CAP	4150033.908	5395512.356	911.274	182 + 11.96, 4.63' LEFT	4149919.325	5395363.385
CP-12-A	BRASS DISC IN CONCRETE	4149922.855	5395597.459	909.986	180 + 72.38, 11.53' RIGHT	4149808.275	5395448.486
CP-13	IRON PIN & CAP	4150765.065	5395328.927	896.625	189 + 60.93, 80.94' RIGHT	4150650.462	5395179.961
CP-14	IRON PIN & CAP	4151157.605	5395073.088	897.719	194 + 01.76, 73.57' RIGHT	4151042.991	5394924.129
CP-15	IRON PIN & CAP	4151626.499	5394618.882	898.928	200 + 68.07, 32.93' RIGHT	4151511.872	5394469.936
CP-16	IRON PIN & CAP	4152340.176	5394387.162	895.218	208 + 23.90, 53.67' RIGHT	4152225.529	5394238.222
CP-17	IRON PIN & CAP	4153352.234	5394110.521	881.301	218 + 69.10, 117.27' RIGHT	4153237.559	5393961.589
CP-18	IRON PIN & CAP	4154415.579	5393166.741	866.102	232 + 02.17, 372.23' LEFT	4154300.875	5393017.835
CP-19	IRON PIN & CAP	4155000.007	5393014.135	847.890	238 + 01.59, 297.80' LEFT	4154885.287	5392865.233
CP-20	IRON PIN & CAP	4155680.581	5392746.375	869.375	246+10.81, 3.23' LEFT	4155565.842	5392597.480
CP-M1	BRASS DISK IN CONCRETE	4155746.968	5392286.801	873.456	250 + 79.92, 40.52' LEFT	4155632.227	5392137.919
CP-M2	BRASS DISK IN CONCRETE	4155920.317	5392063.277	852.265	253 + 49.48, 57.03' RIGHT	4155805.571	5391914.401

\*SEE RIGHT OF WAY STRIP MAP SHEETS FOR PROJECT CONTROL MONUMENT LOCATIONS.

## PROJECT COORDINATES

Coordinates for horizontal control were obtained from GPS methods and adjusted to the National NAD83/FBN System.

Coordinates shown are Project Datum of Ground Coordinates and are in <u>U.S. Survey Feet</u>.

A project datum factor of 1.000027611 was computed to convert the State Plane Coordinates to Project Coordinates.

If State Plane Coordinates are needed, divide the Project Coordinates by the Project Datum Factor.

Coordinates are based on State Plane Coordinate System Single Zone.

## BASIS OF ELEVATIONS

Elevations were derived from NGS/USGS Vertical Control Mark L 34. The Elevation used for this mark is 953.55 and is the basis of elevation for this project. The location of the Benchmark is as follows:

AT THE SOUTH CORNER OF THE COUNTY COURTHOUSE IN BROOKSVILLE, 23.6 FEET SOUTH OF THE SOUTH CORNER OF BUILDING, 17.9 FEET SOUTHWEST OF THE SOUTHWEST WALL OF COURTHOUSE EXTENDED, 15.4 FEET SOUTHEAST OF THE SOUTHEAST WALL OF THE OFFSET PORTION EXTENDEED, 4.2 FEET SOUTH OF THE EDGE OF SIDEWALK AT A CURVE, 3 INCHES BELOW THE LEVEL OF THE SIDEWALK, 1 INCH UNDERGROUND.

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KY 1159				
6.7	TATION	PROJECT COORDINATES		
3.1	IATION	EAST (X)	NORTH (Y)	
РОВ	100+00.00	5400746.496	4144686.494	
PC	102+04.68	5400743.414	4144891.151	
PΙ	102 + 65.75	5400742.494	4144952.217	
PT	103 + 25.79	5400760.756	4145010.497	
PC	105 + 48.31	5400827.291	4145010.497	
PΙ	106 + 81.19	5400867.025	4145349.638	
PT	108 + 03.98	5400819.077	4145473.571	
T S	109 + 59.12	5400763.096	4145618.267	
SC	110 + 92.12	5400710.992	4145740.570	
PI	111 + 53.47	5400692.970	4145799.522	
CS	112 + 11.32	5400647.742	4145841.409	
ST	113 + 44.32	5400560.315	4145941.557	
T S	114 + 85.76	5400463.772	4146044.926	
SC	116 + 38.76	5400356.717	4146154.185	
PI	117 + 67.31	5400271.598	4146250.687	
ST	120 + 43.58	5400016.800	4146370.460	
T S	120 + 72.44	5399990.685	4146382.736	
SC	122 + 25.44	5399853.850	4146451.104	
PI	126 + 06.76	5399507.123	4146610.043	
CS	129 + 36.57	5399390.628	4146973.237	
ST	130 + 89.57	5399339.050	4147117.244	
TS	132 + 29.25	5399295.113	4147249.833	
SC	133 + 63.25	5399250.609	4147376.207	
PI	134 + 05.76	5399239.590	4147417.387	
CS	134 + 47.57	5399216.930	4147453.494	
ST	135 + 81.57	5399154.667	4147572.130	
T S	138 + 50.93	5399025.076	4147808.264	
SC	139 + 94.93	5398952.803	4147932.775	
PI	144 + 57.04	5398733.470	4148339.613	
CS	148 + 31.35	5398272.790	4148377.000	
ST	149 + 75.35	5398129.733	4148393.155	
TS	156 + 09.91	5397497.657	4148449.210	
SC	157 + 53.91	5397354.600	4148465.365	
PI	159 + 86.64	5397122.397	4148482.489	
C S	162 + 01.03	5396943.483	4148631.488	
ST	163 + 45.03	5396829.361	4148719.253	
T S	165 + 96.64	5396633.651	4148877.380	
SC	166 + 78.64	5396570.104	4148929.204	
PΙ	167 + 96.21	5396478.416	4149002.804	
CS	169 + 13.48	5396395.526	4149086.188	

	KY 1159				
	TA TILON	PROJECT COC	RDINATES		
S	FATION	EAST (X)	NORTH (Y)		
ST	169 + 95.48	5396337.269	4149143.894		
TS	178 + 22.97	5395752.023	4149728.899		
SC	179 + 66.97	5395652.674	4149833.092		
PI	181 + 17.19	5395543.940	4149936.897		
CS	182 + 59.95	5395495.847	4150079.326		
ST	184 + 03.95	5395443.435	4150213.413		
TS	189 + 16.86	5395268.225	4150695.463		
SC	190 + 60.86	5395215.459	4150829.402		
PI	191 + 83.19	5395177.247	4150945.769		
CS	192 + 99.27	5395088.971	4151030.673		
ST	194 + 43.27	5394991.174	4151136.314		
T S	196 + 99.12	5394812.420	4151319.364		
SC	198 + 43.12	5394714.336	4151424.749		
PΙ	199 + 98.97	5394602.927	4151533.891		
CS	201 + 46.82	5394556.290	4151682.717		
ST	202 + 90.82	5394506.948	4151817.964		
PC	216 + 84.22	5394060.933	4153138.047		
PΙ	219 + 49.94	5393975.876	4153389.793		
PT	222 + 15.55	5393877.569	4153636.667		
PC	238+04.09	5393289.879	4155112.506		
PΙ	244+66.89	5393044.676	4155728.275		
PT	249 + 88.75	5392383.707	4155777.435		
PC	250+10.25	5392362.266	4155779.030		
PΙ	251 + 81.60	5392191.385	4155791.739		
PT	253 + 48.52	5392038.425	4155868.973		
PC	253 + 59.58	5392028.553	4155873.958		
PΙ	258+06.22	5391629.859	4156075.270		
PT	261 + 91.19	5391541.435	4156513.066		
PC	271 + 56.92	5391350.241	4157459.685		
PΙ	274 + 98.16	5391282.684	4157794.166		
PT	277 + 97.40	5391490.464	4158064.848		
PC	279 + 57.61	5391588.016	4158191.932		
PI	280 + 83.56	5391664.707	4158291.840		
PT	282+09.48	5391737.754	4158394.442		
PC	282 + 19.44	5391743.533	4158402.558		
PΙ	283 + 40.13	5391813.528	4158500.873		
PT	284 + 55.62	5391826.969	4158620.808		
POE	286 + 30.46	5391846.442	4158794.558		





MINI FARM ROAD						
PROJECT COORDINATES						
3	TATION	EAST (X)	NORTH (Y)			
POB	50+00.00	5399794.386	4146487.063			
PC	50+13.08	5399801.514	4146498.025			
PI	50 + 90.34	5399843.628	4146562.797			
PT	51 + 62.94	5399914.943	4146592.515			
POE	52 + 41.33	5399987.301	4146622.668			

BADGER ROAD					
C	TATION	PROJECT CO	OORDINATES		
STATION		EAST (X)	NORTH (Y)		
РОВ	48 + 02.22	5395396.860	4149864.094		
PC	48 + 61.09	5395455.328	4149870.916		
PI	49 + 11.07	5395504.974	4149876.709		
PT	49 + 59.14	5395546.382	4149904.703		
POE	50+00.00	5395580.234	4149927.589		

	WAGEL ROAD					
6.7		PROJECT C	OORDINATES			
5 1	TATION	EAST (X)	NORTH (Y)			
РОВ	50+00.00	5398424.555	4148340.081			
PC	50 + 54.47	5398441.525	4148391.845			
PI	50 + 99.12	5398455.434	4148434.269			
PT	51 + 43.09	5398481.273	4148470.677			
POE	52 + 29.84	5398531.480	4148541.422			

CONNECTOR ROAD NO.1						
		PROJECT CO	OORDINATES			
5	TATION –	EAST (X)	NORTH (Y)			
POB	46 + 55.27	5393414.718	4154068.780			
PC	47 + 06.23	5393455.634	4154038.398			
PI	48 + 40.77	5393563.649	4153958.192			
PT	49 + 59.17	5393695.384	4153985.504			
POE	50+00.00	5393735.359	4153993.792			

	ANDERSON LANE					
6.7		PROJECT COORDINATES				
51	TATION	EAST (X)	NORTH (Y)			
POB	46 + 43.82	5396523.786	4148508.802			
PI	47 + 30.50	5396584.798	4148570.376			
POE	50+00.00	5396754.171	4148780.004			

	AUGUSTA-BERLIN ROAD				
0.7		PROJECT C	OORDINATES		
81	TATION	EAST (X)	NORTH (Y)		
POB	50+00.00	5393393.152	4154853.163		
PC	50 + 27.00	5393418.236	4154863.152		
PI	51 + 67.90	5393549.143	4154915.280		
PRC	52 + 73.89	5393644.714	4154811.741		
PI	53 + 70.30	5393710.104	4154740.900		
PT	54 + 54.12	5393806.371	4154746.082		
POE	54 + 87.18	5393839.382	4154747.860		

LAKE LANE						
PROJECT COORDINATES						
STATION		EAST (X)	NORTH (Y)			
POB	50+00.00	5396132.913	4149348.166			
PC	51 + 95.12	5396270.856	4149486.165			
PI	52+24.21	5396291.422	4149506.739			
PT	52 + 52.93	5396305.620	4149532.130			
POE	52 + 74.47	5396316.133	4149550.929			

CONNECTOR ROAD NO. 2					
6.7		PROJECT CO	OORDINATES		
5 1	TATION	EAST (X)	NORTH (Y)		
РОВ	47 + 29.28	5392890.421	4155312.689		
PC	47 + 46.83	5392885.039	4155329.394		
PI	48 + 54.47	5392852.028	4155431.854		
PT	49 + 45.07	5392917.633	4155517.198		
POE	50+00.00	5392951.109	4155560.745		

BADGER ROAD							
C.		PROJECT CO	ORDINATES				
STATION		EAST (X)	NORTH (Y)				
POB	48 + 02.22	5395396.860	4149864.094				
PC	48 + 61.09	5395455.328	4149870.916				
PI	49 + 11.07	5395504.974	4149876.709				
PT	49 + 59.14	5395546.382	4149904.703				
POE	50+00.00	5395580.234	4149927.589				

BRACKEN 6-8311.00

GEOMETRIC COORDINATE DATA SHEET

FILE NAME: J:N173282A - KY 1159\CADD\FINAL DESIGN\GEOMETRIC DATA\GEOMETRIC COORDINATE DATA SHEET.DGN

USER: RiceM DATE PLOTTED: December 3, 20

I3 E-SHEET NAME:

roStation v8.11.7.443 E-SHEET

		RIGHT OF W	YAY MONUMENT	POINTS			
				PROJECT GRID	COORDINATES	STATE PLANE	COORDINATE
ROUTE	STATION AND OFFSET	TYPE	DESCRIPTION	NORTH (Y)	EAST (X)	NORTH (Y)	EAST (X
KY 1159	23.00' RT. STA. 102 + 57.06	R/W MARKER TYPE 1	ALUMINUM DISK	4144940.5968	5400769.0585	4144826.1540	5400619.9420
KY 1159	23.00' RT. STA. 103 + 25.79	R/W MARKER TYPE 1	ALUMINUM DISK	4145003.6197	5400782.7037	4144889.1752	5400633.5868
KY 1159	23.00' RT. STA. 104 + 09.50	R/W MARKER TYPE 1	ALUMINUM DISK	4145083.4996	5400807.7338	4144969.0529	5400658.6162
KY 1159	65.74' RT. STA. 104 + 21.67	R/W MARKER TYPE 1	ALUMINUM DISK	4145082.3295	5400852.1607	4144967.8828	5400703.0419
KY 1159	152.67' RT. STA. 105 + 53.41	R/W MARKER TYPE 1	ALUMINUM DISK	4145184.0288	5400975.0665	4145069.5793	5400825.9443
KY 1159	42.06' LT. STA. 106 + 01.46	R/W MARKER TYPE 1	ALUMINUM DISK	4145281.3548	5400798.0891	4145166.9026	5400648.9718
KY 1159	44.14' RT. STA. 106 + 72.33	R/W MARKER TYPE 1	ALUMINUM DISK	4145346.0950	5400888.7090	4145231.6410	5400739.5892
KY 1159	62.16' LT. STA. 107 + 08.78	R/W MARKER TYPE 1	ALUMINUM DISK	4145374.0744	5400780.2871	4145259.6196	5400631.1703
KY 1159	38.45' RT. STA. 107 + 31.38	R/W MARKER TYPE 1	ALUMINUM DISK	4145410.5970	5400876.5022	4145296.1412	5400727.382
KY 1159	66.27' RT. STA. 107 + 49.84	R/W MARKER TYPE 1	ALUMINUM DISK	4145436.7623	5400899.5319	4145322.3058	5400750.4118
KY 1159	66.59' RT. STA. 107 + 65.91	R/W MARKER TYPE 1	ALUMINUM DISK	4145455.1431	5400895.2103	4145340.6861	5400746.090
KY 1159	73.69° LT. STA. 107 + 66.47	R/W MARKER TYPE 1	ALUMINUM DISK	4145418.2964	5400759.8507	4145303.8404	5400610.734
KY 1159	125.02' LT. STA. 108 + 52.39	R/W MARKER TYPE 1	ALUMINUM DISK	4145473.6153	5400685.0044	4145359.1578	5400535.890
KY 1159	124.42' LT. STA. 108 + 81.37	R/W MARKER TYPE 1	ALUMINUM DISK	4145500.8534	5400675.1093	4145386.3951	5400525.995
KY 1159	103.49' LT. STA. 108 + 85.70	R/W MARKER TYPE 1	ALUMINUM DISK	4145512.4454	5400693.0731	4145397.9868	5400543.958
KY 1159	56.44' LT. STA. 110 + 09.71	R/W MARKER TYPE 1	ALUMINUM DISK	4145644.2214	5400692.2787	4145529.7592	5400543.164
KY 1159	49.98' RT. STA. 110 + 53.60	R/W MARKER TYPE 1	ALUMINUM DISK	4145726.1542	5400773.1576	4145611.6897	5400624.041
KY 1159	52.98' RT. STA. 112 + 02.57	R/W MARKER TYPE 1	ALUMINUM DISK	4145865.9346	5400695.5736	4145751.4663	5400546.459
KY 1159	33.57' LT. STA. 113 + 48.14	R/W MARKER TYPE 1	ALUMINUM DISK	4145921.4376	5400533.1715	4145806.9677	5400384.061
KY 1159	52.53' RT. STA. 114 + 97.93	R/W MARKER TYPE 1	ALUMINUM DISK	4146089.6908	5400493.8422	4145975.2163	5400344.733
KY 1159	146.62' RT. STA. 116 + 88.98	R/W MARKER TYPE 1	ALUMINUM DISK	4146299.5422	5400413.6123	4146185.0619	5400264.505
KY 1159	152.29' RT. STA. 117 + 22.80	R/W MARKER TYPE 1	ALUMINUM DISK	4146328.3172	5400387.3282	4146213.8361	5400238.222
KY 1159	167.75' LT. STA. 117 + 35.81	P/E BREAK POINT	N/A	4146083.9709	5400180.2516	4145969.4965	5400031.1513
KY 1159	232.66' LT. STA. 117 + 53.24	P/E BREAK POINT	N/A	4146040.7839	5400129.7708	4145926.3107	5399980.671
KY 1159	63.99' LT. STA. 117 + 77.67	P/E BREAK POINT	N/A	4146189.5549	5400211.9653	4146075.0776	5400062.864
KY 1159	147.67' LT. STA. 117 + 95.34	P/E BREAK POINT	N⁄A	4146130.0194	5400151.0435	4146015.5438	5400001.944
KY 1159	238.44' LT. STA. 117 + 98.01	P/E BREAK POINT	N⁄A	4146056.3134	5400098.0255	4145941.8398	5399948.927
KY 1159	53.69' LT. STA. 118 + 65.06	R/W MARKER TYPE 1	ALUMINUM DISK	4146243.1546	5400148.3577	4146128.6758	5399999.258
KY 1159	110.19' RT. STA. 119 + 38.08	R/W MARKER TYPE 1	ALUMINUM DISK	4146422.5604	5400162.0071	4146308.0767	5400012.907
KY 1159	46.16' LT. STA. 119 + 60.00	R/W MARKER TYPE 1	ALUMINUM DISK	4146293.0191	5400071.6530	4146178.5390	5399922.555
KY 1159	55.58' LT. STA. 120 + 50.00	R/W MARKER TYPE 1	ALUMINUM DISK	4146322.8921	5399987.3454	4146208.4111	5399838.250
KY 1159	53.23' RT. STA. 120 + 67.75	R/W MARKER TYPE 1	ALUMINUM DISK	4146428.9112	5400017.5688	4146314.4273	5399868.473
KY 1159	72.27' LT. STA. 122 + 45.27	R/W MARKER TYPE 1	ALUMINUM DISK	4146398.6132	5399800.1188	4146284.1301	5399651.029
KY 1159	48.71' RT. STA. 122 + 48.83	R/W MARKER TYPE 1	ALUMINUM DISK	4146504.7188	5399858.3299	4146390.2328	5399709.238
KY 1159	71.37' RT. STA. 122 + 67.01	R/W MARKER TYPE 1	ALUMINUM DISK	4146532.9826	5399855.3210	4146418.4958	5399706.229
KY 1159	50.02' RT. STA. 123 + 43.64	R/W MARKER TYPE 1	ALUMINUM DISK	4146555.1767	5399783.3294	4146440.6893	5399634.240
KY 1159	61.88' RT. STA. 124 + 22.67	R/W MARKER TYPE 1	ALUMINUM DISK	4146515.4703	5399652.0290	4146400.9840	5399502.943
KY 1159	40.36' LT. STA. 128 + 40.36	R/W MARKER TYPE 1	ALUMINUM DISK	4146852.3134	5399366.7704	4146737.8178	5399217.692
KY 1159	50.21' LT. STA. 129 + 15.83	R/W MARKER TYPE 1	ALUMINUM DISK	4146934.0761	5399352.7049	4146819.5783	5399203.627
KY 1159	182.98' LT. STA. 132 + 68.90	R/W MARKER TYPE 1	ALUMINUM DISK	4147229.0455	5399109.1725	4147114.5395	5398960.1018
KY 1159	85.34' LT. STA. 133 + 74.92	R/W MARKER TYPE 1	ALUMINUM DISK	4147354.9506	5399167.1962	4147240.4411	5399018.1239



COUNTY OF	ITEM NO.	SHEET NO.
BRACKEN	6-8311.00	R41

			PROJECT GRID	COORDINATES	STATE PLANE	COORDINATES	
ROUTE	STATION AND OFFSET	ТҮРЕ	DESCRIPTION	NORTH (Y)	EAST (X)	NORTH (Y)	EAST (X)
KY 1159	38.50' LT. STA. 135 + 00.00	R/W MARKER TYPE 1	ALUMINUM DISK	4147482.5310	5399159.2899	4147368.0180	5399010.2178
KY 1159	29.00' LT. STA. 135 + 54.00	R/W MARKER TYPE 1	ALUMINUM DISK	4147534.0562	5399142.4570	4147419.5418	5398993.3854
KY 1159	25.00' LT. STA. 136 + 18.44	R/W MARKER TYPE 1	ALUMINUM DISK	4147592.4257	5399115.0111	4147477.9097	5398965.9403
KY 1159	82.53' LT. STA. 136 + 48.63	R/W MARKER TYPE 1	ALUMINUM DISK	4147591.2143	5399050.0524	4147476.6983	5398900.9833
KY 1159	95.00' LT. STA. 136 + 55.18	R/W MARKER TYPE 1	ALUMINUM DISK	4147590.9518	5399035.9714	4147476.4358	5398886.9027
KY 1159	84.00° LT. STA. 137 + 14.00	R/W MARKER TYPE 1	ALUMINUM DISK	4147647.8108	5399017.3147	4147533.2933	5398868.2465
KY 1159	53.02' LT. STA. 137 + 60.47	R/W MARKER TYPE 1	ALUMINUM DISK	4147703.4544	5399022.1164	4147588.9353	5398873.0481
KY 1159	110.02' LT. STA. 139 + 16.02	R/W MARKER TYPE 1	ALUMINUM DISK	4147810.8298	5398897.8201	4147696.3078	5398748.7552
KY 1159	55.59' LT. STA. 140 + 33.86	R/W MARKER TYPE 1	ALUMINUM DISK	4147933.0698	5398885.5606	4147818.5444	5398736.4961
KY 1159	53.97' LT. STA. 141 + 39.05	R/W MARKER TYPE 1	ALUMINUM DISK	4148012.5713	5398825.1920	4147898.0437	5398676.1292
KY 1159	81.17' LT. STA. 142 + 27.44	R/W MARKER TYPE 1	ALUMINUM DISK	4148053.0811	5398748.9230	4147938.5524	5398599.8623
KY 1159	51.71' LT. STA. 143 + 89.11	R/W MARKER TYPE 1	ALUMINUM DISK	4148171.0598	5398650.5763	4148056.5278	5398501.5183
KY 1159	57.24' LT. STA. 145 + 99.67	R/W MARKER TYPE 1	ALUMINUM DISK	4148261.0512	5398473.3080	4148146.5167	5398324.2549
KY 1159	66.47' RT. STA. 147 + 42.92	R/W MARKER TYPE 1	ALUMINUM DISK	4148423.4603	5398375.7176	4148308.9213	5398226.6672
KY 1159	107.16' LT. STA. 147 + 62.95	R/W MARKER TYPE 1	ALUMINUM DISK	4148259.4024	5398315.5738	4148144.8680	5398166.5250
KY 1159	36.77' LT. STA. 149 + 57.64	R/W MARKER TYPE 1	ALUMINUM DISK	4148354.9582	5398144.0798	4148240.4211	5397995.0358
KY 1159	41.75' RT. STA. 149 + 85.72	R/W MARKER TYPE 1	ALUMINUM DISK	4148435.6567	5398123.0880	4148321.1174	5397974.0445
KY 1159	84.05' RT. STA. 151 + 01.34	R/W MARKER TYPE 1	ALUMINUM DISK	4148488.0014	5398011.6627	4148373.4607	5397862.6223
KY 1159	180.65' RT. STA. 152 + 20.42	R/W MARKER TYPE 1	ALUMINUM DISK	4148594.7440	5397901.5813	4148480.2003	5397752.5440
KY 1159	47.78' LT. STA. 152 + 40.00	R/W MARKER TYPE 1	ALUMINUM DISK	4148368.9375	5397861.8962	4148254.4000	5397712.8600
KY 1159	161.35' RT. STA. 152 + 97.38	R/W MARKER TYPE 1	ALUMINUM DISK	4148582.3217	5397823.2182	4148467.7784	5397674.1830
KY 1159	63.17' LT. STA. 153 + 00.00	R/W MARKER TYPE 1	ALUMINUM DISK	4148358.9130	5397800.7717	4148244.3758	5397651.7371
KY 1159	74.27' RT. STA. 154 + 48.20	R/W MARKER TYPE 1	ALUMINUM DISK	4148508.9097	5397665.2901	4148394.3684	5397516.2593
KY 1159	62.79' LT. STA. 154 + 73.09	R/W MARKER TYPE 1	ALUMINUM DISK	4148374.5811	5397628.3932	4148260.0435	5397479.3634
KY 1159	215.52' LT. STA. 157 + 49.14	R/W MARKER TYPE 1	ALUMINUM DISK	4148251.7073	5397325.8768	4148137.1731	5397176.8553
KY 1159	87.74' LT. STA. 158 + 55.00	R/W MARKER TYPE 1	ALUMINUM DISK	4148401.7771	5397233.1037	4148287.2387	5397084.0848
KY 1159	78.90' RT. STA. 159 + 62.06	R/W MARKER TYPE 1	ALUMINUM DISK	4148593.2901	5397182.4755	4148478.7465	5397033.4580
KY 1159	84.40° LT. STA. 160 + 40.88	R/W MARKER TYPE 1	ALUMINUM DISK	4148474.8587	5397045.2045	4148360.3183	5396896.1908
KY 1159	59.93' RT. STA. 160 + 66.52	R/W MARKER TYPE 1	ALUMINUM DISK	4148615.6962	5397086.0534	4148501.1519	5396937.0386
KY 1159	71.20' RT. STA. 161 + 51.48	R/W MARKER TYPE 1	ALUMINUM DISK	4148664.6175	5397022.5573	4148550.0719	5396873.5442
KY 1159	41.74' LT. STA. 161 + 90.62	R/W MARKER TYPE 1	ALUMINUM DISK	4148591.0704	5396928.5946	4148476.5268	5396779.5841
KY 1159	193.58' RT. STA. 162 + 79.45	R/W MARKER TYPE 1	ALUMINUM DISK	4148830.6645	5396999.9797	4148716.1143	5396850.9672
KY 1159	62.30' LT. STA. 163 + 20.00	R/W MARKER TYPE 1	ALUMINUM DISK	4148654.9938	5396809.7991	4148540.4484	5396660.7919
KY 1159	101.68' RT. STA. 163 + 83.44	R/W MARKER TYPE 1	ALUMINUM DISK	4148822.4842	5396863.3867	4148707.9342	5396714.3780
KY 1159	68.04' RT. STA. 164 + 32.79	R/W MARKER TYPE 1	ALUMINUM DISK	4148827.3246	5396803.8632	4148712.7745	5396654.8562
KY 1159	68.41' LT. STA. 165 + 65.00	R/W MARKER TYPE 1	ALUMINUM DISK	4148804.2808	5396615.2677	4148689.7313	5396466.2659
KY 1159	54.60° RT. STA. 166 + 56.08	R/W MARKER TYPE 1	ALUMINUM DISK	4148957.0634	5396622.1264	4148842.5097	5396473.1244
KY 1159	59.84' LT. STA. 169 + 01.25	R/W MARKER TYPE 1	ALUMINUM DISK	4149034.6091	5396362.7621	4148920.0533	5396213.7672
KY 1159	122.29' RT. STA. 169 + 95.48	R/W MARKER TYPE 1	ALUMINUM DISK	4149230.3860	5396423.7252	4149115.8248	5396274.7287
KY 1159	75.51' RT. STA. 170 + 94.22	R/W MARKER TYPE 1	ALUMINUM DISK	4149269.2255	5396322.9367	4149154.6632	5396173.9429
KY 1159	78.51' RT. STA. 171 + 95.77	R/W MARKER TYPE 1	ALUMINUM DISK	4149341.0192	5396251.1136	4149226.4549	5396102.1218



		MGIII OI V	VAY MONUMENT		NTS			
			PROJECT GRID	COORDINATES	STATE PLANE COORDINATE			
ROUTE	STATION AND OFFSET	TYPE	DESCRIPTION	NORTH (Y)	EAST (X)	NORTH (Y)	EAST (X)	
KY 1159	167.68' RT. STA. 173 + 70.33	R/W MARKER TYPE 1	ALUMINUM DISK	4149527.4896	5396190.7011	4149412.9202	5396041.7110	
KY 1159	64.31' LT. STA. 173 + 86.26	R/W MARKER TYPE 1	ALUMINUM DISK	4149374.6750	5396015.4235	4149260.1098	5395866.4382	
KY 1159	80.58' RT. STA. 173 + 87.32	R/W MARKER TYPE 1	ALUMINUM DISK	4149477.9040	5396117.1086	4149363.3359	5395968.1205	
KY 1159	132.61' RT. STA. 174 + 96.79	R/W MARKER TYPE 1	ALUMINUM DISK	4149592.0900	5396076.4698	4149477.5188	5395927.4828	
KY 1159	195.77' RT. STA. 175 + 68.11	R/W MARKER TYPE 1	ALUMINUM DISK	4149410.2611	5395793.8718	4149295.6949	5395644.8926	
KY 1159	188.90' RT. STA. 175 + 97.31	R/W MARKER TYPE 1	ALUMINUM DISK	4149435.7683	5395778.0800	4149321.2014	5395629.1013	
KY 1159	97.64' LT. STA. 177 + 19.83	R/W MARKER TYPE 1	ALUMINUM DISK	4149586.9263	5395755.9490	4149472.3552	5395606.9709	
KY 1159	78.04' RT. STA. 177 + 68.47	R/W MARKER TYPE 1	ALUMINUM DISK	4149745.5602	5395845.7468	4149630.9847	5395696.7662	
KY 1159	57.60' LT. STA. 178 + 02.89	R/W MARKER TYPE 1	ALUMINUM DISK	4149673.9637	5395725.5070	4149559.3902	5395576.5297	
KY 1159	85.08' LT. STA. 181 + 43.14	R/W MARKER TYPE 1	ALUMINUM DISK	4149932.1657	5395476.5733	4149817.5851	5395327.6029	
KY 1159	68.39' LT. STA. 184 + 90.03	R/W MARKER TYPE 1	ALUMINUM DISK	4150270.9435	5395349.7531	4150156.3535	5395200.7862	
KY 1159	119.90' LT. STA. 185 + 88.37	R/W MARKER TYPE 1	ALUMINUM DISK	4150345.7792	5395267.7551	4150231.1872	5395118.7905	
KY 1159	54.21' LT. STA. 186 + 91.96	R/W MARKER TYPE 1	ALUMINUM DISK	4150465.5710	5395294.0997	4150350.9757	5395145.1343	
KY 1159	55.25' LT. STA. 187 + 34.01	R/W MARKER TYPE 1	ALUMINUM DISK	4150504.7392	5395278.7596	4150390.1428	5395129.7947	
KY 1159	95.77' LT. STA. 188 + 94.16	R/W MARKER TYPE 1	ALUMINUM DISK	4150641.4142	5395185.9720	4150526.8140	5395037.0096	
KY 1159	57.28' LT. STA. 190 + 74.20	R/W MARKER TYPE 1	ALUMINUM DISK	4150816.9224	5395158.0797	4150702.3174	5395009.1181	
KY 1159	142.86' LT. STA. 192 + 43.77	R/W MARKER TYPE 1	ALUMINUM DISK	4150902.5500	5395007.8348	4150787.9426	5394858.8774	
KY 1159	88.10' LT. STA. 193 + 55.90	R/W MARKER TYPE 1	ALUMINUM DISK	4151013.5361	5394986.7794	4150898.9256	5394837.8225	
KY 1159	58.08' LT. STA. 194 + 43.94	R/W MARKER TYPE 1	ALUMINUM DISK	4151096.2154	5394949.1560	4150981.6026	5394800.2002	
KY 1159	50.17' LT. STA. 197 + 03.27	R/W MARKER TYPE 1	ALUMINUM DISK	4151287.2820	5394773.6245	4151172.6640	5394624.6735	
KY 1159	72.60' LT. STA. 197 + 99.26	R/W MARKER TYPE 1	ALUMINUM DISK	4151342.9296	5394689.6197	4151228.3100	5394540.6710	
KY 1159	129.15' LT. STA. 198 + 94.50	R/W MARKER TYPE 1	ALUMINUM DISK	4151386.6536	5394579.3977	4151272.0328	5394430.4521	
KY 1159	129.79' LT. STA. 199 + 35.74	R/W MARKER TYPE 1	ALUMINUM DISK	4151423.9245	5394551.4604	4151309.3027	5394402.5156	
KY 1159	60.17' LT. STA. 200 + 26.53	R/W MARKER TYPE 1	ALUMINUM DISK	4151545.0852	5394557.1695	4151430.4601	5394408.2245	
KY 1159	80.30' LT. STA. 201+09.06	R/W MARKER TYPE 1	ALUMINUM DISK	4151614.3104	5394498.7666	4151499.6833	5394349.8232	
KY 1159	64.01' LT. STA. 203 + 34.70	R/W MARKER TYPE 1	ALUMINUM DISK	4151839.0450	5394432.2550	4151724.4117	5394283.3134	
KY 1159	255.01' LT. STA. 204+13.70	P/E BREAK POINT	N/A	4151852.7521	5394226.0228	4151738.1185	5394077.0869	
KY 1159	295.61' LT. STA. 204 + 14.97	P/E BREAK POINT	N/A	4151840.9566	5394187.1574	4151726.3233	5394038.2226	
KY 1159	305.07° LT. STA. 204 + 35.62	P/E BREAK POINT	N/A	4151857.4904	5394171.5778	4151742.8566	5394022.6434	
KY 1159	180.04' LT. STA. 204 + 67.95	R/W MARKER TYPE 1	ALUMINUM DISK	4151928.1420	5394279.6831	4151813.5063	5394130.7458	
KY 1159	150.57' LT. STA. 204 + 72.59	R/W MARKER TYPE 1	ALUMINUM DISK	4151941.9703	5394306.1196	4151827.3342	5394157.1815	
KY 1159	287.30° LT. STA. 204 + 73.37	P/E BREAK POINT	N/A	4151898.9487	5394176.3315	4151784.3138	5394027.3970	
KY 1159	200.72° LT. STA. 205 + 13.06	R/W MARKER TYPE 1	ALUMINUM DISK	4151964.2632	5394245.6467	4151849.6265	5394096.7103	
KY 1159	164.28' LT. STA. 205 + 72.26	R/W MARKER TYPE 1	ALUMINUM DISK	4152032.0156	5394261.2243	4151917.3770	5394112.2875	
KY 1159	86.83' RT. STA. 205 + 96.21	R/W MARKER TYPE 1	ALUMINUM DISK	4152135.0760	5394491.4540	4152020.4346	5394342.5108	
KY 1159	63.49' RT. STA. 206 + 02.08	R/W MARKER TYPE 1	ALUMINUM DISK	4152133.1638	5394467.4642	4152018.5224	5394318.5217	
KY 1159	106.84' LT. STA. 206 + 27.60	R/W MARKER TYPE 1	ALUMINUM DISK	4152102.8236	5394297.9339	4151988.1831	5394148.9961	
KY 1159	41.02' RT. STA. 206 + 97.70	R/W MARKER TYPE 1	ALUMINUM DISK	4152216.5636	5394415.5680	4152101.9199	5394266.6269	
KY 1159	59.40' LT. STA. 207 + 00.05	R/W MARKER TYPE 1	ALUMINUM DISK	4152186.6533	5394319.6846	4152072.0104	5394170.7462	
KY 1159	78.66' RT. STA. 207 + 13.61	R/W MARKER TYPE 1	ALUMINUM DISK	4152243.6871	5394446.1362	4152129.0427	5394297.1943	
KY 1159	48.50' RT. STA. 207 + 33.00	R/W MARKER TYPE 1	ALUMINUM DISK	4152252.4026	5394411.3579	4152137.7579	5394262.4169	

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				PROJECT GRID	COORDINATES	STATE PLANE COORDINATE	
ROUTE	STATION AND OFFSET	TYPE	DESCRIPTION	NORTH (Y)	EAST (X)	NORTH (Y)	EAST (X)
KY 1159	82.09' LT. STA. 207 + 52.46	R/W MARKER TYPE 1	ALUMINUM DISK	4152229.0406	5394281.4084	4152114.3966	5394132.4710
KY 1159	99.36' LT. STA. 207 + 99.36	R/W MARKER TYPE 1	ALUMINUM DISK	4152269.9673	5394256.0232	4152155.3221	5394107.0865
KY 1159	105.87' LT. STA. 210 + 00.00	R/W MARKER TYPE 1	ALUMINUM DISK	4152455.9431	5394179.6480	4152341.2928	5394030.7134
KY 1159	57.95' LT. STA. 210 + 51.04	R/W MARKER TYPE 1	ALUMINUM DISK	4152519.6391	5394208.7072	4152404.9870	5394059.7718
KY 1159	158.20' LT. STA. 212 + 03.47	R/W MARKER TYPE 1	ALUMINUM DISK	4152631.9583	5394064.9420	4152517.3031	5393916.0106
KY 1159	172.60' LT. STA. 212 + 69.14	R/W MARKER TYPE 1	ALUMINUM DISK	4152689.5610	5394030.2773	4152574.9043	5393881.3468
KY 1159	68.31' LT. STA. 214 + 36.84	R/W MARKER TYPE 1	ALUMINUM DISK	4152881.8174	5394075.3973	4152767.1553	5393926.4656
KY 1159	58.68' LT. STA. 215 + 67.93	R/W MARKER TYPE 1	ALUMINUM DISK	4153009.0950	5394042.5673	4152894.4294	5393893.6365
KY 1159	179.45' LT. STA. 218 + 51.34	R/W MARKER TYPE 1	ALUMINUM DISK	4153235.6485	5393837.0938	4153120.9767	5393688.1687
KY 1159	146.87' RT. STA. 219 + 24.48	R/W MARKER TYPE 1	ALUMINUM DISK	4153415.0624	5394119.2712	4153300.3856	5393970.3383
KY 1159	175.52' LT. STA. 219 + 75.01	R/W MARKER TYPE 1	ALUMINUM DISK	4153351.1535	5393799.2815	4153236.4785	5393650.3574
KY 1159	72.56' RT. STA. 220 + 82.95	R/W MARKER TYPE 1	ALUMINUM DISK	4153539.1057	5393993.5656	4153424.4255	5393844.6362
KY 1159	70.00° LT. STA. 220 + 89.91	R/W MARKER TYPE 1	ALUMINUM DISK	4153494.5838	5393857.9636	4153379.9048	5393709.0379
KY 1159	69.90' LT. STA. 221 + 43.70	R/W MARKER TYPE 1	ALUMINUM DISK	4153544.4290	5393838.7795	4153429.7487	5393689.8543
KY 1159	72.48' RT. STA. 222 + 52.10	R/W MARKER TYPE 1	ALUMINUM DISK	4153697.4440	5393931.3864	4153582.7594	5393782.4587
KY 1159	110.88' LT. STA. 222 + 70.57	R/W MARKER TYPE 1	ALUMINUM DISK	4153646.7698	5393754.1964	4153532.0866	5393605.2736
KY 1159	66.09' RT. STA. 223 + 27.62	R/W MARKER TYPE 1	ALUMINUM DISK	4153765.2411	5393897.5056	4153650.5547	5393748.5788
KY 1159	54.88' RT. STA. 224 + 26.81	R/W MARKER TYPE 1	ALUMINUM DISK	4153853.2516	5393850.3975	4153738.5627	5393701.4720
KY 1159	83.05' LT. STA. 224 + 63.30	R/W MARKER TYPE 1	ALUMINUM DISK	4153836.1169	5393708.7533	4153721.4285	5393559.8317
KY 1159	231.25' RT. STA. 226 + 38.54	R/W MARKER TYPE 1	ALUMINUM DISK	4154115.2034	5393935.9240	4154000.5073	5393786.9961
KY 1159	141.79' LT. STA. 227 + 28.91	R/W MARKER TYPE 1	ALUMINUM DISK	4154079.4371	5393433.3434	4153964.7420	5393284.4294
KY 1159	248.90° LT. STA. 227 + 91.24	R/W MARKER TYPE 1	ALUMINUM DISK	4154061.1552	5393555.9174	4153946.4606	5393407.0000
KY 1159	71.92' LT. STA. 228 + 19.68	R/W MARKER TYPE 1	ALUMINUM DISK	4154171.3314	5393587.2526	4154056.6337	5393438.3344
KY 1159	147.90' RT. STA. 228 + 43.80	R/W MARKER TYPE 1	ALUMINUM DISK	4154275.0644	5393782.5466	4154160.3639	5393633.6230
KY 1159	134.92' LT. STA. 229 + 66.88	R/W MARKER TYPE 1	ALUMINUM DISK	4154284.7818	5393474.2621	4154170.0810	5393325.3470
KY 1159	258.04' RT. STA. 230+10.62	R/W MARKER TYPE 1	ALUMINUM DISK	4154470.7979	5393823.1635	4154356.0920	5393674.2388
KY 1159	224.90' RT. STA. 230 + 52.64	R/W MARKER TYPE 1	ALUMINUM DISK	4154497.5768	5393776.8256	4154382.8701	5393627.9021
KY 1159	77.63' LT. STA. 233 + 47.04	R/W MARKER TYPE 1	ALUMINUM DISK	4154659.1618	5393386.8426	4154544.4507	5393237.9299
KY 1159	72.20' RT. STA. 233 + 72.51	R/W MARKER TYPE 1	ALUMINUM DISK	4154738.2557	5393516.6174	4154623.5424	5393367.7011
KY 1159	172.80° LT. STA. 234 + 44.93	R/W MARKER TYPE 1	ALUMINUM DISK	4154714.9003	5393262.2081	4154600.1876	5393113.2988
KY 1159	168.96' LT. STA. 234 + 69.12	R/W MARKER TYPE 1	ALUMINUM DISK	4154738.7962	5393256.8324	4154624.0829	5393107.9233
KY 1159	164.06' LT. STA. 234 + 99.92	R/W MARKER TYPE 1	ALUMINUM DISK	4154769.2211	5393249.9879	4154654.5069	5393101.0790
KY 1159	162.88' LT. STA. 235 + 07.32	R/W MARKER TYPE 1	ALUMINUM DISK	4154776.5304	5393248.3435	4154661.8160	5393099.4346
KY 1159	76.88' LT. STA. 235 + 90.13	R/W MARKER TYPE 1	ALUMINUM DISK	4154885.2798	5393297.6148	4154770.5624	5393148.7046
KY 1159	58.23' RT. STA. 235 + 93.03	R/W MARKER TYPE 1	ALUMINUM DISK	4154937.9614	5393422.0569	4154823.2426	5393273.1432
KY 1159	139.85' LT. STA. 236 + 78.53	R/W MARKER TYPE 1	ALUMINUM DISK	4154944.1195	5393206.4044	4154829.4005	5393057.4967
KY 1159	325.62' RT. STA. 238 + 30.00	R/W MARKER TYPE 1	ALUMINUM DISK	4155264.2771	5393579.4801	4155149.5493	5393430.5621
KY 1159	130.14' LT. STA. 238 + 71.50	R/W MARKER TYPE 1	ALUMINUM DISK	4155118.5639	5393145.3652	4155003.8401	5392996.4592
KY 1159	207.57' RT. STA. 240 + 90.58	R/W MARKER TYPE 1	ALUMINUM DISK	4155486.6893	5393314.7683	4155371.9553	5393165.8576
KY 1159	212.07' LT. STA. 242 + 25.56	R/W MARKER TYPE 1	ALUMINUM DISK	4155314.6191	5392909.9330	4155199.8899	5392761.0335
KY 1159	106.02' LT. STA. 242 + 79.00	R/W MARKER TYPE 1	ALUMINUM DISK	4155422.3827	5392951.0224	4155307.6505	5392802.1217

		RIGHT OF WAY MONUMENT POINTS						
				PROJECT GRID	PROJECT GRID COORDINATES		COORDINATES	
ROUTE	STATION AND OFFSET	TYPE	DESCRIPTION	NORTH (Y)	EAST (X)	NORTH (Y)	EAST (X)	
KY 1159	54.65' LT. STA. 246 + 28.10	R/W MARKER TYPE 1	ALUMINUM DISK	4155640.5871	5392709.9443	4155525.8489	5392561.0503	
KY 1159	59.25' RT. STA. 246 + 82.25	R/W MARKER TYPE 1	ALUMINUM DISK	4155766.5202	5392702.9096	4155651.7785	5392554.0158	
KY 1159	51.91' RT. STA. 247 + 99.74	R/W MARKER TYPE 1	ALUMINUM DISK	4155796.9950	5392582.9180	4155682.2525	5392434.0275	
KY 1159	68.08' LT. STA. 249 + 06.10	R/W MARKER TYPE 1	ALUMINUM DISK	4155700.8106	5392455.4792	4155586.0707	5392306.5922	
KY 1159	78.71' LT. STA. 252 + 12.96	R/W MARKER TYPE 1	ALUMINUM DISK	4155742.6827	5392139.7345	4155627.9417	5391990.8562	
MINI FARM ROAD	14.70' LT. STA. 50 + 77.10	R/W MARKER TYPE 1	ALUMINUM DISK	4146557.5469	5399832.9727	4146443.0595	5399683.8820	
WAGEL ROAD	56.22' LT. STA. 50 + 81.64	P/E BREAK POINT	N/A	4148439.5813	5398399.5767	4148325.0419	5398250.5256	
WAGEL ROAD	38.15' LT. STA. 51+08.70	P/E BREAK POINT	N/A	4148459.8504	5398429.5750	4148345.3104	5398280.5231	
WAGEL ROAD	30.50' LT. STA. 51 + 22.83	R/W MARKER TYPE 1	ALUMINUM DISK	4148469.6623	5398444.0966	4148355.1221	5398295.0443	
WAGEL ROAD	186 + 08' LT. STA. 51 + 40.89	P/E BREAK POINT	N/A	4148575.4370	5398327.4633	4148460.8938	5398178.4142	
WAGEL ROAD	195.17' LT. STA. 51 + 59.86	P/E BREAK POINT	N/A	4148597.3057	5398331.8096	4148482.7619	5398182.7604	
WAGEL ROAD	185.75' LT. STA. 51 + 79.64	P/E BREAK POINT	N/A	4148607.9835	5398350.9446	4148493.4394	5398201.8948	
ANDERSON LANE	17.04' LT. STA. 47 + 00.00	R/W MARKER TYPE 1	ALUMINUM DISK	4148560.7031	5396551.2298	4148446.1604	5396402.2297	
ANDERSON LANE	18.39' RT. STA. 47 + 00.00	R/W MARKER TYPE 1	ALUMINUM DISK	4148535.7646	5396576.3976	4148421.2225	5396427.3968	
ANDERSON LANE	56.20' RT. STA. 49 + 04.41	R/W MARKER TYPE 1	ALUMINUM DISK	4148670.3278	5396737.8107	4148555.7820	5396588.8055	
ANDERSON LANE	69.55' LT. STA. 49 + 07.79	R/W MARKER TYPE 1	ALUMINUM DISK	4148751.9904	5396642.1244	4148637.4424	5396493.1218	
AUGUSTA-BERLIN	73.78' LT. STA. 51+19.25	R/W MARKER TYPE 1	ALUMINUM DISK	4154950.7756	5393513.8617	4154836.0564	5393364.9455	
AUGUSTA-BERLIN	83.51' LT. STA. 52 + 36.32	R/W MARKER TYPE 1	ALUMINUM DISK	4154903.7428	5393666.8635	4154789.0249	5393517.9431	
AUGUSTA-BERLIN	15.28' LT. STA. 54 + 61.11	R/W MARKER TYPE 1	ALUMINUM DISK	4154761.7182	5393812.5225	4154647.0042	5393663.5981	