

CALL NO. 404
CONTRACT ID. 212152
WEBSTER COUNTY
FED/STATE PROJECT NUMBER 117GR21P030 - FD05 & FD04
DESCRIPTION CLAY - DIXON (KY 132)
WORK TYPE ASPHALT RESURFACING
PRIMARY COMPLETION DATE 11/15/2021

#### LETTING DATE: April 23,2021

Sealed Bids will be received electronically through the Bid Express bidding service until 10:00 am EASTERN DAYLIGHT TIME April 23,2021. Bids will be publicly announced at 10:00 am EASTERN DAYLIGHT TIME.

NO PLANS ASSOCIATED WITH THIS PROJECT.

**DEFERRED PAYMENT** 

**REQUIRED BID PROPOSAL GUARANTY:** Not less than 5% of the total bid.

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## PART I SCOPE OF WORK

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#### **ADMINISTRATIVE DISTRICT - 02**

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**COUNTY - WEBSTER** 

PCN - MP11701322101 FD05 117 0132 008-016

CLAY - DIXON (KY 132) (MP 8.778) BEGINNING 0.061 MILES WEST OF KY 270 EXTENDING EAST TO A POINT 1.771 MILES EAST OF NAT TAYLOR ROAD. (MP 15.273), A DISTANCE OF 06.49 MILES.ASPHALT RESURFACING GEOGRAPHIC COORDINATES LATITUDE 37:42:45.00 LONGITUDE 87:54:56.00

PCN - MP11701322102 FD04 117 0132 008-016

CLAY - DIXON (KY 132) (MP 8.778) BEGINNING 0.061 MILES WEST OF KY 270 EXTENDING EAST TO A POINT 1.771 MILES EAST OF NAT TAYLOR ROAD. (MP 15.273), A DISTANCE OF 06.49 MILES.BRIDGE WITH GRADE, DRAIN & SURFACE SYP NO. 02-10019.00.

GEOGRAPHIC COORDINATES LATITUDE 37:42:45.00 LONGITUDE 87:54:56.00

#### **COMPLETION DATE(S):**

COMPLETED BY 11/15/2021 APPLIES TO ENTIRE CONTRACT

#### **CONTRACT NOTES**

#### **PROPOSAL ADDENDA**

All addenda to this proposal must be applied when calculating bid and certified in the bid packet submitted to the Kentucky Department of Highways. Failure to use the correct and most recent addenda may result in the bid being rejected.

#### **BID SUBMITTAL**

Bidder must use the Department's electronic bidding software. The Bidder must download the bid file located on the Bid Express website (www.bidx.com) to prepare a bid packet for submission to the Department. The bidder must submit electronically using Bid Express.

#### JOINT VENTURE BIDDING

Joint venture bidding is permissible. All companies in the joint venture must be prequalified in one of the work types in the Qualifications for Bidders for the project. The bidders must get a vendor ID for the joint venture from the Division of Construction Procurement and register the joint venture as a bidder on the project. Also, the joint venture must obtain a digital ID from Bid Express to submit a bid. A joint bid bond of 5% may be submitted for both companies or each company may submit a separate bond of 5%.

#### UNDERGROUND FACILITY DAMAGE PROTECTION

The contractor shall make every effort to protect underground facilities from damage as prescribed in the Underground Facility Damage Protection Act of 1994, Kentucky Revised Statute KRS 367.4901 to 367.4917. It is the contractor's responsibility to determine and take steps necessary to be in compliance with federal and state damage prevention directives. When prescribed in said directives, the contractor shall submit Excavation Locate Requests to the Kentucky Contact Center (KY811) via web ticket entry. The submission of this request does not relieve the contractor from the responsibility of contacting non-member facility owners, whom shall be contacted through their individual Protection Notification Center. Non-compliance with these directives can result in the enforcement of penalties.

#### <u>REGISTRATION WITH THE SECRETARY OF STATE BY A FOREIGN ENTITY</u>

Pursuant to KRS 176.085(1)(b), an agency, department, office, or political subdivision of the Commonwealth of Kentucky shall not award a state contract to a person that is a foreign entity required by KRS 14A.9-010 to obtain a certificate of authority to transact business in the Commonwealth ("certificate") from the Secretary of State under KRS 14A.9-030 unless the person produces the certificate within fourteen (14) days of the bid or proposal opening. If the foreign entity is not required to obtain a certificate as provided in KRS 14A.9-010, the foreign entity should identify the applicable exception. Foreign entity is defined within KRS 14A.1-070.

For all foreign entities required to obtain a certificate of authority to transact business in the Commonwealth, if a copy of the certificate is not received by the contracting agency within the time frame identified above, the foreign entity's solicitation response shall be deemed non-responsive or the awarded contract shall be cancelled.

Businesses can register with the Secretary of State at <a href="https://secure.kentucky.gov/sos/ftbr/welcome.aspx">https://secure.kentucky.gov/sos/ftbr/welcome.aspx</a> .

#### SPECIAL NOTE FOR PROJECT QUESTIONS DURING ADVERTISEMENT

Questions about projects during the advertisement should be submitted in writing to the Division of Construction Procurement. This may be done by fax (502) 564-7299 or email to <a href="mailtokytc.projectquestions@ky.gov">kytc.projectquestions@ky.gov</a>. The Department will attempt to answer all submitted questions. The Department reserves the right not to answer if the question is not pertinent or does not aid in clarifying the project intent.

The deadline for posting answers will be 3:00 pm Eastern Daylight Time, the day preceding the Letting. Questions may be submitted until this deadline with the understanding that the later a question is submitted, the less likely an answer will be able to be provided.

The questions and answers will be posted for each Letting under the heading "Questions & Answers" on the Construction Procurement website (<a href="www.transportation.ky.gov/contract">www.transportation.ky.gov/contract</a>). The answers provided shall be considered part of this Special Note and, in case of a discrepancy, will govern over all other bidding documents.

#### HARDWOOD REMOVAL RESTRICTIONS

The US Department of Agriculture has imposed a quarantine in Kentucky and several surrounding states, to prevent the spread of an invasive insect, the emerald ash borer. Hardwood cut in conjunction with the project may not be removed from the state. Chipping or burning on site is the preferred method of disposal.

#### INSTRUCTIONS FOR EXCESS MATERIAL SITES AND BORROW SITES

Identification of excess material sites and borrow sites shall be the responsibility of the Contractor. The Contractor shall be responsible for compliance with all applicable state and federal laws and may wish to consult with the US Fish and Wildlife Service to seek protection under Section 10 of the Endangered Species Act for these activities.

#### ACCESS TO RECORDS

The contractor, as defined in KRS 45A.030 (9) agrees that the contracting agency, the Finance and Administration Cabinet, the Auditor of Public Accounts, and the Legislative Research Commission, or their duly authorized representatives, shall have access to any books, documents, papers, records, or other evidence, which are directly pertinent to this contract for the purpose of financial audit or program review. Records and other prequalification information confidentially

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disclosed as part of the bid process shall not be deemed as directly pertinent to the contract and shall be exempt from disclosure as provided in KRS 61.878(1)(c). The contractor also recognizes that any books, documents, papers, records, or other evidence, received during a financial audit or program review shall be subject to the Kentucky Open Records Act, KRS 61.870 to 61.884.

In the event of a dispute between the contractor and the contracting agency, Attorney General, or the Auditor of Public Accounts over documents that are eligible for production and review, the Finance and Administration Cabinet shall review the dispute and issue a determination, in accordance with Secretary's Order 11-004.

April 30, 2018

#### SPECIAL NOTE FOR RECIPROCAL PREFERENCE

# RECIPROCAL PREFERENCE TO BE GIVEN BY PUBLIC AGENCIES TO RESIDENT BIDDERS

By reference, KRS 45A.490 to 45A.494 are incorporated herein and in compliance regarding the bidders residency. Bidders who want to claim resident bidder status should complete the Affidavit for Claiming Resident Bidder Status along with their bid in the electronic bidding software. Submittal of the Affidavit should be done along the bid in Bid Express.

April 30, 2018

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#### **DEFERRED PAYMENT**

The successful bidder on this project may request a work order with an effective date prior to June 15, 2021. The successful bidder must make the request in writing to the Department. The Department will issue a work order at the request of the contractor with the distinct understanding that payment for any Work Performed Estimates may be delayed until July 15, 2021. Unless the successful bidder requests an earlier work order date, the Department will issue a work order on June 15, 2021 for this project.

#### SURFACING AREAS

The Department estimates the mainline surfacing width to be varied 22 to 25 feet.

The Department estimates the total mainline area to be surfaced to be 97,077 square yards.

The Department estimates the DGA shoulder width to be 1 foot on each side.

The Department estimates the total shoulder area to receive DGA to be 7,621 square yards.

#### ASPHALT MIXTURE

Unless otherwise noted, the Department estimates the rate of application for all asphalt mixtures to be 110 lbs/sy per inch of depth.

#### DGA BASE FOR SHOULDERS

Unless otherwise noted, the Department estimates the rate of application for DGA Base for Shoulders to be 115 lbs/sy per inch of depth. The Department will not measure necessary grading and/or shaping of existing shoulders prior to placing of DGA Base, but shall be incidental to the Contract unit price per ton for DGA Base.

Accept payment at the Contract unit price per ton as full compensation for all labor, materials, equipment, and incidentals for grading and/or shaping of existing shoulders and furnishing, placing, and compacting the DGA Base.

#### INCIDENTAL SURFACING

The Department has included in the quantities of asphalt mixtures established in the proposal estimated quantities required for resurfacing or surfacing mailbox turnouts, farm field entrances, residential and commercial entrances, curve widening, ramp gores and tapers, and road and street approaches, as applicable. Pave these areas to the limits as shown on Standard Drawing RPM-110-06 or as directed by the Engineer. In the event signal detectors are present in the intersecting streets or roads, pave the crossroads to the right of way limit or back of the signal detector, whichever is the farthest back of the mainline. Surface or resurface these areas as directed by the Engineer. The Department will not measure placing and compacting for separate payment but shall be incidental to the Contract unit price for the asphalt mixtures.

#### FUEL AND ASPHALT PAY ADJUSTMENT

The Department has included the Contract items Asphalt Adjustment and Fuel Adjustment for possible future payments at an established Contract unit price of \$1.00. The Department will calculate actual adjustment quantities after work is completed. If existing Contract amount is insufficient to pay all items on the contract with the adjustments, the Department will establish additional monies with a change order.

#### **OPTION B**

Be advised that the Department will control and accept compaction of asphalt mixtures furnished on this project under OPTION B in accordance with Sections 402 and 403.

#### SPECIAL NOTE FOR NON-TRACKING TACK COAT

- 1. DESCRIPTION AND USEAGE. This specification covers the requirements and practices for applying a non-tracking tack asphalt coating. Place this material on the existing pavement course, prior to placement of a new asphalt pavement layer. Use when expedited paving is necessary or when asphalt tracking would negatively impact the surrounding area. This material is not suitable for other uses. Ensure material can "break" within 15 minutes under conditions listed in 3.2.
- 2. MATERIALS, EQUIPMENT, AND PERSONNEL.
  - 2.1 Non-Tracking Tack. Provide material conforming to Subsection 2.1.1.
  - 2.1.1 Provide a tack conforming to the following material requirements:

Property	Specification	Test Procedure
Viscosity, SFS, 77 ° F	20 - 100	AASHTO T 72
Sieve, %	0.3 max.	AASHTO T 59
Asphalt Residue <sup>1</sup> , %	50 min.	AASHTO T 59
Oil Distillate, %	1.0 max.	AASHTO T 59
Residue Penetration, 77 ° F	20 max.	AASHTO T 49
Original Dynamic Shear (G*/sin δ), 82 ° C	1.0 min.	AASHTO T 315
Softening Point, ° F	149 min.	AASHTO T 53
Solubility, %	97.5 min.	AASHTO T 44

<sup>&</sup>lt;sup>1</sup> Bring sample to 212 °F over a 10-15 minute period. Maintain 212 °F for 15-20 minutes or until 30-40 mL of water has distilled. Continue distillation as specified in T59.

2.2. Equipment. Provide a distributor truck capable of heating, circulating, and spraying the tack between 170 °F and 180 °F. Do not exceed 180 °F. Circulate the material while heating. As required by the manufacturer, ensure the spray bar is equipped with #1 or #2 ¼" V-slot Etnyre nozzles. Other nozzles are not acceptable. Arrange the nozzles in the following patterns from left to right:

Nozzle number(s)	Activity	Orientation			
1	On	Vertical			
2	Off	-			
3	On	Horizontal			
4 & 5	Off	-			
6	On	Horizontal			
Continue 2 off and 1	on pattern through rest	of spray bar system.			

Ensure the bar can be raised to between 14 and 18" from the roadway.

2.3 Personnel. Ensure the tack supplier has provided training to the contractor on the installation procedures for this product. Make a technical representative from the supplier available at the request of the Engineer.

#### 3. CONSTRUCTION.

- 3.1 Surface Preparation. Prior to the application of the non-tracking tack, ensure the pavement surface is thoroughly dry and free from dust or any other debris that would inhibit adhesion. Clean the surface by scraping, sweeping, and the use of compressed air. Ensure this preparation process occurs shortly before application to prevent the return of debris pavement. If rain is expected within one hour after application, do not apply material. Apply material only when the surface is dry, and no precipitation is expected.
- 3.2 Non-tracking Tack Application. Ensure the roadway temperature is a minimum of 40  $^{\circ}$ F and rising during the application of the tack. This material is not suitable for use in colder temperatures. Prior to applying the tack, demonstrate competence in applying the tack according to this note to the satisfaction of the Engineer. Heat the tack in the distributor to between 170 180  $^{\circ}$ F. After initial heating to between 170 180  $^{\circ}$ F, the material may be sprayed between 165  $^{\circ}$ F and 180  $^{\circ}$ F. Do not apply outside this temperature range. Apply material at a rate of 0.50 pounds (0.06 gallons) per square yard. Ensure full coverage of the material on the pavement surface. Full coverage of this material is critical. If full coverage is not achieved, material application rate may be increased to ensure full coverage. Do not heat material more than twice in one day.
- 3.3 Non-tracking Tack Certification. Furnish the tacks certification to the Engineer stating the material conforms to all requirements herein prior to use.
- 3.4 Sampling and Testing. The Department will require a sample of non-tracking tack be taken from the distributor at a rate of one sample per 15,000 tons of mix. Take two 1 gallon samples of the heated material and forward the sample to the Division of Materials for testing within 7 days. Ensure the product temperature is between 170 and 180 °F at the time of sampling.
- 4. MEASUREMENT. The Department will measure the quantity of non-tracking tack in tons. The Department will not measure for payment any extra materials, labor, methods, equipment, or construction techniques used to satisfy the requirements of this note. The Department will not measure for payment any trial applications of non-tracking tack, the cleaning of the pavement surface, or furnishing and placing the adhesive. The Department will consider all such items incidental to the non-tracking tack.
- 5. PAYMENT. The Department will pay for the non-tracking tack at the Contract unit bid price and apply an adjustment for each manufacturer's lot of material based on the degree of compliance as defined in the following schedule. When a sample fails on two or more tests, the Department may add the deductions, but the total deduction will not exceed 100 percent.

Non-Tracking Tack Price Adjustment Schedule						
Test	Specification	100% Pay	90% Pay	80% Pay	50% Pay	0% Pay
Viscosity, SFS, 77 ° F	20 – 100	19 - 102	17 - 18	15 - 16	14	≤13
			103 - 105	106 - 107	108 - 109	≥ 110
Sieve, %	0.30 max.	≤ 0.40	0.41 - 0.50	0.51 - 0.60	0.61 - 0.70	≥ 0.71
Asphalt Residue, %	50 min.	≥49.0	48.5 – 48.9	48.0 – 48.4	47.5-47.9	≤ 47.4
Oil Distillate, %	1.0 max.	≤1.0	1.1-1.5	1.6 - 1.7	1.8-1.9	>2.0
Residue Penetration, 77 ° F	20 max.	≤ 21	22 - 23	24 - 25	26 - 27	≥ 28
Original Dynamic Shear (G*/sin δ), 82 ° C	1.0 min.	≥0.95	0.92 - 0.94	0.90 - 0.91	0.85 - 0.89	≤ 0.84
Softening Point, ° F	149 min.	≥145	142 - 144	140 - 141	138 - 139	≤ 137
Solubility, %	97.5 min.	≥ 97.0	96.8 – 96.9	96.6 – 96.7	96.4 – 96.5	≤ 96.3

CodePay ItemPay Unit24970ECAsphalt Material for Tack Non-TrackingTon

#### SPECIAL NOTE FOR EXPERIMENTAL KYCT AND HAMBURG TESTING

#### 1.0 General

**1.1 Description.** The KYCT (Kentucky Method for Cracking Test) and the Hamburg test results will help determine if the mixture is susceptible to cracking and rutting. During the experimental phase, data will be gathered and analyzed by the Department to determine the durability of the bituminous mixes. Additionally, the data will help the Department to create future performance based specifications which will include the KYCT and Hamburg test methods.

#### 2.0 Equipment

- **2.1 KYCT Testing Equipment.** The Department will require a Marshall Test Press with digital recordation capabilities. Other CT testing equipment may be used for testing with prior approval by the Department.
- **2.2 Water Baths.** One or more water baths will be required that can maintain a temperature of 77° +/- 1.8° F with a digital thermometer showing the water bath temperature. Also, one water bath shall have the ability to suspend gyratory specimen fully submerged in water in accordance with AASHTO T-166, current edition.
- **2.3 Hamburg Wheel Track Testing.** The department encourages the use of the PTI APA/Hamburg Jr. test equipment to perform the loaded wheel testing. The Department will allow different equipment for the Hamburg testing, but the testing device must be approved by the Department prior to testing.

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- **2.4 Gyratory Molds.** Gyratory molds will be required to assist in the production of gyratory specimens in accordance with AASHTO T-312, current edition.
- **2.5 Ovens.** Adequate (minimum of two ovens) will be required to accommodate the additional molds and asphalt mixture necessary to perform the acceptance testing as outlined in Section 402 of the Kentucky Standard Specifications for Road and Bridge Construction, current edition.
- **2.6 Department Equipment.** The Department will provide gyratory molds, PINE 850 Test Press with digital recordation, and CT testing equipment to assist during this experimental phase so data can be gathered. Hamburg test specimens will be submitted to the Division of Materials for testing on the PTI APA/Hamburg Jr if the asphalt contractor or district materials office does not have an approved Hamburg testing device.

#### 3.0 Testing Requirements

- **3.1 Acceptance Testing.** Perform all acceptance testing and aggregate gradation as according with Section 402 and Section 403 of the Kentucky Standard Specifications for Road and Bridge Construction, current edition.
- **3.2 KYCT Testing.** Perform crack resistance analysis (KYCT) in accordance with the current Kentucky Method for KYCT Index Testing during the mix design phase and during the plant production of all surface mixtures. For mix design approvals, submit KYCT results on the Department MixPack. For Class 4 mixtures, submit ingredient materials to the Division of Materials for informational verification.
- **3.2.1 KYCT Frequency.** Obtain an adequate sample of hot mix asphalt to insure the acceptance testing, gradation, and KYCT gyratory samples can be fabricated and is representative of the bituminous mixture. Acceptance specimens shall be fabricated first, then immediately after, fabricate the KYCT samples with the gyratory compactor in accordance with Section 2.4 of this Special Note. Analysis of the KYCT specimens and gradation will be required one per sublot produced from the same asphalt material and at the same time as the acceptance specimen is sampled and tested.
- **3.2.2 Number of Specimens and Conditioning.** Fabricate specimens in accordance with the Kentucky Method for KYCT Index Testing. Contrary to the method, fabricate a minimum of 3 and up to 6 test specimens. The specimens shall be compacted at the temperature in accordance to KM 64-411. KYCT mix design specimens shall be short-term conditioned for four hours at compaction temperature in accordance to KM 64-411. Contrary to the Kentucky Method, plant produced bituminous material shall be short-term conditioned immediately after sampling for two hours at compaction temperature in accordance to KM 64-411. Additionally, fabricated specimens shall be allowed to cool in air (fan is permissible) for 30 minutes +/- 5 minutes and conditioned in a 77 °F water bath for 30 minutes +/- 5 minutes. To insure confidence and reliability of the test results provided by KYCT testing and Hamburg testing, reheating of the asphalt mixture is prohibited.
- **3.2.3 Record Times.** For each sublot, record the time required between drying aggregates in the plant to KYCT specimen fabrication. The production time may vary due to the time that the bituminous material is held in the silo. Record the preconditioning time when the time exceeds the one hour specimen cool down time as required in accordance to The Kentucky Method for KYCT Index Testing. The preconditioning time may exceed an hour if the technician is unable to complete the test on the

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same day or within the specified times as outlined in The Kentucky Method for KYCT Index Testing. The production time and the preconditioning time shall be recorded on the AMAW.

- **3.2.4 File Name.** As according to section 7.12 of The Kentucky Method for KYCT Index Testing, save the filename with the following format; "CID\_Approved Mix Number\_Lot Number\_Sublot Number\_Date"
- **3.3 Hamburg Testing.** Perform the rut resistance analysis (Hamburg) in accordance to AASTHO T-324, not to exceed 20,000 passes for all bituminous mixtures during the mix design phase and production. For mix design approvals, submit Hamburg results on the Department MixPack. For Class 4 mixtures, submit ingredient materials to the Division of Materials for informational verification.
- **3.3.1 Hamburg Testing Frequency.** Perform testing and analysis per lot of material. The plant produced bituminous material sampled for the Hamburg test does not have to be obtained at the same time as the acceptance and KYCT sample. If the Hamburg test sample is not obtained at the same time as the KYCT sample, determine the Maximum Specific Gravity of the KYCT sample in accordance with AASHTO T-209 coinciding with the Hamburg specimens.
- **3.3.2 Record Times.** Record the production time as according to section 3.2.3 in this special note. Also record the time that the specimens were fabricated and the time the Hamburg testing was started. All times shall be recorded on the AMAW.
- **3.3.3 File Name.** Save the Excel spreadsheet with the following file name; "Hamburg\_CID\_Approved Mix Number\_Lot Number\_Sublot Number\_Date" and upload the file into the AMAW.

#### 4.0 Data

Submit the AMAW and all test data that was obtained for acceptance, gradation, KYCT, and Hamburg testing within five working days once all testing has been completed for a lot to Central Materials Lab and the District Materials Engineer. Also, any data and or comments that the asphalt contractor or district personnel deem informational during this experimental phase, shall also be submitted to the Central Materials Lab and the District Materials Engineer. Any questions or comments regarding any item in this Special Note can be directed to the Central Office, Division of Materials, Asphalt Branch.

#### 5.0 KYCT Video Demonstration

https://youtu.be/84j0bM45-hg

#### 6.0 Payment

Any additional labor and testing equipment that is required to fabricate and test the KYCT and Hamburg specimens shall be considered to be incidental to the asphalt surface line item. The Department will perform the testing for the KYCT and Hamburg specimens if a producer does not possess the proper equipment.

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#### SPECIAL NOTE FOR AWARD OF CONTRACT

Contrary to Section 103.02, the Department may hold the Bid Proposals of any or all bidders for a period not to exceed 90 calendar days for final disposition of award. The Department may hold the Bid Proposal of the lowest bidder longer than 90 calendar days if the bidder concurs.

Contrary to Section 103.04, The Department will hold the Proposal Guaranty of the lowest bidder and the Proposal Guaranty of the second lowest bidder, as determined by the Commissioner, until the Department awards the Contract and executes and approves the Contract and bond of the successful bidder, or until the Department rejects all Bid Proposals. If the Department does not make an award within 90 calendar days, the Department will return all Proposal Guaranties.


Except as provided in this note or elsewhere in the proposal, the Department will apply all other applicable portions of Section 103.

1-3002 Award of Contract 01/02/2012

#### SPECIAL NOTE FOR EDGE KEY

Construct Edge Keys at the beginning of project, end of project, at railroad crossings, and at ramps, as applicable. Unless specified in the Contract or directed by the Engineer, do not construct edge keys at intersecting streets, roads, alleys, or entrances. Cut out the existing asphalt surface to the required depth and width shown on the drawing and heel the new surface into the existing surface. The Department will make payment for this work at the Contract unit price per ton for Asphalt Pavement Milling and Texturing, which shall be full compensation for all labor, materials, equipment, and incidentals for removal and disposal of the existing asphalt surface required to construct the edge key.

#### EDGE KEY

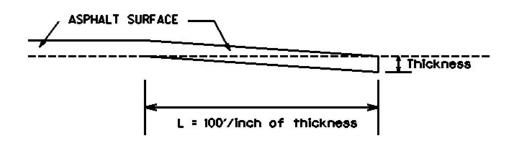

Thickness =  $\underline{1}$  Inch

L = 100 LF

L= Length of Edge Key

1-3309 Edge key by Ton 01/02//2012

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## SPECIAL NOTE FOR ASPHALT MILLING AND TEXTURING

Begin paving operations within <u>two weeks</u> of commencement of the milling operation. Continue paving operations continuously until completed. If paving operations are not begun within this time period, the Department will assess liquidated damages at the rate prescribed by Section 108.09 until such time as paving operations are begun.

Take possession of the millings and recycle the millings or dispose of the millings off the Right-of-Way at sites obtained by the Contractor at no additional cost to the Department.

1-3505 2 weeks Contractor keeps millings 01/2/2012

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#### SPECIAL NOTE FOR TYPICAL SECTION DIMENSIONS

Consider the dimensions shown on the typical sections for pavement and shoulder widths and thickness' to be nominal or typical dimensions. The Engineer may direct or approve varying the actual dimensions to be constructed to fit existing conditions. Do not widen existing pavement or shoulders unless specified elsewhere in this proposal or directed by the engineer.

1-3725 Typical Section Dimensions 01/02/2012

#### TRAFFIC CONTROL PLAN

#### TRAFFIC CONTROL GENERAL

Except as provided herein, maintain and control traffic in accordance with the Standard and Supplemental Specifications and the Standard and Sepia Drawings, current editions. Except for the roadway and traffic control bid items listed, all items of work necessary to maintain and control traffic will be paid at the lump sum bid price to "Maintain and Control Traffic".

Contrary to Section 106.01, furnish new, or used in like new condition, traffic control devices at the beginning of the work and maintain in like new condition until completion of the work.

#### PROJECT PHASING & CONSTRUCTION PROCEDURES

The Engineer may specify days and hours when lane closures will not be allowed.

Maintain alternating one way traffic during construction. Provide a minimum clear lane width of <u>10</u> feet; however, provide for passage of vehicles of up to 16 feet in width. If traffic should be stopped due to construction operations, and a school bus on an official run arrives on the scene, make provisions for the passage of the bus as quickly as possible.

#### LANE CLOSURES

Do not leave lane closures in place during non-working hours.

#### **SIGNS**

Sign posts and splices shall be compliant with NCHRP 350 or MASH. Manufacturer's documentation validating this compliance shall be provided to the Engineer prior to installation. Signs, including any splices, shall be installed according to manufacturer's specifications and installation recommendations. Contrary to section 112.04.02, only long-term signs (signs intended to be continuously in place for more than 3 days) will be measured for payment. Short-term signs (signs intended to be left in place for 3 days or less) will not be measured for payment but will be incidental to Maintain and Control Traffic.

#### CHANGEABLE MESSAGE SIGNS

If deemed necessary by the Engineer, the Department will furnish, operate, and maintain Changeable Message Signs.

Traffic Control Plan Page 2 of 3

#### **TEMPORARY ENTRANCES**

The Engineer will not require the Contractor to provide continuous access to farms, single family, duplex, or triplex residential properties during working hours; however, provide reasonable egress and ingress to each such property when actual operations are not in progress at that location. Limit the time during which a farm or residential entrance is blocked to the minimum length of time required for actual operations, not extended for the Contractor's convenience, and in no case exceeding six (6) hours. Notify all residents twenty-four hours in advance of any driveway or entrance closings and make any accommodations necessary to meet the access needs of disabled residents.

Except as allowed by the Phasing as specified above, maintain direct access to all side streets and roads, schools, churches, commercial properties and apartments or apartment complexes of four or more units at all times.

The Department will measure asphalt materials required to construct and maintain any temporary entrances which may be necessary to provide temporary access; however, the Department will not measure aggregates, excavation, and/or embankment, but shall be incidental to Maintain and Control Traffic. The Engineer will determine the type of surfacing material, asphalt or aggregate, to be used at each entrance.

#### **BARRICADES**

The Department will not measure barricades used in lieu of barrels and cones for channelization or delineation, but shall be incidental to Maintain and Control Traffic according to Section 112.04.01.

The Department will measure barricades used to protect pavement removal areas in individual units Each. The Department will measure for payment the maximum number of barricades in concurrent use at the same time on a single day on all sections of the contract. The Department will measure individual barricades only once for payment, regardless of how many times they are set, reset, removed, and relocated during the duration of the project. The Department will not measure replacements for damaged barricades the Engineer directs to be replaced due to poor condition or reflectivity. Retain possession of the Barricades upon completion of construction.

#### **PAVEMENT MARKINGS**

If there is to be a deviation from the existing striping plan, the Engineer will furnish the Contractor a striping plan prior to placement of the final surface course.

Install Temporary Striping according to Section 112 with the following exception:

Traffic Control Plan Page 3 of 3

If the Contractor's operations or phasing requires temporary markings that must subsequently be removed from the final surface course, use an approved removable lane tape; however, the Department will not measure removable lane tape for separate payment, but will measure and pay for removable lane tape as temporary striping.

#### PAVEMENT EDGE DROP-OFFS

Do not allow a pavement edge between opposing directions of traffic or lanes that traffic is expected to cross in a lane change situation with an elevation difference greater than 1½". Place Warning signs (MUTCD W8-11 or W8-9A) in advance of and at 1500' intervals throughout the drop-off area. Dual post the signs on both sides of the traveled way. Wedge all transverse transitions between resurfaced and unresurfaced areas which traffic may cross with asphalt mixture for leveling and wedging. Remove the wedges prior to placement of the final surface course.

Protect pavement edges that traffic is not expected to cross, except accidentally, as follows:


Less than 2" - No protection required.

2" to 4" - Place plastic drums, vertical panels, or barricades every 50 feet. During daylight working hours only, the Engineer will allow the Contractor to use cones in lieu of plastic drums, panels, and barricades. Wedge the drop-off with DGA or asphalt mixture for leveling and wedging with a 1:1 or flatter slope in daylight hours, or 3:1 or flatter slope during nighttime hours, when work is not active in the drop-off area.

Greater than 4" - Protect drop-offs greater than 4 inches within 10 feet of traffic by placing drums, vertical panels, or barricades every 25 feet. The Engineer will not allow the use of cones in lieu of drums, vertical panels, or barricades for drop-offs greater than 4". Place Type III Barricades directly in front of the drop-off facing on coming traffic in both directions of travel. Provide warning signs as shown on the Standard Drawings or as directed by the Engineer

Pedestrians & Bicycles - Protect pedestrian and bicycle traffic as directed by the engineer.

1-3820 Traffic Control Plan 2 Lane 07/27/2017

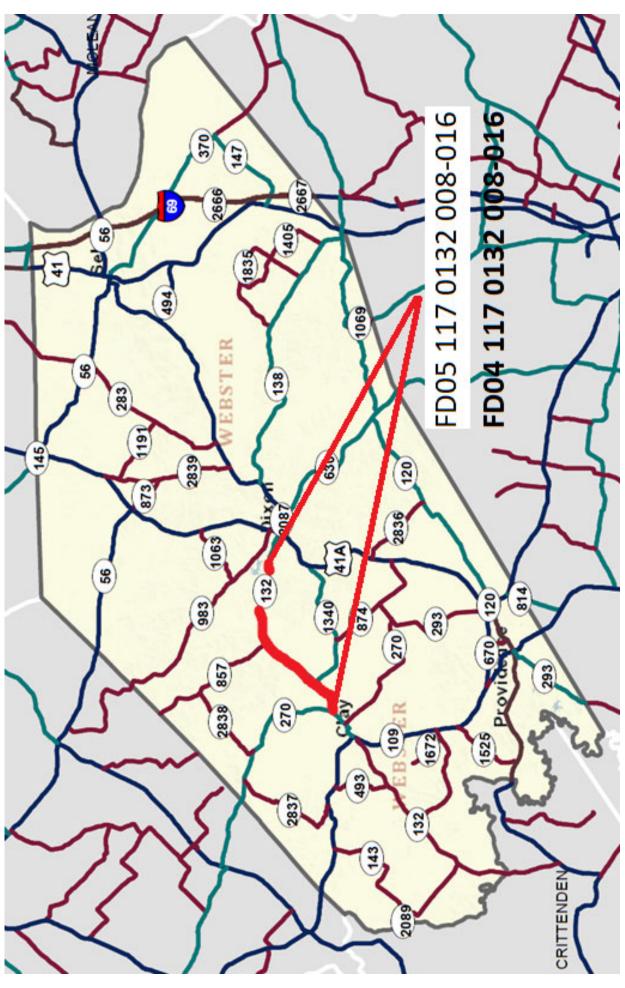

### **MATERIAL SUMMARY**

CONTRACT ID: 212152	117GR21P030 - FD05 & FD04	MP11701322101

CLAY - DIXON (KY 132) BEGINNING 0.061 MILES WEST OF KY 270 EXTENDING EAST TO A POINT 1.771 MILES EAST OF NAT TAYLOR ROAD. ASPHALT RESURFACING, A DISTANCE OF 6.49 MILES.

Project Line No	Bid Code	DESCRIPTION	Quantity	Unit
0005	00001	DGA BASE	1,300.00	TON
0010	00190	LEVELING & WEDGING PG64-22	735.00	TON
0015	00301	CL2 ASPH SURF 0.38D PG64-22	5,340.00	TON
0020	02562	TEMPORARY SIGNS	330.00	SQFT
0025	02650	MAINTAIN & CONTROL TRAFFIC - (FD05)	1.00	LS
0030	02676	MOBILIZATION FOR MILL & TEXT - (FD05)	1.00	LS
0035	02677	ASPHALT PAVE MILLING & TEXTURING	75.00	TON
0040	02697	EDGELINE RUMBLE STRIPS	68,600.00	LF
0045	06510	PAVE STRIPING-TEMP PAINT-4 IN	35,000.00	LF
0050	06515	PAVE STRIPING-PERM PAINT-6 IN	60,000.00	LF
0055	10020NS	FUEL ADJUSTMENT	9,456.00	DOLL
0060	10030NS	ASPHALT ADJUSTMENT	23,751.00	DOLL
0065	24970EC	ASPHALT MATERIAL FOR TACK NON-TRACKING	34.00	TON
0070	02569	DEMOBILIZATION	1.00	LS

### **MATERIAL SUMMARY**

CONTRACT ID: 212152 117GR21P030 - FD05 & FD04 MP11701322102
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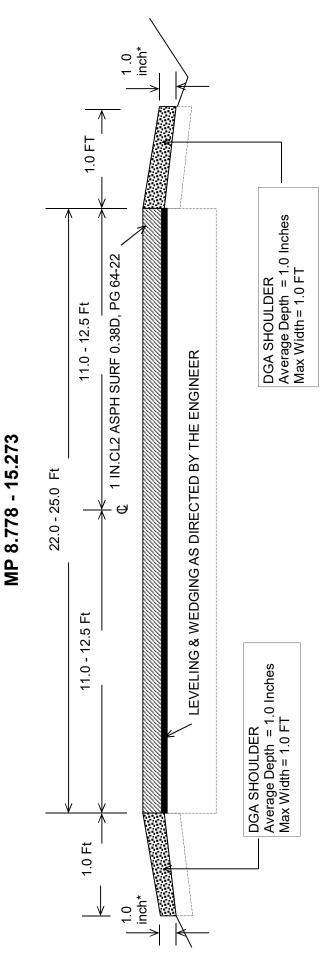
CLAY - DIXON (KY 132) BEGINNING 0.061 MILES WEST OF KY 270 EXTENDING EAST TO A POINT 1.771 MILES EAST OF NAT TAYLOR ROAD. BRIDGE WITH GRADE, DRAIN & SURFACE, A DISTANCE OF 6.49 MILES.

Project Line No	Bid Code	DESCRIPTION	Quantity	Unit
0075	00003	CRUSHED STONE BASE	375.00	TON
0800	00103	ASPHALT SEAL COAT	23.00	TON
0085	00190	LEVELING & WEDGING PG64-22	1,326.00	TON
0090	00212	CL2 ASPH BASE 1.00D PG64-22	844.00	TON
0095	00291	EMULSIFIED ASPHALT RS-2	3.00	TON
0100	00301	CL2 ASPH SURF 0.38D PG64-22	227.00	TON
0105	02676	MOBILIZATION FOR MILL & TEXT - (FD04)	1.00	LS
0110	02677	ASPHALT PAVE MILLING & TEXTURING	229.00	TON
0115	21289ED	LONGITUDINAL EDGE KEY	1,204.00	LF
0120	24970EC	ASPHALT MATERIAL FOR TACK NON-TRACKING	2.00	TON
0125	01987	DELINEATOR FOR GUARDRAIL BI DIRECTIONAL WHITE	12.00	EACH
0130	02014	BARRICADE-TYPE III	4.00	EACH
0135	02230	EMBANKMENT IN PLACE	2,258.00	CUYD
0140	02351	GUARDRAIL-STEEL W BEAM-S FACE	230.00	LF
0145	02355	GUARDRAIL-STEEL W BEAM-S FACE A	100.00	LF
0150	02367	GUARDRAIL END TREATMENT TYPE 1	4.00	EACH
0155	02562	TEMPORARY SIGNS	500.00	SQFT
0160	02585	EDGE KEY	59.00	LF
0165	02650	MAINTAIN & CONTROL TRAFFIC - (FD04)	1.00	LS
0170	02726	STAKING	1.00	LS
0175	08801	GUARDRAIL-STEEL W BEAM-S FACE BR	92.00	LF
0180	20205EC	PAVE MARK STOP BAR-24 IN PAINT	20.00	LF
0185	02701	TEMP SILT FENCE	625.00	LF
0190	02703	SILT TRAP TYPE A	1.00	EACH
0195	02704	SILT TRAP TYPE B	1.00	EACH
0200	02706	CLEAN SILT TRAP TYPE A	3.00	EACH
0205	02707	CLEAN SILT TRAP TYPE B	3.00	EACH
0210	05950	EROSION CONTROL BLANKET	270.00	SQYD
0215	05952	TEMP MULCH	2,300.00	SQYD
0220	05985	SEEDING AND PROTECTION	1,325.00	SQYD
0225	02731	REMOVE STRUCTURE	1.00	LS
0230	23820EC	PRECAST ARCH	1.00	LS
0235	24844EC	UTILITY RELOCATION	1.00	DOLL
0240	02569	DEMOBILIZATION	1.00	LS

#### Milling Summary FD05 117 0132 008-016


				Total	75
Milepoint	Comment	Length	Width	Avg Depth	Tons
8.778	Edge Key	100	24	0.5	7.333
					0.000
8.839	edge key @ 270	250	8	0.5	6.111
					0.000
10.101	edge key @ 1340	50	24	0.5	3.667
11.224	Bridge Ends	200	24	0.5	14.667
12.379	edge key @ 857	50	24	0.5	3.667
12.630	Bridge Ends	200	24	0.5	14.667
14.169	Bridge Ends	200	24	0.5	14.667
15.273	Edge Key	100	24	0.5	7.333
					0.000
					0.000
					0
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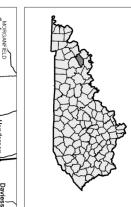
TYPICAL SECTION
WEBSTER COUNTY
FD05 117 0132 008-016



\* Where Existing Site Conditions Permit


WEBSTER COUNTY 117<mark>GR21P030 - FD05 & FD0</mark>4 Contract ID: 212152




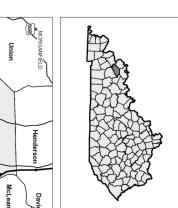



BEGIN CONSTRUCTION'S

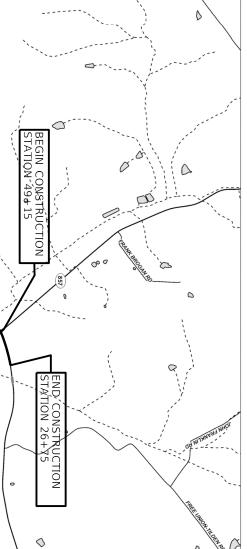

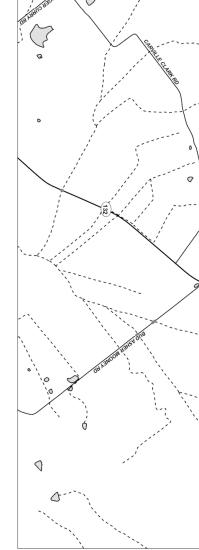



# INDEX OF SHEETS

DESCRIPTION

LAYOUT SHEET
TYPICAL SECTIONS
SUMMARY OF QUANTITIES
PLAN AND PROFILE SHEETS
COORDINATE CONTROL SHEETS
DETAIL SHEETS

SHEET NO. R1 R2 R2A R3-R9 R10 R11-R25

STRUCTURE & GEOTECH PLANS CROSS SECTION SHEETS

> SCALE: 1"=2500" ITEM NO. SHEET NO.


WEBSTER

02-10019

R1

# PROPOSAL PROJECT Webster County

KY 132 Curve Correction

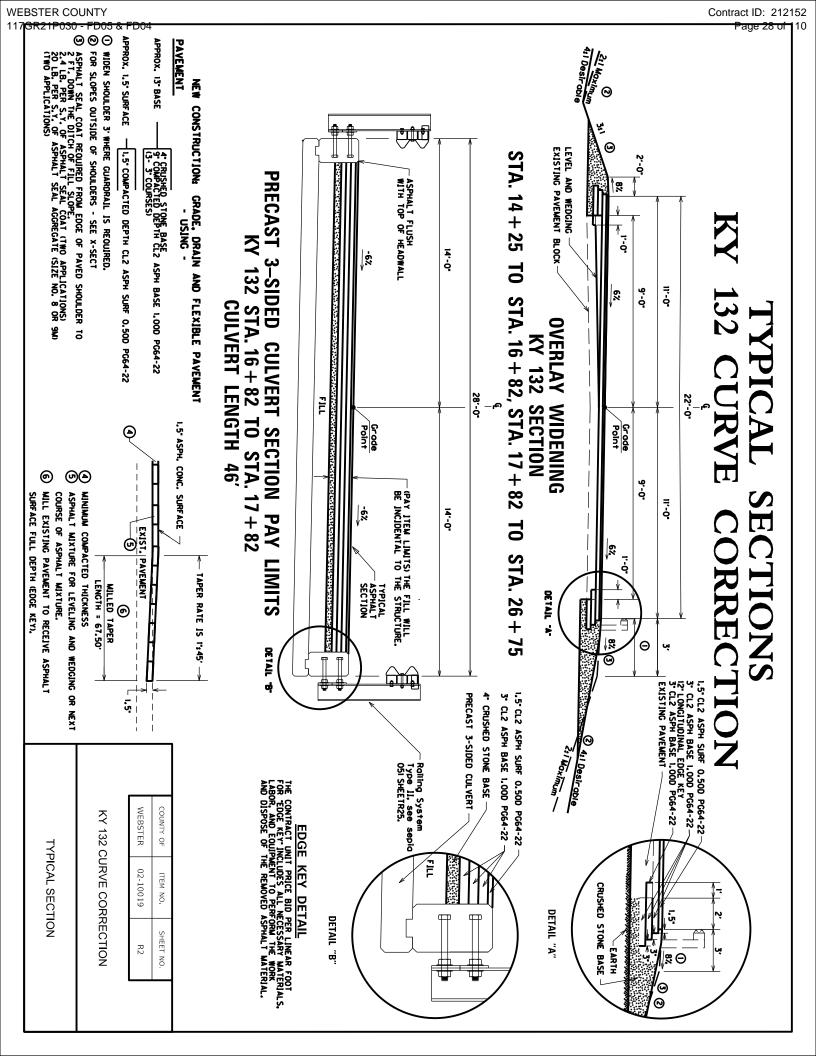

# GENERAL SUMMARY

ITEM	DESCRIPTION	TINU	KY 132	KY 857	TOTAL
00190	LEVEL AND WEDGING ( PAVER MUST BE USED FOR PLACEMENT)	TON	1117	209	1326
01987	DELINEATOR FOR GUARDRAIL BI DIRECTIONAL WHITE	EA	12		12
02014	BARRICADE-TYPE III	EACH	4		4
02230	EMBANKMENT IN PLACE (INCLUDES 1620 FOR EMB BENCHING)	CUYD	2239	19	2258
02351	GUARDRAIL-STEEL W BEAM-S FACE	LF	230		230

02569	DEMOBILIZATION	LS			1
02585	EDGE KEY	뱌	41	18	59
02650	MAINTAIN & CONTROL TRAFFIC	LS			1
02676	MOBILIZATION FOR MILL & TEXT	LS			1
02677	ASPHALT PAVE MILLING & TEXTURING	TON	227	2	229
02701	TEMP SILT FENCE	듀	625		625
02703	SILT TRAP TYPE A	EACH	1		1
02704	SILT TRAP TYPE B	EACH	1		1
02706	CLEAN SILT TRAP TYPE A	EACH	3		3
02707	CLEAN SILT TRAP TYPE B	EACH	3		3
02726	STAKING	LS	1		1
02731	REMOVE STRUCTURE	EACH	1		1
05950	EROSION CONTROL BLANKET	SQYD	270		270
05952	TEMP MULCH	SQYD	2300		2300
05985	SEEDING AND PROTECTION	SQYD	1325		1325
06510	PAVE STRIPING-TEMP PAINT-4 IN YELLOW	두	2500	120	2620
06514	PAVE STRIPING-PERM PAINT-4 IN YELLOW	두	2500	120	2620
08033	TEST PILES (1-VERTICAL)	듀	25		25
08046	PILES-STEEL HP12X53 (9-VERTICAL, 14-BATTERED 4:1)	듀	488		488
08801	GUARDRAIL-STEEL W BEAM-S FACE BR	F	92		92
20205EC	PAVE MARK STOP BAR-24 IN PAINT	F		20	20
23820EC	PRECAST ARCH	ıs	1		1
24605ED	UTILITY RELOCATION ONE POLE	EACH	1		1
24970EC	TRACKLESS TACK	TON	1.5		1.5
08003	FOUNDATION PREPARATION	ıs	1		1
21289ED	LONGITUDINAL EDGE KEY	ᄕ	1204		1204
Notes					

00291

EMULSIFIED ASPHALT RS-2 (INSIDE BRIDGE LIMITS)

1022

86

1108 4

535 267 1022 4

551 267 1108

86 16

EMULSIFIED ASPHALT RS-2 (OUTSIDE BRIDGE LIMITS)

00003 00103 00103

ASPHALT SEAL COAT (OUTSIDE BRIDGE LIMITS) CRUSHED STONE BASE (INSIDE BRIDGE LIMITS) CRUSHED STONE BASE (OUTSIDE BRIDGE LIMITS)

## Notes

# PAVING SUMMARY

267		267		2 3" CL2 ASPH BASE 1.00D PG64-22 (INSIDE BRIDGE LIMITS)	00212
5769	2131	3638		3" CL2 ASPH BASE 1.00D PG64-22 (OUTSIDE BRIDGE LIMITS)	00212
267		267		9 1.5" CL2 ASPH SURF 0.50D PG64-22 (INSIDE BRIDGE LIMITS)	00309
2746	228	2518		1.5" CL2 ASPH SURF 0.50D PG64-22 (OUTSIDE BRIDGE LIMITS)	00309
SC	SQUARE YARDS	SQ			
TOTALS	KY 857	KY 132		ITEM	
0.11		0.11	TON	00291 EMULSIFIED ASPHALT RS-2 (INSIDE BRIDGE LIMITS)	00291
ω	0.21	2.45	TON	00291 EMULSIFIED ASPHALT RS-2 (OUTSIDE BRIDGE LIMITS)	00291
1		1	TON	00103 ASPHALT SEAL COAT (INSIDE BRIDGE LIMITS)	00103
22	2	20	TON	00103 ASPHALT SEAL COAT (OUTSIDE BRIDGE LIMITS)	00103
61		61	TON	00003 CRUSHED STONE BASE (INSIDE BRIDGE LIMITS)	00003
314	00	246	TON	00003 CRUSHED STONE BASE (OUTSIDE BRIDGE LIMITS) INCLUDES 60 TONS FOR ENTRANCES	00003
132		132	TON	00212 3" CL2 ASPH BASE 1.00D PG64-22 (INSIDE BRIDGE LIMITS)	00212
712	114	598	TON	00212 3" CL2 ASPH BASE 1.00D PG64-22 (OUTSIDE BRIDGE LIMITS)	00212
22		22	NOT	00309 1.5" CL2 ASPH SURF 0.50D PG64-22 (INSIDE BRIDGE LIMITS)	00309
227	19	208	TON	00309 1.5" CL2 ASPH SURF 0.50D PG64-22 (OUTSIDE BRIDGE LIMITS)	00309
TOTAL PROJECT	KY 857	KY 132	UNIT	TEM ITEM	ITEM CODE

02367

TEMPORARY SIGNS

SQFT

500 100

ΕA 듀

100 500 4

GUARDRAIL END TREATMENT TYPE 1 GUARDRAIL-STEEL W BEAM-S FACE A

WEBSTER	COUNTY
TER	OF
NONE	ITEM NO.
R2A	SHEET NO.

# KY 132 CURVE CORRECTION


**GENERAL & PAVING SUMMARY** 


<sup>\*</sup>The project completion date will be November 15, 2021 with an intermediate roadway closure period of 30 Calendar days. The contractor can decide when these days occur, provided they do not begin before June 1st and are nished by August 1st. Additional Liquidated Damages of \$2000/day will be assessed in addition to the original contracts Liquidated Damages for failure to re-open the road within the allowable time frame. The contractor will be allowed to re-open the roadway without the nal surface being completed. A bid Item for temporary striping will be included in the bid Items for this contingency.


<sup>\*</sup>For the procurement requirements of the structure, developed notes state that there is a piling layout completed and the bidder must utilize this piling layout for his design. In addition, piling layout changes will not be considered for Value Engineering.

EXISTING RIW

R3

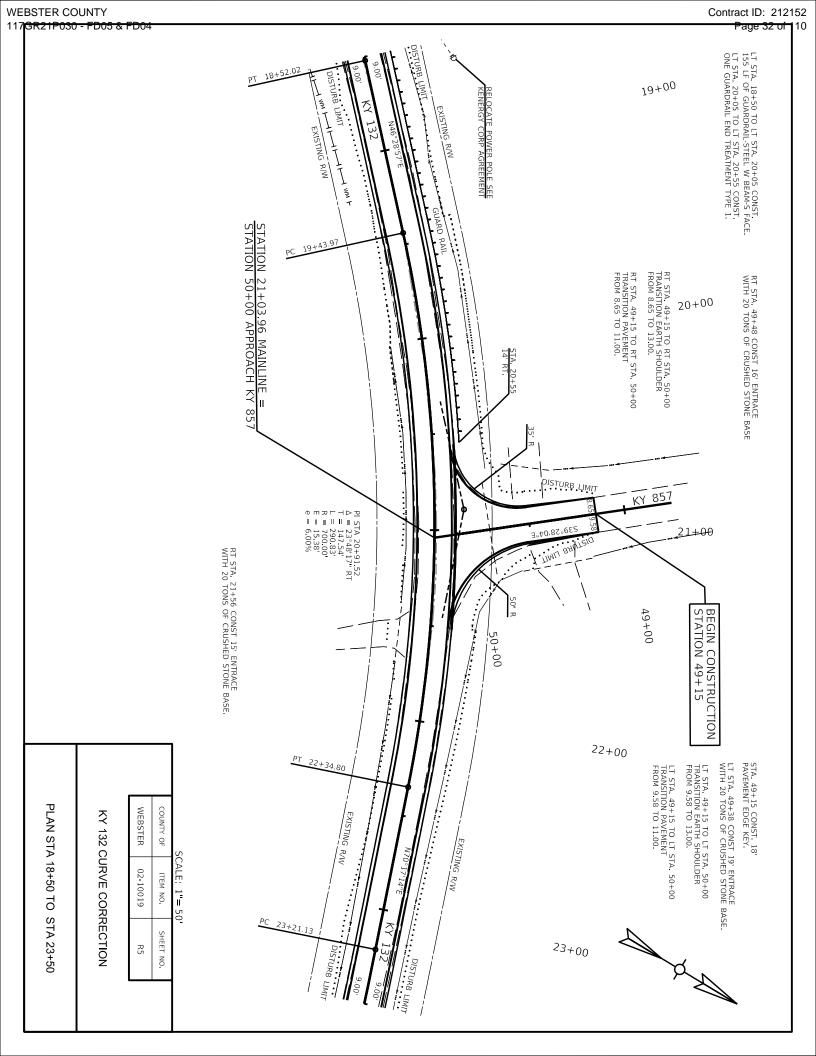


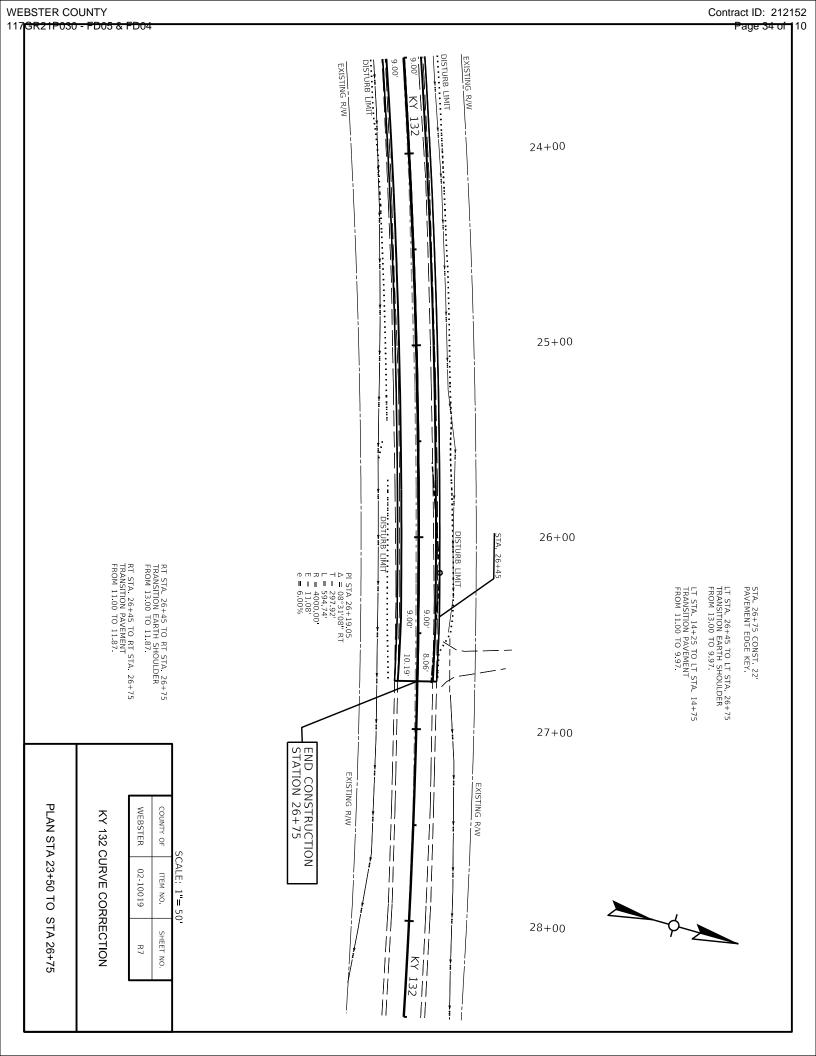

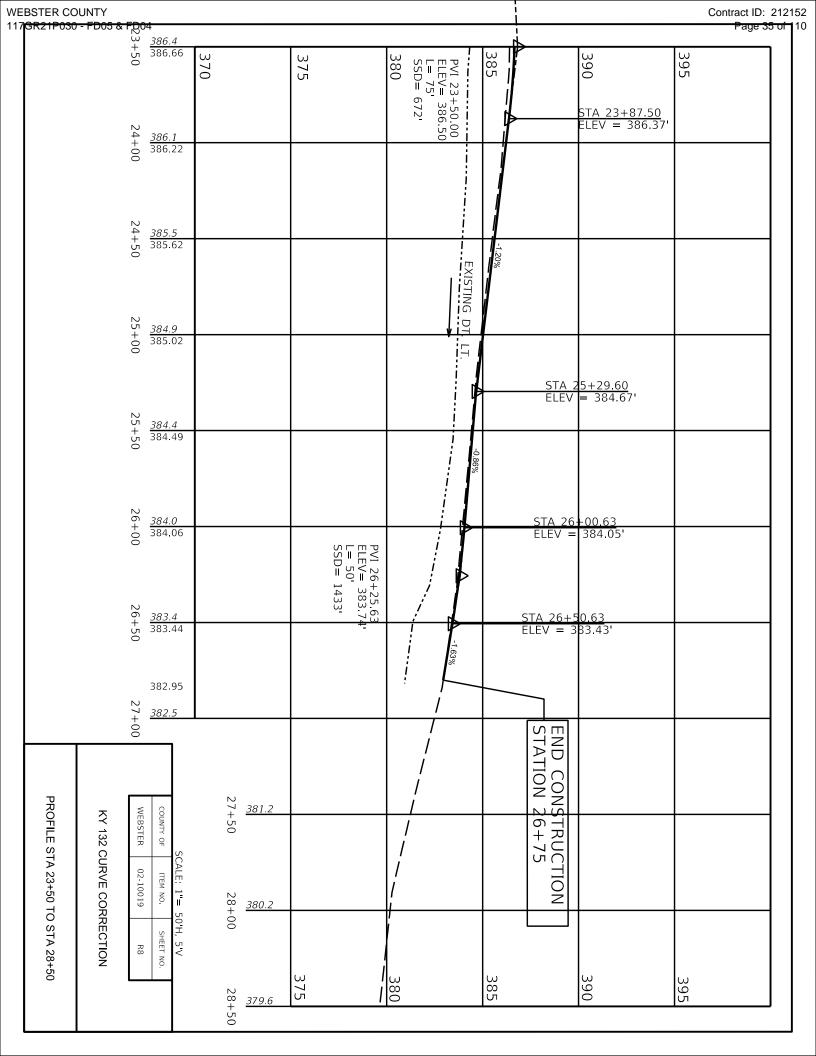

	382	384	388
49 + 00		KY 857	
385.84		STA 49+16.35 ELEV = 385.84'	BEGIN CONSTRUCTION STATION 49+15 OO 80 ELEV = 385.93 5.66.0 0.55 LEV = 385.93 5.66.0
4 9 + 385.5 50			STA 49+68.87 ELEV = 386.64' 49+73.68 ' = 386.69'
O <u>385.4</u> + 385.59		9+78.87 9-78.87 9-78.87 0-70-70-70-70-70-70-70-70-70-70-70-70-70	A 49+88.87 EV = 386.24'
SCALE: 1"= 50'H, 2'V    COUNTY OF	382	386	390

30<sub>≠00</sub>

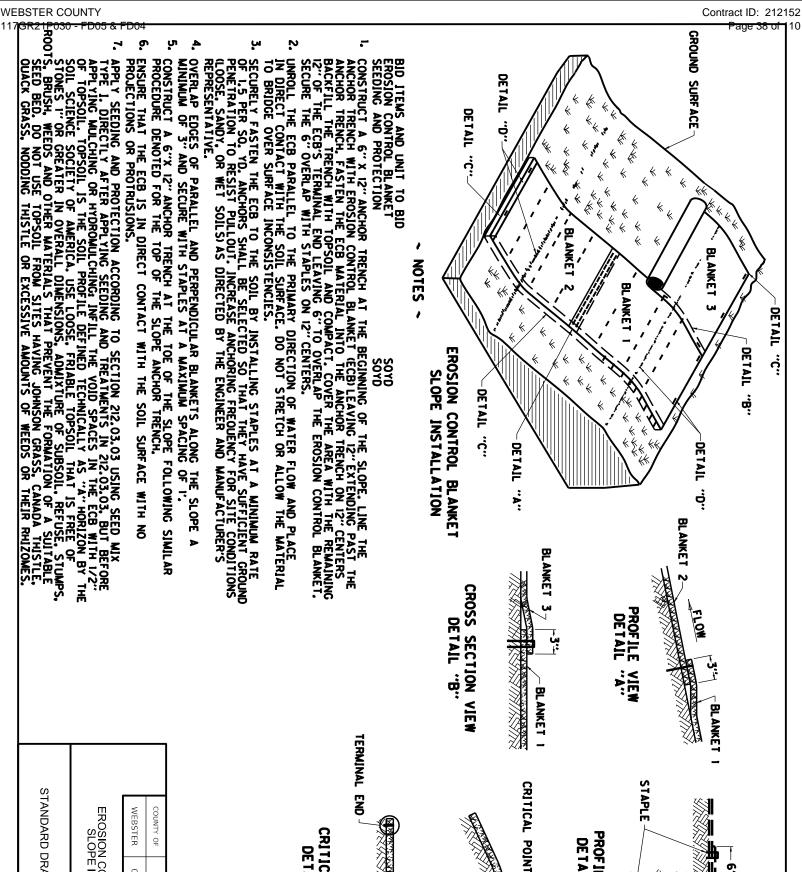

PROFILE VIEW DE TAIL

.. ..

R11	02-10019	WEBSTER	
SHEET NO.	ITEM NO.	COUNTY OF	

CRITICAL POINTS


CRITICAL POINT


TERMINAL END


DETAJL "D"


EROSION CONTROL BLANKET SLOPE INSTALLATION

STANDARD DRAWING NO. RDI-040-01

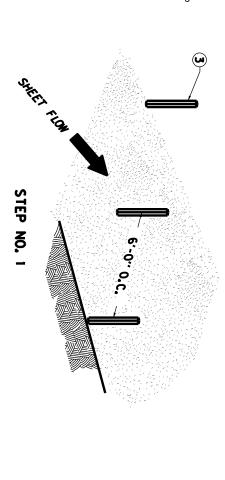

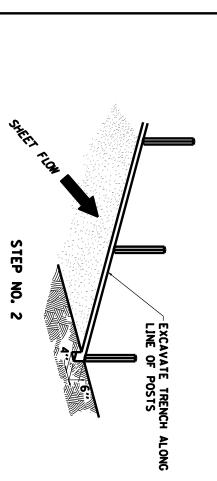

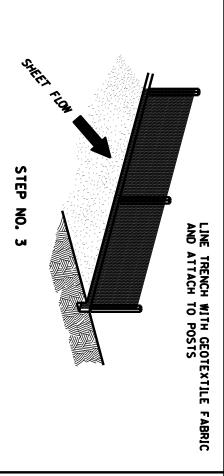

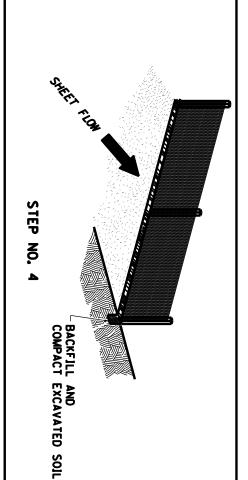

## NOTES >

GEOTEXTILE FABRIC

BID ITEM AND UNIT TO BID TEMP SILT FENCE

I. SEE STANDARD SPECIFICATIONS FOR POST SIZE, GEOTEXTILE FABRIC, WIRE STAPLES AND ALL OTHER PERTINENT INFORMATION.

2) POSTS MAY BE WOODEN OR METAL T-SECTION.
3) POSTS SHALL BE SET 1'-4" DEEP.





WEBSTER	COUNTY OF
02-10019	ITEM NO.
R13	SHEET NO.


TEMPORARY SILT FENCE


STANDARD DRAWING NO. RDX-210-03


Contract ID: 212152

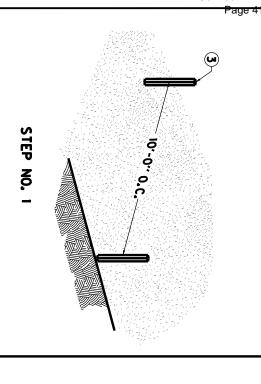


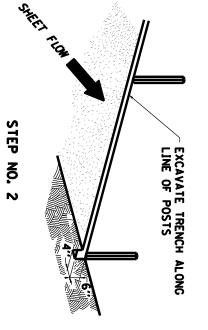

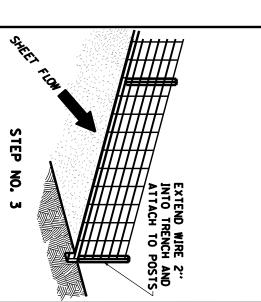

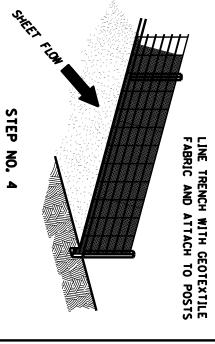

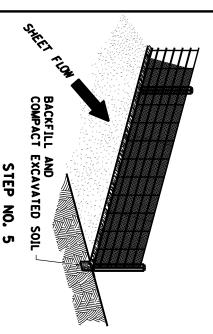

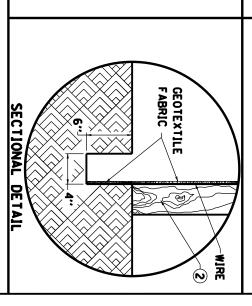

## NOTES


BID ITEM AND UNIT TO BID TEMP SILT FENCE


- SEE STANDARD SPECIFICATIONS FOR POST SIZE, WOVEN WIRE FENCE FABRIC, GEOTEXTILE FABRIC, WIRE STAPLE AND ALL OTHER PERTINENT INFORMATION.
- ② POSTS WAY BE WOODEN OR METAL T-SECTION.

  ③ POSTS SHALL BE SET 1'-4" DEEP.

TEMPO WOVEN V	WEBSTER	COUNTY OF
TEMPORARY SILT FENCE WITH WOVEN WIRE FENCE FABRIC	02-10019	ITEM NO.
FENCE E FABRIC	R14	SHEET NO.


STANDARD DRAWING NO. RDX-215-01

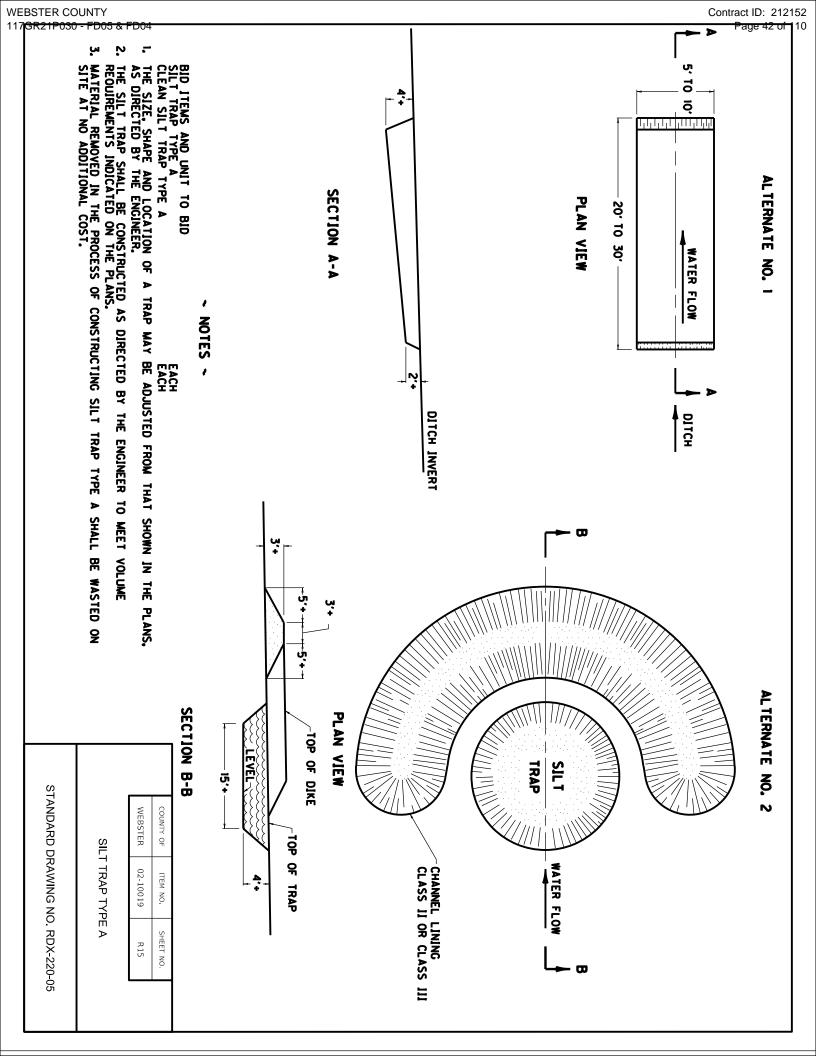

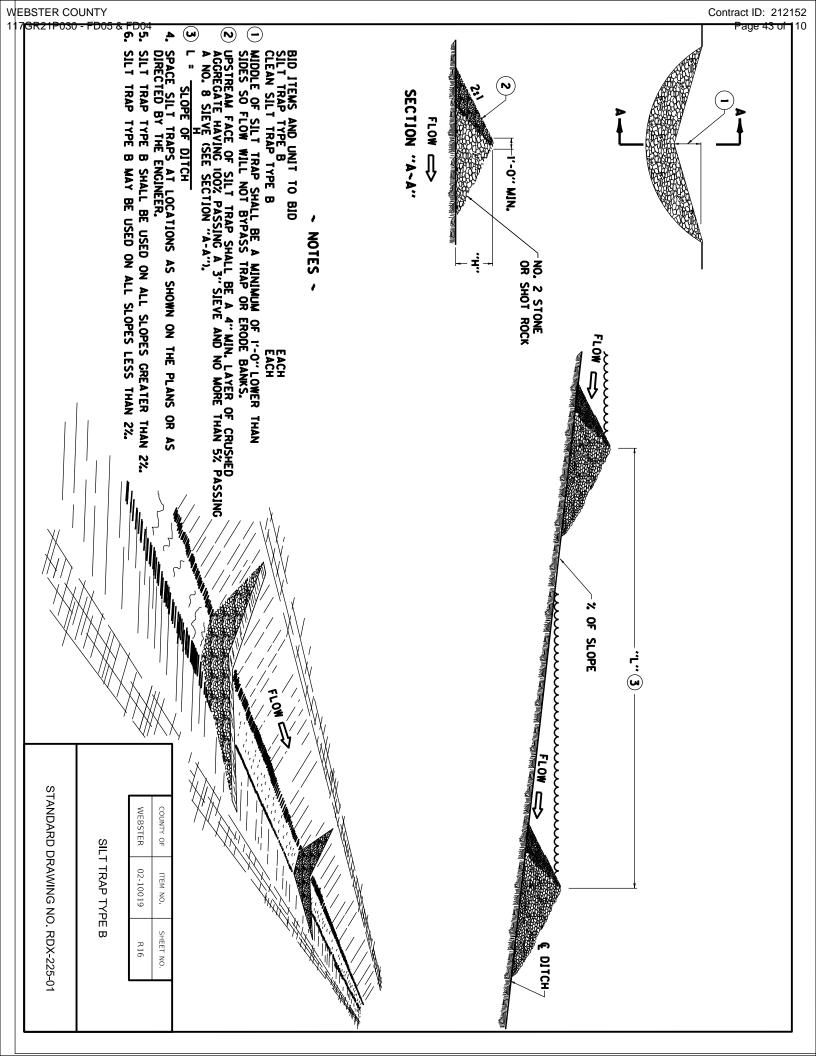



NOTES


- DEFINITE DESIGN INFORMATION CANNOT BE ESTABLISHED AS TO THE SIZE OF THESE BENCHES, DUE TO THE IRREGULARITIES AND THE DIFFERENT RATES OF INCLINE OF THE EXISTING CROSS SECTION, HOWEVER, IT IS GENERALLY BELIEVED THAT A 6° TO 12° RISE AND A 20° TO 35° HORIZONTAL RUN IS FAIRLY TYPICAL WITH A 15° HORIZONTAL RUN BEING THE MINIMUM. THIS TREATMENT FOR EMBANKMENT FOUNDATION BENCHES, AS INDICATED ON THIS SHEET, SHALL BE ACCEPTED AS GUIDES FOR HIGHWAY DESIGN, HOWEVER, ALL THE CONDITIONS THAT WILL BE ENCOUNTERED CANNOT BE SHOWN, SO THE DESIGNER MUST GIVE CONSIDERABLE THOUGHT TO THE LOCATIONS AND DIMENSIONS OF THESE BENCHES.
- WHEN THE INCLINE OF THE CROSS SECTION IS 15% OR GREATER THESE EMBANKMENT FOUNDATION BENCHES SHALL BE CONSTRUCTED IN THE ORIGINAL SLOPE AS THE EMBANKMENT IS CONSTRUCTED IN COMPACTED LAYERS OR LIFTS.
- WHEN EMBANKMENT FOUNDATION BENCHES ARE SHOWN ON THE CROSS SECTION, THE VOLUME SHALL BE COMPUTED AS ROADWAY EXCAVATION OR EMBANKMENT IN PLACE AS APPLICABLE AND SHOWN IN THE SHEET TOTALS AND BROUGHT FORWARD TO BE INCLUDED IN THE TOTAL EARTHWORK WITH THE NOTE "TOTAL INCLUDES "X" NUMBER OF CUBIC YARDS FROM EMBANKMENT FOUNDATION BENCHES."
- THE EXCAVATION FROM THESE BENCHES WILL NOT BE SHOWN IN THE DISTRIBUTION OF QUANTITIES BUT THEY WILL DEFINITELY BE A PAY QUANTITY BY VIRTUE OF THE FACT THAT THEY ARE INCLUDED IN THE TOTAL OF ROADWAY EXCAVATION QUANTITIES.
- NO QUANTITIES WILL BE ALLOWED FOR THE REFILING OF THESE BENCHES, SINCE SUPPOSEDLY, THE MATERIAL THAT WAS EXCAVATED WILL BE PROCESSED AND PLACEDD BACK IN THESE BENCHES.
- IF THE CROSS SECTION IS AN EARTH ONE. THAT IS IF NO ROCK IS SHOWN, THEN THE FOUNDATION BENCHES SHALL BE INDICATED ON THE CROSS SECTION AND CONSTRUCTED AS SHOWN BY THE DRAWING AND THE VOLUME OF EXCAVATION BECOMES A PAY ITEM AS ROADWAY EXCAVATION OR EMBANKMENT IN PLACE AS APPLICABLE, IN OTHER WORDS, SUPPORT BENCHING OF EARTH SECTIONS SHALL BE GIVEN SAME TREATMENT AS ROCK OR NEAR ROCK SECTION.
- SHOULD IT BE EVIDENT, AT THE TIME OF CONSTRUCTION, THAT THE ENGINEER FINDS AND SO DIRECTS THAT THE EMBANKMENT FOUNDATION BENCHING IS NECESSARY AND IT IS NOT SO INDICATED ON THE DESIGN CROSS SECTIONS THE BASIS OF PAYMENT SHALL BE AS HEREIN BEFORE STATED.

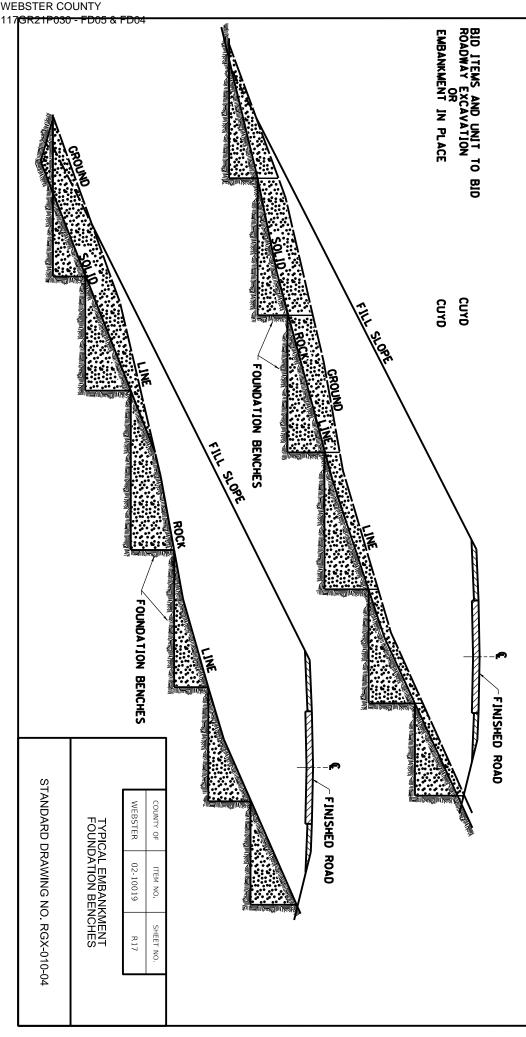

STANDARD DRAWING NO. RGX-010-04

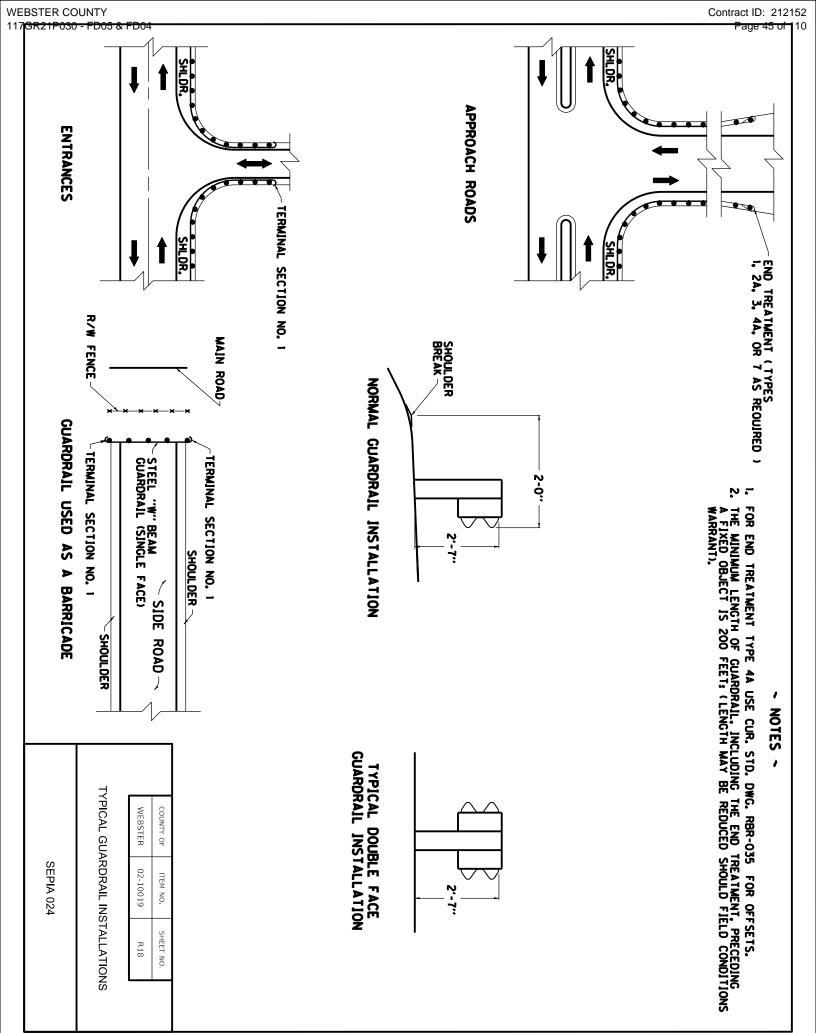

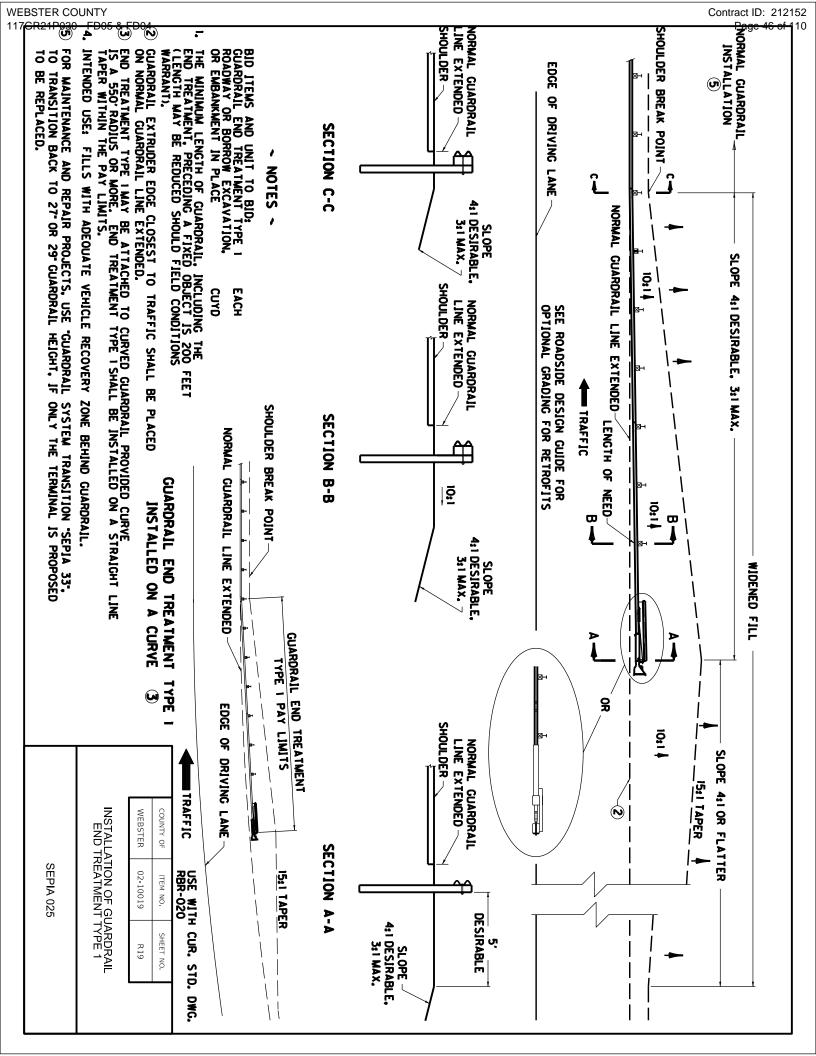

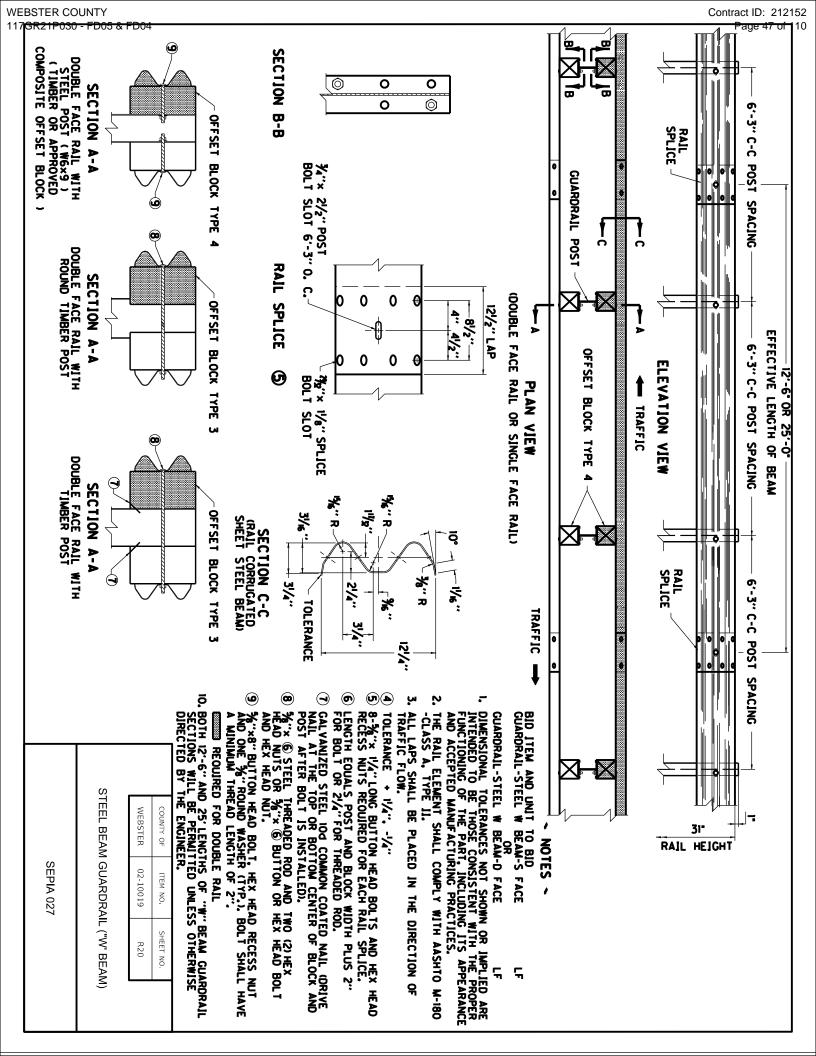


SIDE VIEW 11/8" (ΤΥΡ) + FRONT VIEW <u>©</u> THIS HOLE REOUIRED
FOR RUB RAIL
OPTIONAL IF NO
RUB RAIL ~1‰" HOLE (TYP) ι<mark>//8</mark>" (ΤΥΡ) — SECTION A-A - (2) HOLES 7" DOWN FRONT & BACK (JF REOUJRED)

~ NOTES ~

- W6 X 8.5 IS AN ACCEPTABLE ALTERNATE.
- **⊗**⊝ THESE HOLES ARE REQUIRED FOR ATTACHING RAIL.
- TIMBER OR COMPOSITE BLOCKOUTS MAY BE USED WITH STEEL POST.

Θ

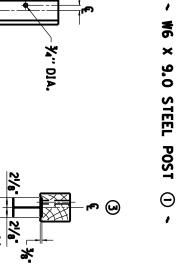


REAR ELEVATION


1'-2"

PLAN VIEW


<u>-</u>4<u>'</u>/.

(TIMBER OR APPROVED COMPOSITE) (FOR USE WITH STEEL POST ONLY) OFFSET BLOCK TYPE 4 6" X 8" (Nominal Size)

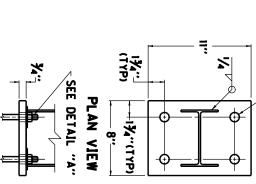

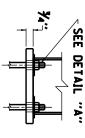

ANCHOR PLATE SIDE VIEW

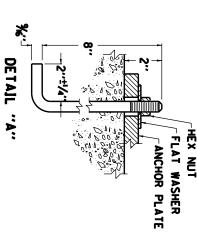



4 HOLES I" DIA.


WEBSTER	COUNTY OF
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STEEL GUARDRAIL POSTS

SEPIA 028



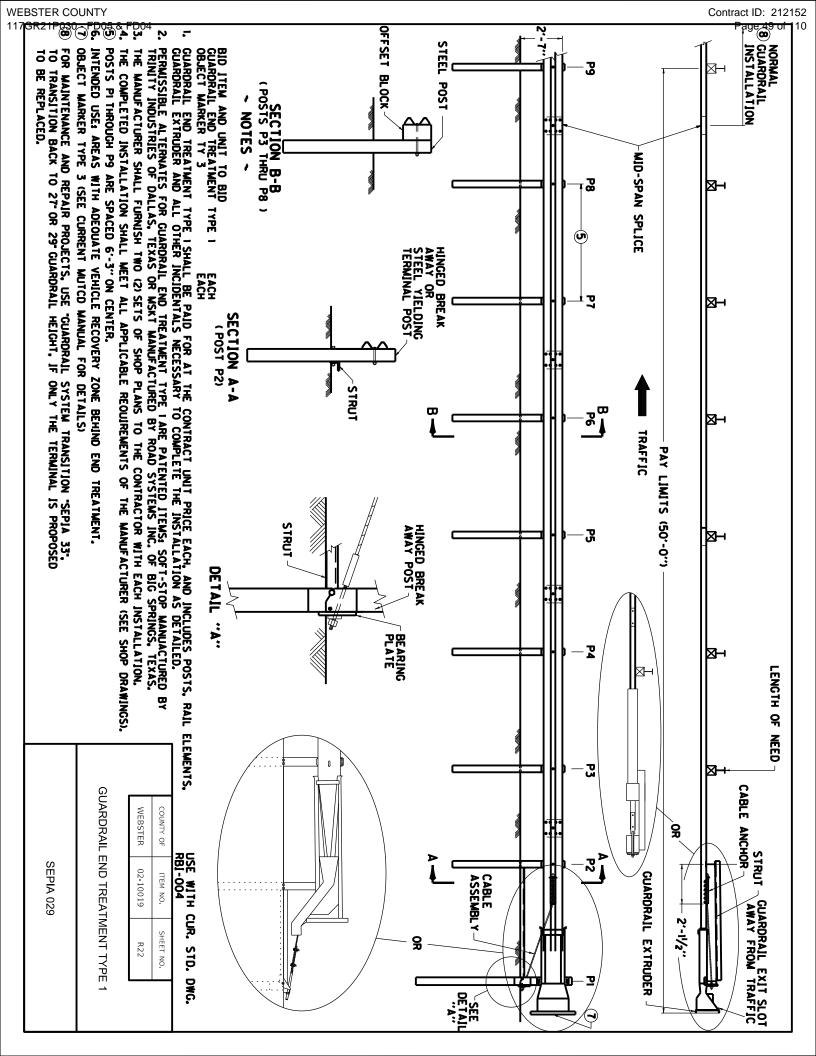

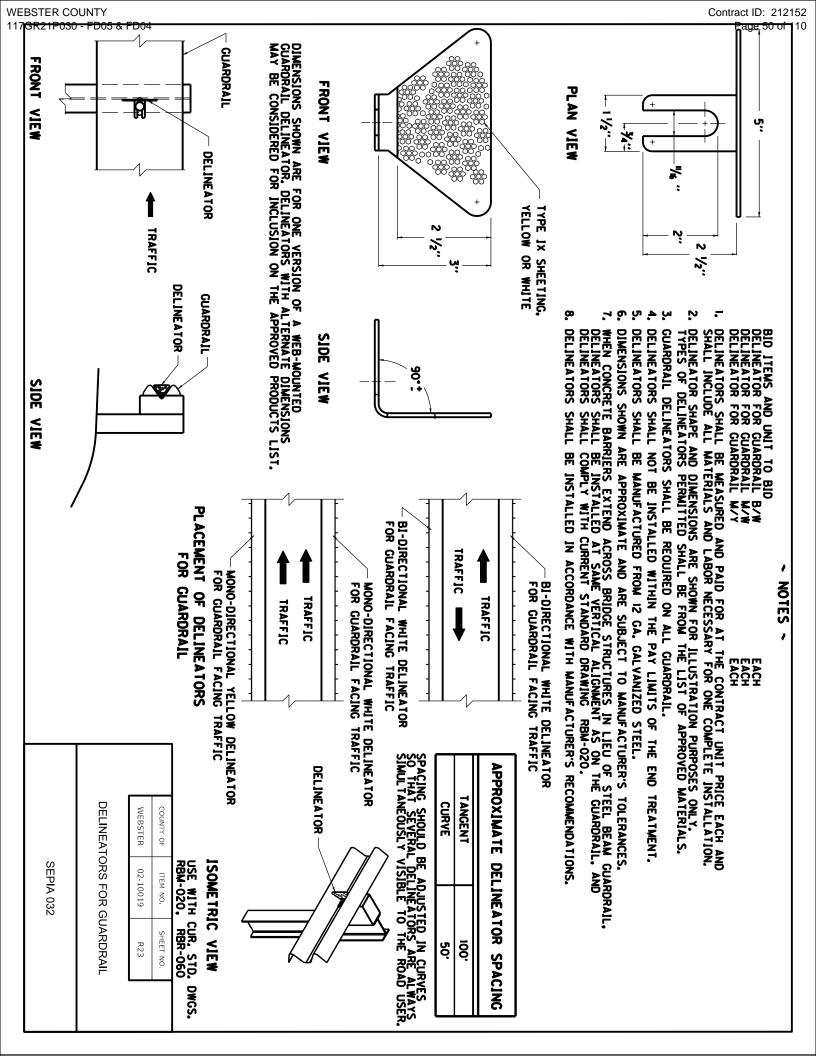

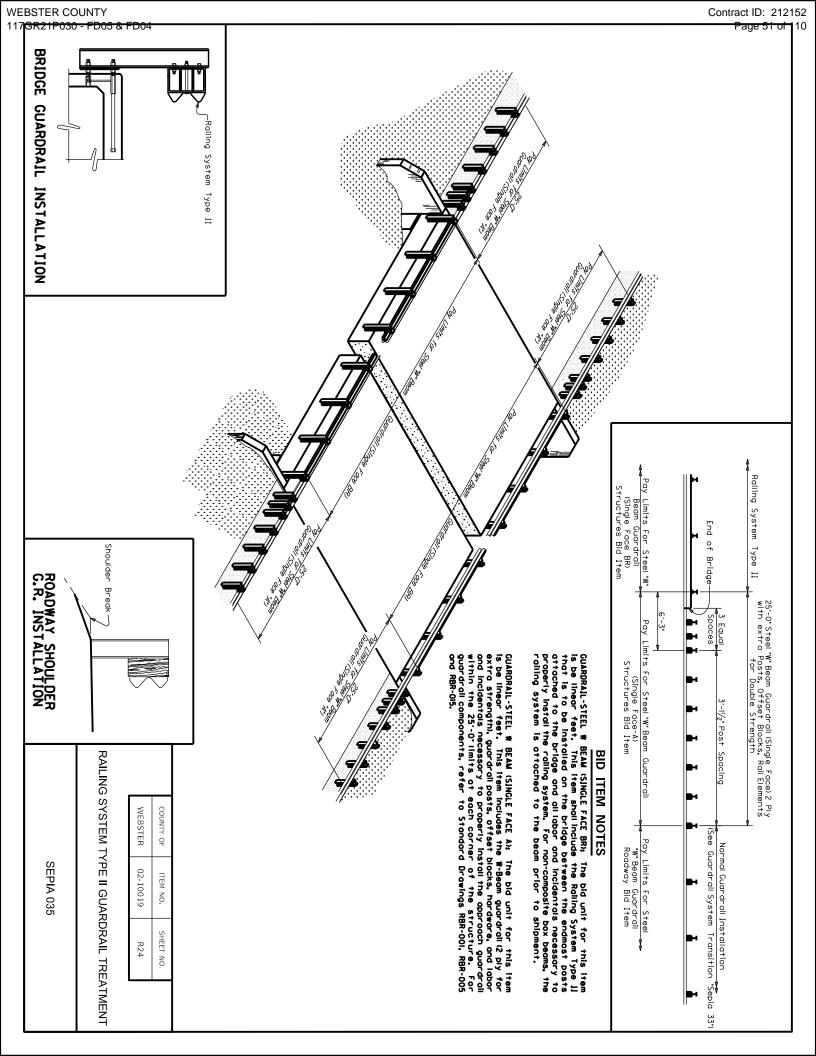
#### NOTES

- NERAL NOTES:

  THIS BRIDGE HAS BEEN DESIGNED FOR GENERAL SITE CONDITIONS, THE THIS BRIDGE HAS BEEN DESIGNED FOR GENERAL SITE CONDITIONS, THE PROJECT ENGINEER SHALL BE RESPONSIBLE FOR THE STRUCTURE'S SUITABILITY TO THE EXISTING SITE CONDITIONS AND FOR THE HYDRAULIC EVALUATION—INCLUDING SCOUR AND CONFIRMATION OF SOIL CONDITIONS.
- PRIOR TO CONSTRUCTION, CONTRACTOR MUST VERIFY ALL ELEVATIONS SHOWN THROUGH KYTC.

# WEBSTER COUNTY, KENTUCKY **KY 132 OVER NALL DITCH**

- ALTERNATE STRUCTURES MAY BE CONSIDERED, PROVIDED THAT DRAWNINGS AND CALCULATIONS ARE SIGNED AND SEALED BY A PROFESSIONAL ENGINEER, REGISTERED IN THE STATE OF KENTUCKY.
- ALTERNATE STRUCTURES MAY BE CONSIDERD, PROVIDED THAT THE ALTERNATE DESIGN DOES NOT REDUCE THE HYDRAULIC OPENING OF THE STRUCTURE MISS SHOWN ON THE DRAWINGS. AT A MINIMUM THE ALTERNATE STRUCTURE MUST PROVIDE THE SAME OR LARGER SPAN AND RISE AS THE STRUCTURE SHOWN ON THE DRAWINGS.

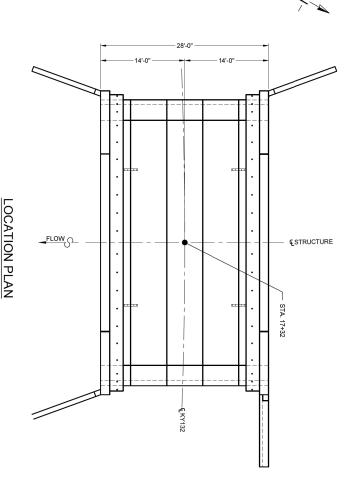

## DESIGN DATA

DESIGN LOADING:

BRIDGE UNITS: KYH. 93

BRIDGE UNITS: KYH. 93

BRIDGE UNITS: KYH. 93

BRIDGE UNITS: KYH. 93

BRIDGE UNITS: KYH. 94

BRIDGE UNITS: KYH. 94

BRIDGE UNITS: KYH. 94

BRIDGE UNITS: KYH. 94

BRIDGE LOAD IMPACT

DESIGN FILL HEIGHT: 1-0\* MIN. TO 2-0\* MAX.

FROM TOP OF GROWN. TO 170 POF PAKENENIT.

DESIGN METHOD: LOAD AND RESISTANCE FACTOR DESIGN PER AASHTO LRFD BRIDGE

DESIGN SPECIFICATIONS

DESIGN METHOD: LOAD AND RESISTANCE FACTOR DESIGN PER AASHTO LRFD BRIDGE

BRIDGE BRESISTANCE: 375 KIPS

FACTORED PIE RESISTANCE: 375 KIPS

LATERAL PILE CAPACITY: 20 KIPS

"FOUNDATION EXCAVATION AND SUBGRADE PREPARATION SHALL BE IN ACCORDANCE WITH THE GEOTIECHNICAL REPORT FOR THIS PROJECT PREPARED BY AMERICAN ENGINEERS, INC. 8/16/2019.

## MATERIALS

CONCRETIE FOR FOOTINGS SHALL HAVE A MINIMUM COMPRESSIVE STRENGTH OF 4000 PSI, PRINFAPCING STREE FOR FOOTINGS SHALL CONFORM TO ASTM A615 OR A996-GRADE 60. PILES IN ACCORDANCE WITH SECTION 604 OF THE KENTUCKY STANDARD SPECIFICATION FOR ROAD AND BRIDGE CONSTRUCTION, CURRENT EDITION.


WEBSTER COUNTY 117GR21P030 - FD05 & F

#### COUNTY OF WEBSTER 02-10019 ITEM NO. SHEET NO.


NOT TO SCALE

KY 132 CURVE CORRECTION

**LOCATION PLAN** 

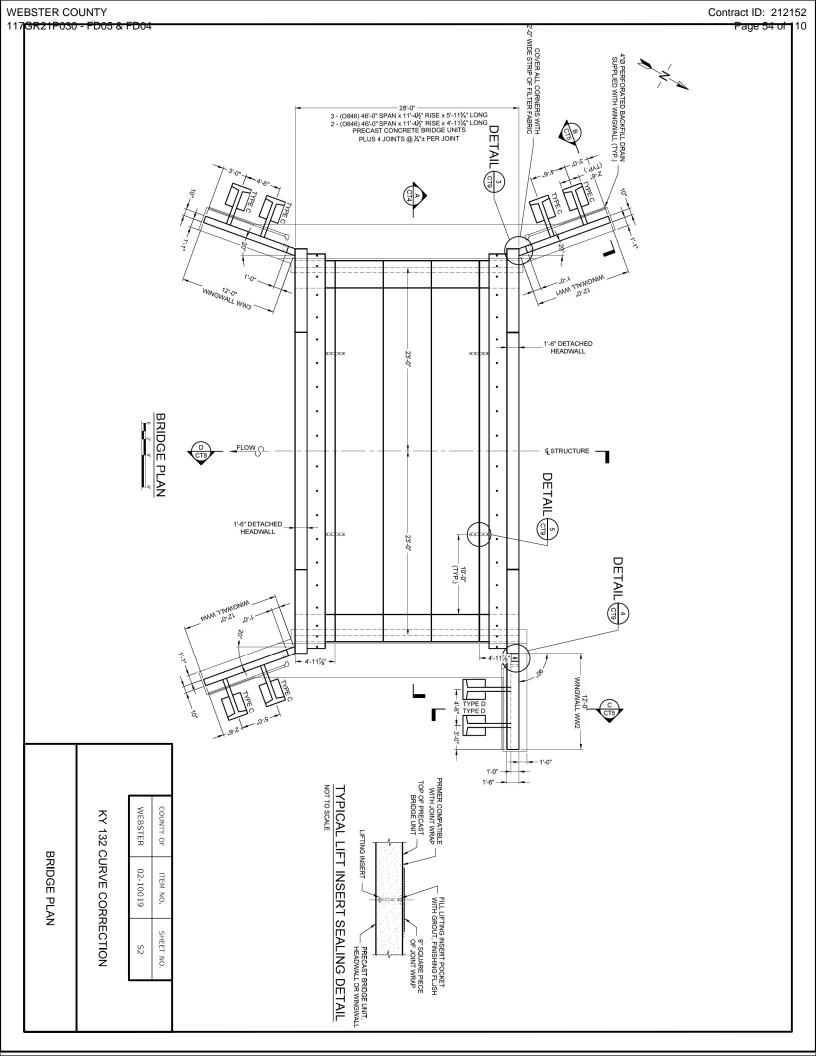

Contract ID: 212152 <del>age 55 of </del>10

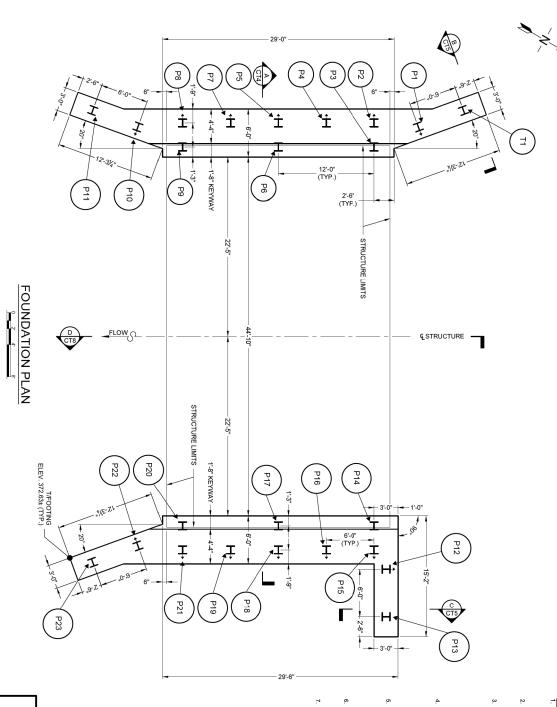

- PLAN NOTES:
  1. FOUNDATION EXCAVATIONS SHOULD BE PROPERLY BRACED/SHORED TO PROVIDE ADEQUATE SAFETY TO PEOPLE WORKING IN OR AROUND THE EXCAVATIONS.
  BRACING SHOULD BE PERFORMED IN ACCORDANCE WITH APPLICABLE FEDERAL,
  STATE AND LOCAL GUIDELINES.
- TEMPORARY SHORING, SHEETING, COFFERDANS, ANDOR DEWLIFERING METHODS MAY BE REQUIRED TO FACULTATE FOUNDATION, FONSTRUCTION, IT SHOULD BE ANTICIPATED THAT GROUNDWATER WILL BE ENCOUNTERED AT FOUNDATION LOCATIONS WITHIN THE
- A DIESEL PILE DRIVING HAMMER WITH A RATED ENERGY BETWEEN 47 FOOT-WES AND 83 FOOT-WES WILL BE REQUIRED TO DRIVE 12X5S STEEL HEADES TO PRACTICAL REFUSAL WITHOUT ENCOUNTERING ENCESSIVE BOWN COUNTS OR DAMAGNOTHE PILES. THE CONTRACTOR SHALL SHAULT FOR APPROVAL PROOR TO THE INSTALLATION OF THE FIRST PILE. APPROVAL OF THE FILE DRIVING SYSTEM OF THE FIRST PILE. APPROVAL OF THE FILE DRIVING SYSTEM OF THE GROTECHNICAL ENGINEER WILL BE SUBJECT TO SATISFACTORY FIELD PERFORMANCE OF THE PILE DRIVING
- A. FOR THIS PROJECT, MINIMUM BLOW REQUIREMENTS MAY BE REACHED AFTER TOTAL PROTECTIONS.

  4. FOR THIS PROJECT, MINIMUM BLOW REQUIREMENTS MAY BE REACHED AFTER TOTAL PROTECTION BECOMES S. VINCH OR LESS FOR TEN CONSECUTIVE BLOWS, PRACTICAL REFUSAL IS OBTAINED AFTER THE PILE IS STRUCK, MA ADDITIONAL TEN BLOWS WITH TOTAL PREMETRATION OF S. VINCH OR LESS. ADVANCE THE REPODUCTION PILING TO THE DRIVING RESISTANCES SPECIFIED ON CTI, AND TO DEPTHS DETERMINED BY TEST PILE(S). MARCED THE LYCCASE DRIVING OPERATIONS IF THE PILE PROTECTION PILES OR BECOMES DAMAGED DURING DRIVING.

  5. IF HADD DRIVING IS ENCOUNTERED BECAUSE OF DENSE STRATA OR AN OBSTRUCTION, SUCH AS A BOULDER BEFORE THE PILE IS ADVANCED THE CHEETH ANTICIPATED. THE GEOTECHNING DRIVING OPERATIONS IF THE PILE IS INSURING THE CHEETH ANTICIPATED. THE GEOTECHNING DRIVING PRACTICAL REFUSAL IS REQUIRED TO OF URTHER ADVANCE THE PILE FOR ADDITIONAL PRODUCTION MUD TEST PILES IF DIRECTED BY THE GEOTECHNING. BROWNING PRACTICAL REFUSAL IS REQUIRED TO CHETCHER TO ADDITIONAL PRODUCTION MUD TEST PILES IF DIRECTED BY THE GEOTECHNING. BROWNING PILES TO ALLOW FOR THE CURRENT TRAINING OF THE CHEMPLANT TON OF THE KENTUCKY DEPARTMENT OF HIGHWAYS STANDARD SPECIFICATIONS FOR ROAD THE KENTUCKY TRANSPORCED PILE POINTS CAPABLE OF PREFERENTING BOULDERS AND EACH BROWLED IN THE TOP OF BEDROCK, USE OF REPORCED PILE POINTS CAPABLE OF PREFERENTING BOULDERS AND HADD LAYERS WHICH HAY BE ENCOUNTERED IS RECOMMENDED. INSTALLATION OF PILE POINTS SHOULD BE MACORDANCE WITH SECTION AND THE KENTUCKY STANDARD SPECIFICATIONS FOR ROAD AND BRIDGE CONSTRUCTION, CURRENT EDITION.

NOTE: LAP (3-0") #6 LONGITUDINAL BARS IN WINGWALL AND BRIDGE FOOTINGS TO MAKE CONTINUOUS

\*\* BATTERED 4:1 HP12 x 53 PILE (50 KSI)

\*\*YERTICAL HP12 x 53 PILE (50 KSI)

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KY 132 CURVE CORRECTION

FOUNDATION PLAN

## Field Data

For each pile, the Project Engineer shall record the following on this sheet: Pile Length in Place and Point of Pile Elevation as Driven.

Submit this record to:

Kentucky Transportation Cabinet Director, Division of Structural Design 3rd Floor East 200 Mero Street

This pile record does not replace other pile records the Project Engineer is required to keep and submit.

Frankfort, KY 40622

Use HP 12x53 in accordance with BPS-003, c.e.

## **Definitions of Terms**

PILE CUT-OFF ELEVATION: Elevation of the top of pile in the finished structure. PILE LENGTH IN PLACE: Actual pile length below the Pile Cut-Off Elevation in the finished structure.

POINT OF PILE ELEVATION AS DRIVEN: Actual point of pile elevation in the finished structure.

DESIGN AXIAL LOAD: Load carried by each pile as estimated from structural design calculations for Factored LRFD Loadings.

CALCULATED FIELD BEARING: Contrary to Section 604.03.07 of the Standard Specifications, in place bearing values are not required for piles bearing on rock when driven to practical refusal.

## **Driving Criteria**

DRIVING CRITERIA: Drive point bearing piles to practical refusal.

PRACTICAL REFUSAL (Case 2): For this project minimum blow requirements are reached after total penetration becomes  $l_2^{\prime}$  or less for 10 consecutive blows, practical refusal is obtained after the pile is struck an additional 10 blows with total penetration of  $l_2^{\prime}$  or less. Advance the production piling to the driving resistances specifed above and to depths determined by test pile(s) and subsurface data sheet(s). Immediately cease driving operations if the pile visibly yields or becomes damaged during driving. If hard driving is encountered because of dense strata or an obstruction, such as a boulder before the pile is advanced to the depth anticipated, the Engineer will determine if more blows than the average driving resistance specified for practical refusal is required to further advance the pile. Drive additional production and test piles if directed by the Engineer.

_	PILE RECORD	AD FOR POINT	INI BEAKING	G PILES
	Pile	Pile	Point of Pile	Design
Pile	Cut-off	Length	Elevation	Axial
<u>0.</u>	Elevation	In Place	As Driven	Load
	FEET	FEET	FEET	TONS
11	369.13			
P	369.13			
Ρ2	369.13			
Р3	369.13			
Ρ4	369.13			
P5	369.13			
P6	369.13			
P7	369.13			
8A	369.13			
Р9	369.13			
P I 0	369.13			
PII	369.13			
P I 2	369.13			
P I 3	369.13			
P I 4	369.13			
P I 5	369.13			
P I 6	369.13			
P I 7	369.13			
P I 8	369.13			
P 19	369.13			
P20	369.13			
P2	369.13			
P22	369.13			
P23	369.13			
*	DESIGN AVIAL LOAD	TO BE		

DESIGN AXIAL LOAD TO BE CALCULATED BY VENDOR.

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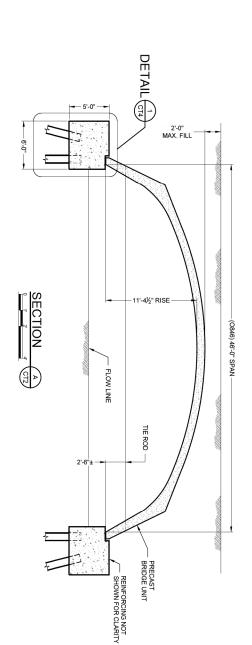
KY 132 CURVE CORRECTION


PILE RECORDS


WEBSTER COUNTY

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TYPICAL BRIDGE UNIT GROUT DETAIL NOTTO SCALE

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DETAILS

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GUARDRAIL NOT CAST IN WINGWAL

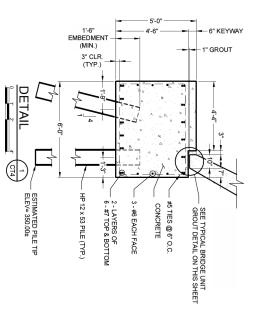1'-6"

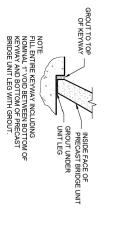VARIES FROM 14'-91/2" TO 14'-91/2"

PRECAST WINGWALL

1: 0:

တူ

4"Ø WEEPHOLE


6'-0½" MAX.

WW2 = 4'-6' 1" GROUT

1.0

0

SEE TYPICAL WINGWALL GROUT DETAIL ON THIS SHEET SPECIFICATIONS BACKFILL PER TYPE D WINGWALL ANCHOR

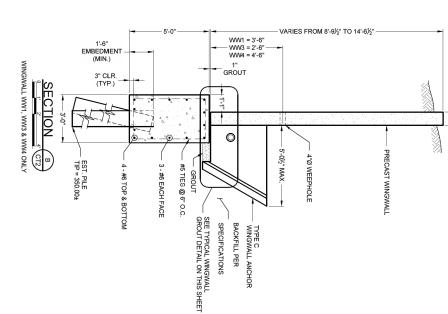

## TYPICAL WINGWALL GROUT DETAIL NOT TO SCALE NOTES MINIMAM 1" GROUT UNDER WINGWALL LEG & ANCHOR STEM. AREA BETWEEN WINGWALL FOOTING AND WINGWALL ANCHOR SHALL BE GROUTED SOLID BEFORE BACKFILL. FORM BACKSIBE OF FOOTING TO DIMENSIONS SHOWN ON FOUNDATION PLAN.

WINGWALL

BACKSIDE OF FOOTING

1'-6" EMBEDMENT (MIN.)

3" CLR. (TYP.)

4 - #6 TOP & BOTTOM

3 - #6 EACH FACE #5 TIES @ 6" O.C.

WINGWALL \_1" GROUT MIN.

WINGWALL ANCHOR

0



WINGWALL WW2 ONLY SECTION

-3'-0"

EST. PILE TIP = 350.00±


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	WEBSTER	COUNTY OF	
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T NO.	56	SHEET NO.	


	KY 132 C	WEBSTER	COUNTY OF
DETAILS	KY 132 CURVE CORRECTION	02-10019	ITEM NO.
	RECTION	56	SHEET NO.
	'		

KY 132 CURVE CORRECTION

DETAILS

Contract ID: 212152

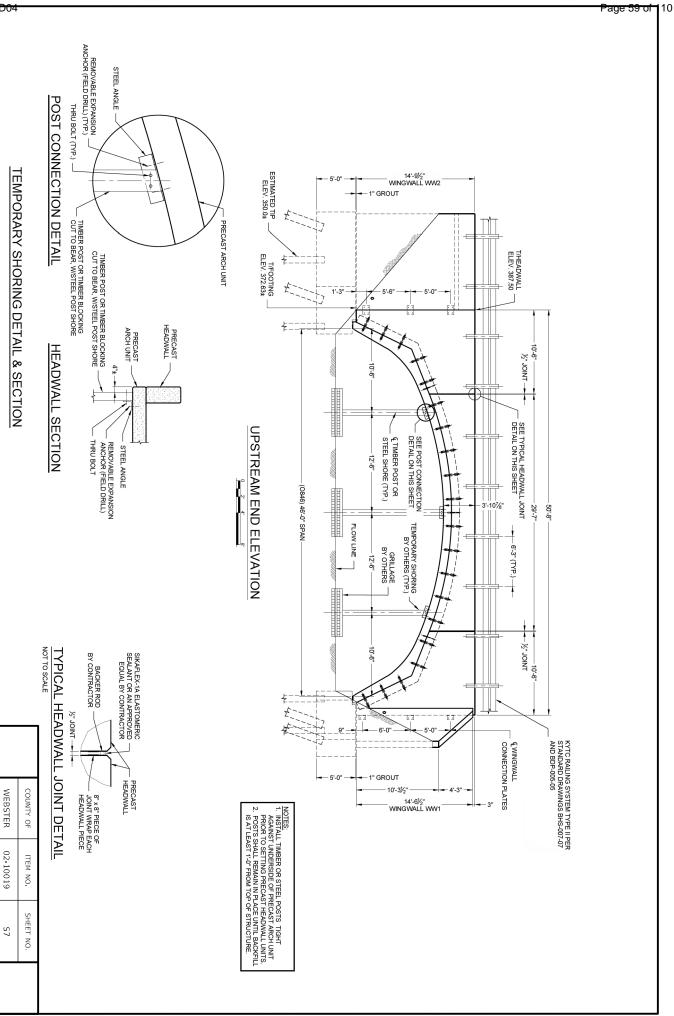

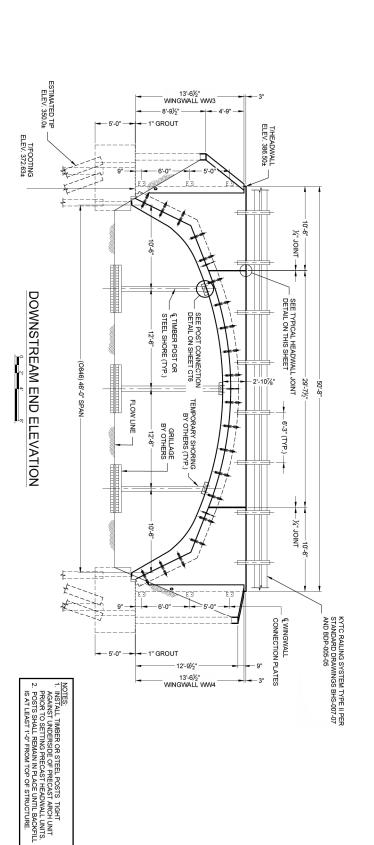



BACKER ROD BY CONTRACTOR


SIKAFLEX-1A ELASTOMERIC SEALANT OR AN APPROVED EQUAL BY CONTRACTOR


KY 132 C	WEBSTER	COUNTY OF
KY 132 CURVE CORRECTION	02-10019	ITEM NO.
RECTION	58	SHEET NO.


DETAILS

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# RAIL INSERTS SHALL BE PLACED IN THE FORMS AT THE PRE-CASTER'S PLANT.



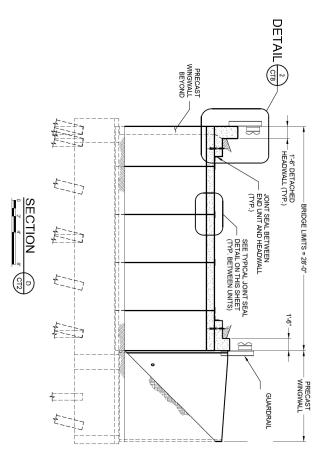

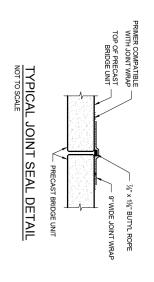
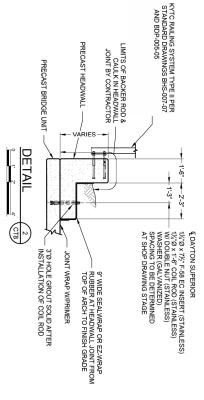
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KY 132 CURVE CORRECTION

DETAILS

WEBSTER COUNTY 117<del>GR21P030 - FD05 & FD04</del>

August 16, 2019

Mr. Rodney Little, PE
Mriging Kentucky Area Team Leader
QK4
1046 E. Chestnut Street
Louisville, KY 40204

RE: Geotechnical Exploration
Webster County, Kentucky
KY-132 over Nall Ditch
Bridge No. 117B00064N

Dear Mr. Little:

### 1 INTRODUCTION

The abbreviated geotechnical engineering report for this structure has been completed. The project is a part of the Bridging Kentucky Program. The project is to reconstruct the existing bridge of KY-132 over Nall Ditch in Webster County, Kentucky.

#### 2 GEOLOG

The structure is in the Bordley Geologic Quadrangle (GQ1275). The geologic mapping indicates the soils at this site consists of Quaternary-aged lacustrine and fluvial deposits. The deposits consist primarily of silts and clays. The deposits overlie the Sturgis Formation. This formation is comprised of siltstone, sandstone, shale and limestone. We encountered shale described as dark gray, silty to argillaceous, soft to moderately hard and thin to thick bedded.

## 3 DRILLING AND SAMPLING

One soil test boring was completed at this location. Soil samples were obtained to a depth of approximately 34.8 feet. Bedrock was encountered at a depth of 34.8 feet.

The boring "as drilled" latitudes and longitudes in decimal degrees were surveyed as a part of the Bridging Kentucky Program and are available in Table 1. Table 1 provides a summary of the locations, elevations, and depths of the borings drilled for the proposed bridge.

Table 1: Bridge over Nall Ditch – Summary of Borings

B-1	No.	Hole			
37.523413	Latitude				
B-1 37.523413 -87.762436	Longitude				
384.8	(ft.) MSL	Elevation	Juliace	Singara	
34.8	(ft.)	Depth		Rock	_
350.0	(ft.) MSL	Elevation		Rock/Refusal	Top of
34.8	(ft.)	Depth		Beg	
350.0	(ft.) MSL	Elevation		Begin Core	
44.6	(ft.)	Depth		Bottom o	
340.2	(ft.) M	Elevatio		m of Hole	

Webster County KY-132 over Nall Ditch Bridge No. 117B00064N

> August 16, 2019 Page **2** of **3**

## 4 LABORATORY TESTING

The laboratory testing indicates that the soil sampled at this location was primarily clay. Corresponding USCS classifications were CL and CL-ML.

# 5 ENGINEERING ANALYSIS AND FOUNDATION RECOMMENDATIONS

- 5.1 <u>End Bents</u>— Use end bearing steel H-Piles with reinforced pile points driven to bedrock for the end bents. The approximate point of pile elevation is near 314 feet. We recommend a resistance factor (\( \phi \)) of 0.5 to determine the maximum nominal resistance of the piles.
- 5.2 <u>Settlement at Abutments</u> A settlement analysis was not required due to the relatively small amount of new fill that will be added.
- 5.3 Wave Equation Analysis—Drivability analyses were performed for the piles at this location assuming 16-inch closed end steel pipe piles with a wall thickness of 0.5 inches and a steel yield stress of 45 kis. These analyses indicate that a single acting diesel hammer with rated energies of 47 foot-kips to 83 foot-kips is recommended to adequately drive the piles without encountering excessive blow counts or overstressing the piles. The use of hammers other than single acting diesel may require different energy ranges.

Drivability analyses were performed assuming continuous driving. If interruptions in driving individual piles should occur, difficulties in continuing the installation process will likely occur due to pile "set" characteristics.

5.4 <u>Embankment Stability</u> Due to the minimal amount of new fill, no embankment stability analyses were deemed necessary.

#### 6 PLAN NOTES

Add the following plan notes as necessary at the appropriate locations in the plans.

- 6.1 Foundation excavations should be properly braced/shored to provide adequate safety to people working in or around the excavations. Bracing should be performed in accordance with applicable federal, state and local guidelines.
- 6.2 Temporary shoring, sheeting, cofferdams, and/or dewatering methods may be required to facilitate foundation construction. It should be anticipated that groundwater will be encountered at foundation locations within the floodplain.
- 6.3 A diesel pile driving hammer with a rated energy between 47 foot-kips and 83 foot-kips will be required to drive 12x53 steel H-piles to practical refusal without encountering excessive blow counts or damaging the piles. The Contractor shall submit the proposed pile driving system to the Engineer for approval prior to the installation of the first pile. Approval of the pile driving system by the Engineer will be subject to satisfactory field performance of the pile driving procedures.

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## KY 132 CURVE CORRECTION

GEOTECH

WEBSTER COUNTY

117<del>GR21P030 - FD05 & FD0</del>4

Bridge No. 117B00064N KY-132 over Nall Ditch

Webster County

August 16, 2019 Page **3** of **3** 

- 6.4 becomes ½ inch or less for ten consecutive blows, practical refusal is obtained after the pile is struck an additional ten blows with total penetration of ½ inch or less. Advance the For this project, minimum blow requirements may be reached after total penetration damaged during driving. test pile(s). Immediately cease driving operations if the pile visibility yields or becomes production piling to the driving resistances specified above and to depths determined by
- 6.5 If hard driving is encountered because of dense strata or an obstruction, such as a boulder blows than the average driving resistance specified for practical refusal is required to further advance the pile. Drive additional production and test piles if directed by the before the pile is advanced to the depth anticipated, the Engineer will determine if more
- 6.6 The installation of the pile foundations should conform to current AASHTO LRFD Bridge Design Specifications, and Section 604 of the current edition of the Kentucky Department of Highways Standard Specifications for Road and Bridge Construction.
- 6.7 The Kentucky Transportation Cabinet recommends that protective pile points be used on Kentucky Standard Specifications for Road and Bridge Construction, current edition. recommended. Installation of pile points should be in accordance with Section 604 of the points capable of penetrating boulders and hard layers which may be encountered is end bearing piles to allow for embedment into the top of bedrock. Use of reinforced pile

any questions arise pertaining to this project. The designer should feel free to contact AEI at 270-651-7220 for further recommendations or if

AMERICAN ENGINEERS, INC.

Geotechnical Engineer Jackson Daugherty, PE, PMP Complet

Dennis Mitchell, PE, PMP
Director of Federal Geotechnical Services

Attachments:

- **Boring Layout**
- Typed Boring Logs
- Laboratory Data



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KY 132 CURVE CORRECTION

GEOTECH

WEBSTER COUNTY

117<del>GR21P030 - FD05 & FD0</del>4

Drilling Firm: American Engineers (Glasgow)
For: Division of Structural Design
Geotechnical Branch

DRILLER'S SUBSURFACE LOG

Printed: 8/16/19 Page 1 of 1

Total Depth 44.6' Project ID: <u>117B00064N</u> Item Number: <u>2-10019</u> Surface Elevation 384.8' Hole Number B-1 Driller Thompson, Adam Webster - KY-132 Nall Ditch End Date 11/20/2018 Latitude(83) 37.523413 Project Type: Structure County Bridge
Project Manager: Dennis Mitchell Rig\_Number CME 45 Hole Type <u>core and sample</u>

Location + 'Lt.	Tt.			Longitu	Longitude(83)87.762436	62436			
Lithology	ΙV		Overburden	Sample No.	Depth (ft)	Rec.	SPT	Sample Type	
Elevation	Depth	Description	Rock Core	Std/Ky RQD	(ft)	(ft)	Rec (%)	(JS)	Remarks
384.6	0.2		Topsoil.						
				_	2.0-3.5	1.0	0-1-2	SPT	
1				2	4.0-5.5	0.3	0-0-1	SPT	
10		Brown to gra	Brown to gray, wet, silty lean clay with coarse sand (soft to medium stiff).	ω	9.0-10.5	1.5	3-4-4	SPT	
15				4	14.0-15.5	1.5	1-1-3	SPT	
365.8	19.0								
20				51	19.0-20.5	1.5	1-3-4	SPT	
		1							
25		brown to gra	brown to gray, very moist, lean day (medium suir).	6	24.0-25.5	1.5	3-4-5	SPT	
n n n	90								
30				7	29.0-30.3	1.3	8-26-50/0.30'	SPT	
		Dark gra	Dark gray, gravelly lean clay (medium stiff).						
35 350.0	34.8		(Begin Core)	00	34.0-34.8	0.8	30-50/0.30'	SPT	
		Dark gray she		93 / 0	4.6	4.6	100		39,4
1 1 40		to mode	to moderately hard, thin to thick bedded).	90 / 00	5.2	5.2	100		!
45 340.2	44.6								44.6
0			(Bottom of Hole 44.6')						

Project ID: 117B00064N Location: Webster Item No: 2-10019

Depth Limit Limit
2
4
9
23
19
23
19
35
13
24 22 PI 0.011 0.008 D50 86 8 A-4 (2) A-6 (17) AASHTO CLASSIF Content (%) CL

50=0.010	7= 57.6 pcf	Dep+1 18'-35	Eso = 0.020 tom	Su = 500 psf	7= 120 pef	0-18 0-18	PROJECT NO. 117800664N STRUCTURE OVER Nall Ditch	65 Aberdeen Drive Glasgow, KY 42141 (270) 651-7220 WWW.sel.cc
		Elevation	~ Peck et al. 1974			Elevation 385' - 366'	COUNTY Webster ROAD KY-132	AMERICAN ENGINEERS, INC.
		366' - 350'					CHK'D BY DAN DATE 8/14	S, INC. PAGE NOOF

Total Jars: 0
Total SPT: 0
Total ST: 0
Total Cut Bags: 0
Total Fill Bags: 0

COUNTY OF WEBSTER 02-10019 ITEM NO. SHEET NO.

S12

KY 132 CURVE CORRECTION

GEOTECH

WEBSTER COUNTY

117<del>GR21P030 - FD05 & FD04</del>

Contract	ID:	212	152
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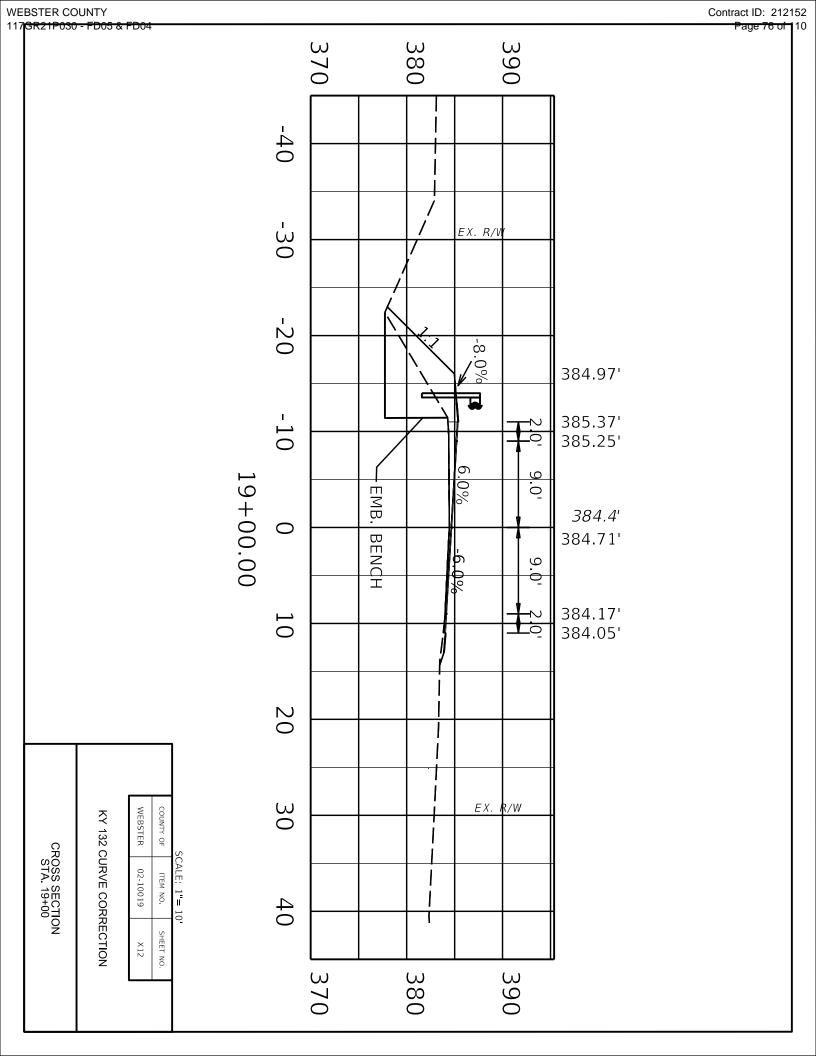
					2675 0.3 0.2	2650 0.13 3.1	2600 0.25 3.85	2000 0.22 3.12	0 22 3	0.5	2450 0.65 7.7	2400 0.98 9.4	2350 0.4 10.75	2300 0.56 8.56	2250 0.58 10.65	2200 0.31 14.4	1.74		0	2050 0 24.54	2000 0 34.75	1950 0 33.4	1900 0 24.72	1850 0 42.7			Þ	1700 0 31.67	1650 0.82 19.33	1600 1.17 13.56	1550 0.48 11.67	1500 0.1 7.3	1450 2.09 3.4	-
					0.00	4.70	4.78	2,50	3 50	3 90	4.35	4.50	4.63	3.00	4.93	11.12	15.34		3.82	37.57	34.51	34.60	36.02	43.74	61.62	0.00	3	44.93	29.64	12.35	14.62	15.38	6.05	
					0	0.35	2.13	3,02	3 00	3 58	4.61	6.07	7.43	5.51	5.89	5.01	4.11		5.36	7.86	9.72	5.8	7.1	13.58	13.01	3.23	0 20	10.31	8.57	5.25	5.16	3.22	0.58	
					2.29	1.24	0.83	1.04	1 01	2 46	2.62	3.01	1.84	2.55	2,99	2.3	1.74		0	0	0	0	0	0	c		0	0.27	0.1	2.65	1.8	0.79	0.88	
Project Total Tons	KY 132 Total Tons KY 857 Total Tons	Project Total CY	KY 857 Total CY	KV 432 Total CV	25	R 18	50	50	<u>50</u>	50	50	:  8	g  8	E0  :	50	50	50	50	50	50	18	E0  :	50	50	50	<u>50</u>	50	50	100	E0   5	50	50	50	25
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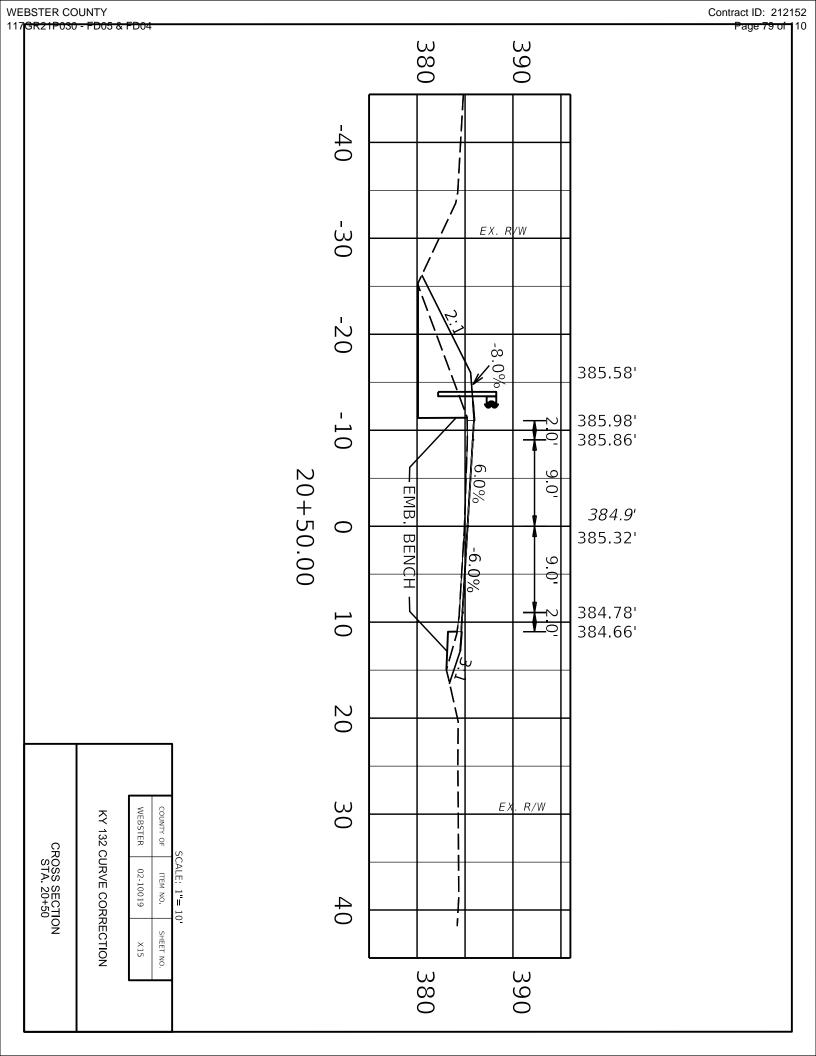
Station	Area Sq Ft					DISTANCE		Volume Cy			
	Com (Cut)	Emb (Fill)	Emb Bench	Level Wedging	Milling		Com (Cut)	Emb (Fill)	Emb Bench	Com (Cut) Emb (Fill) Emb Bench Level Wedging	Milling
4915		0	0	0	2.28						
						45	0	4	0	23	4
4950	0	4.74	0	14.05	0						
						39	0	15	0	102	0
4989	0	16.16		56.53	0						
						KY 857 Total	0	19	0	125	4


WEBSTER	COUNTY OF
02-10019	ITEM NO.
X1	SHEET NO.


KY 132 CURVE CORRECTION


CROSS SECTION QUANTITIES







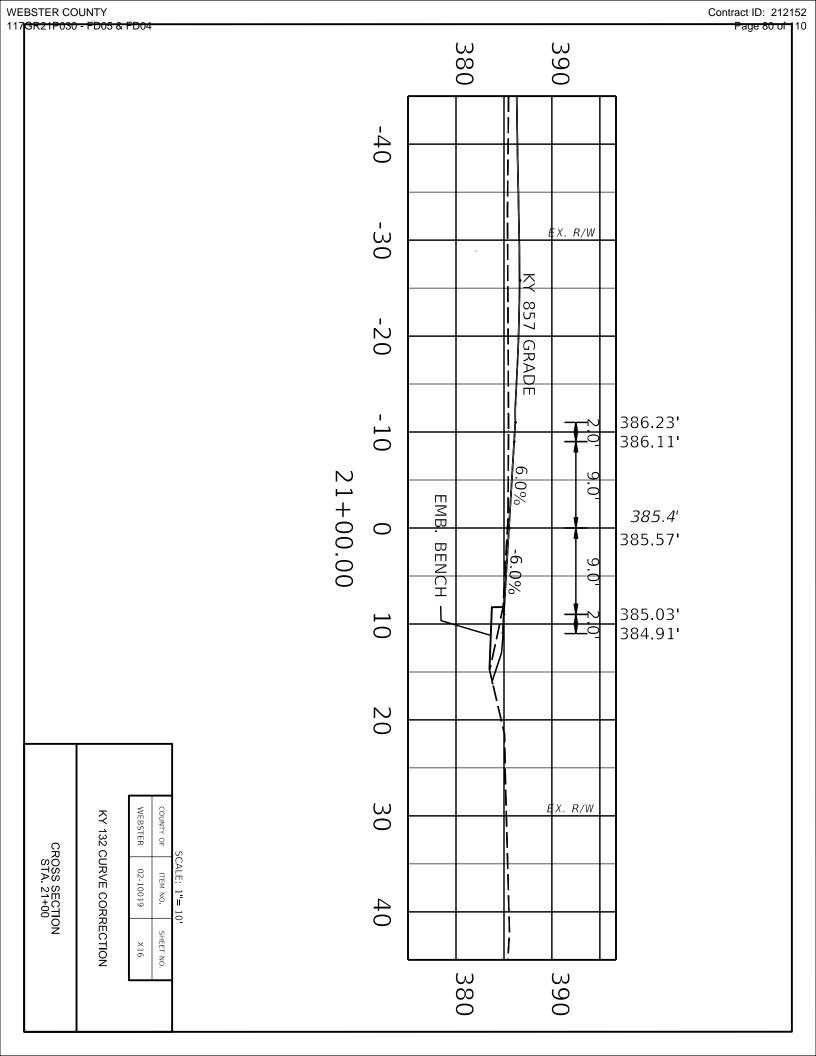

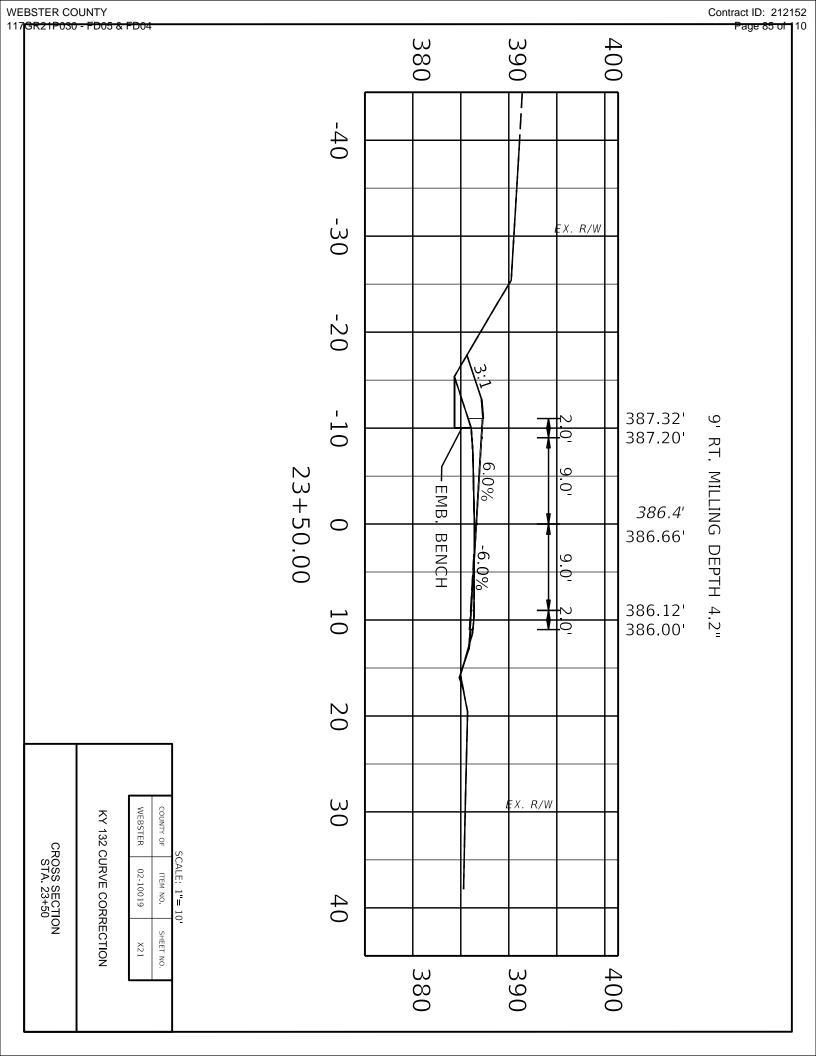

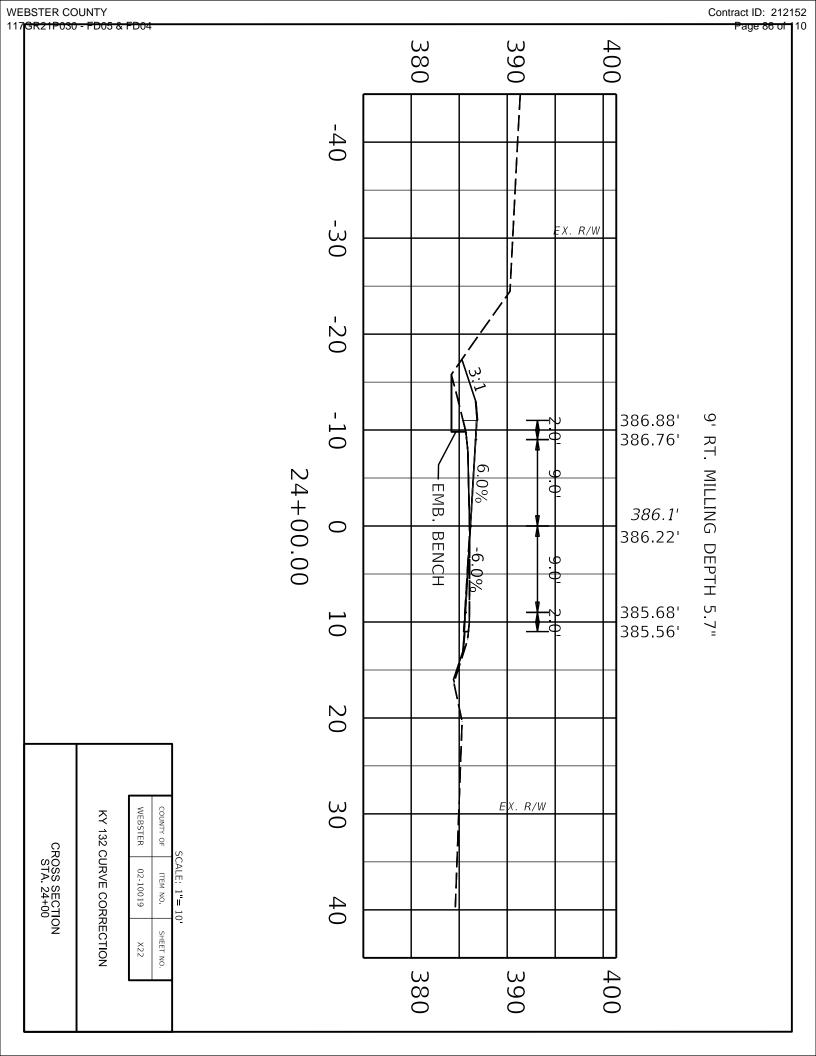

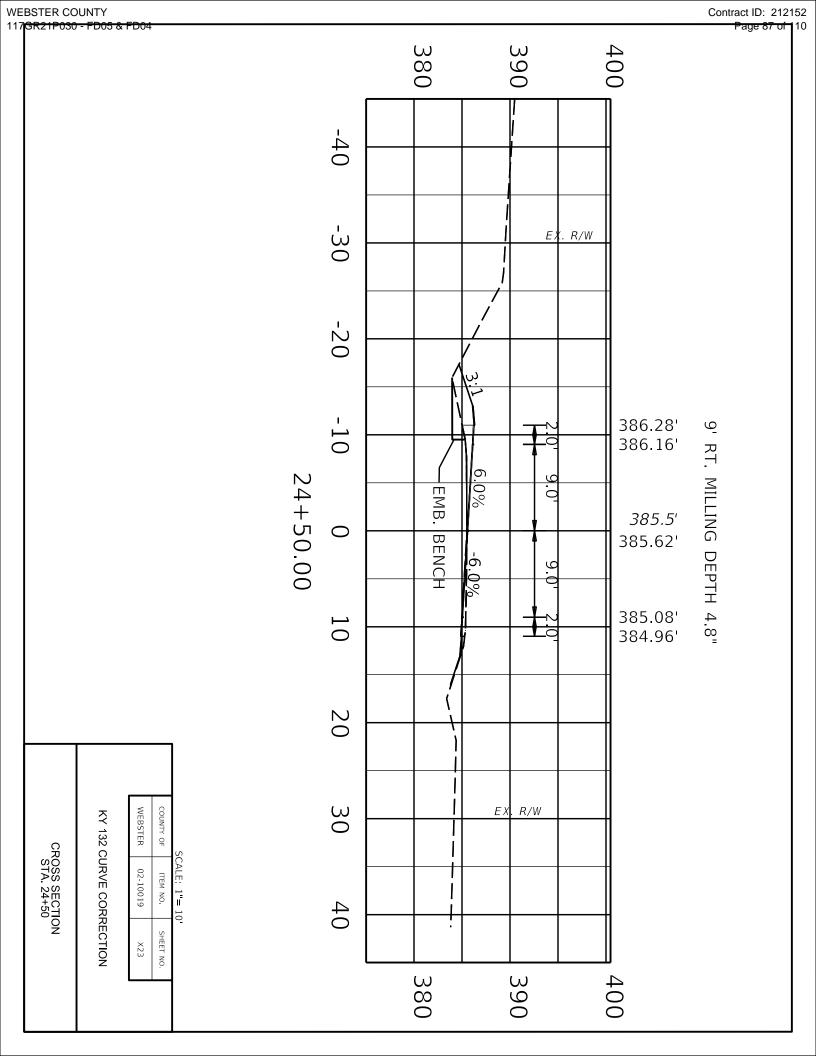

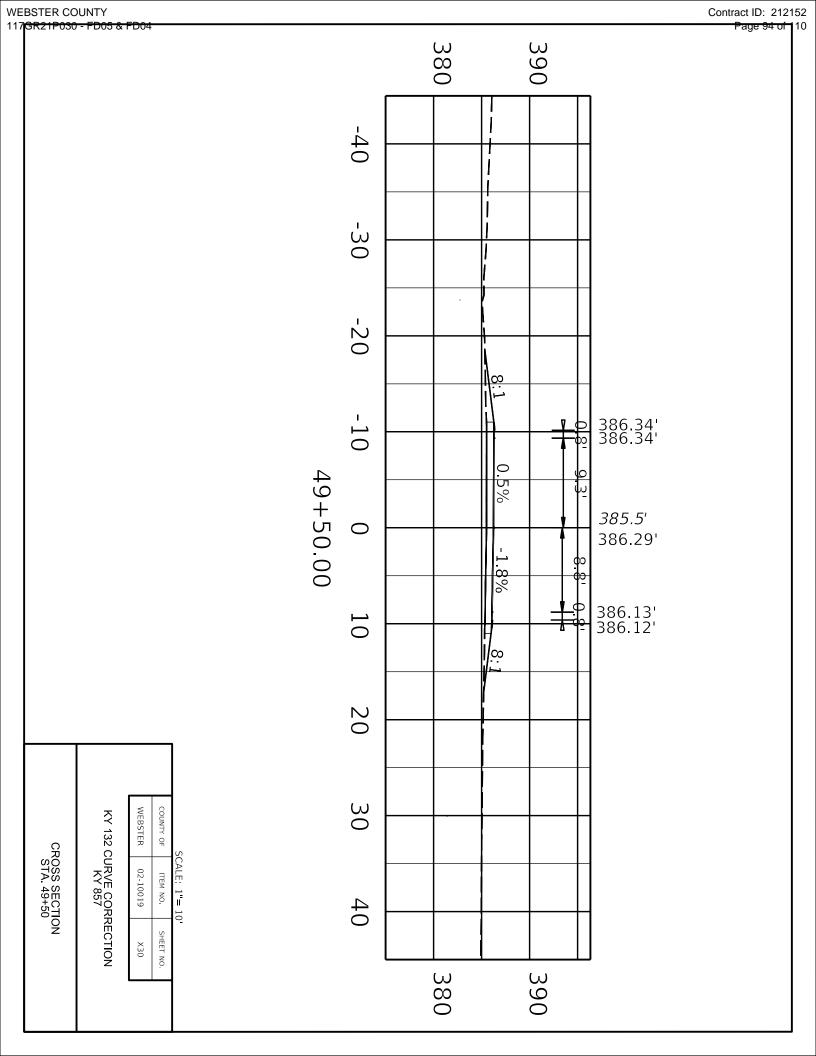

WEBSTER COUNTY 117GR21P030 - FD05 & FD04

Completed Form Submitted to Section Engineer

# **GUARDRAIL DELIVERY VERIFICATION SHEET**


Contract ID: 212152 Page 96 of 110

Contract Id:		Con	tractor:
Section Engineer:		District & County:	
<u>DESCRIPTION</u>	<u>UNIT</u>	QTY LEAVING PROJECT	QTY RECEIVED@BB YARD
GUARDRAIL (Includes End treatments & crash cushions) STEEL POSTS	LF EACH		
STEEL BLOCKS	EACH		
WOOD OFFSET BLOCKS	EACH		
BACK UP PLATES	EACH		
CRASH CUSHION	EACH		
NUTS, BOLTS, WASHERS	BAG/BCKT		
DAMAGED RAIL TO MAINT. FACILIT	TY LF		
DAMAGED POSTS TO MAINT. FACIL	LITY EACH		
*Required Signatures before	Leaving Proje	<u>ct Site</u>	
Printed Section Engineer's Re	epresentative_		& Date
Signature Section Engineer's	Representative	2	_& Date
Printed Contractor's Represe	ntative		_& Date
Signature Contractor's Repre	sentative		_& Date
			on truck must be counted & the
guantity received column co			
Printed Bailey Bridge Yard Re			
Signature Bailey Bridge Yard	Representative		& Date
Printed Contractor's Represe	ntative		_& Date
Signature Contractor's Repre	sentative		_& Date
	ent will not be	made for guardrail removal	antities shown in the Bailey Bridge until the guardrail verification sheets e Yard Representative.

Date: \_\_\_\_\_

By: \_\_\_\_\_

# BRIDGE DETAIL FOR PAVING PROJECT

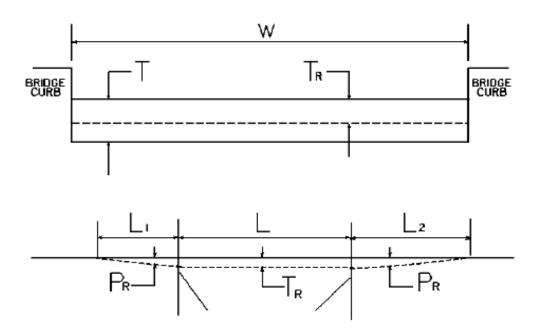

W = bridge width curb to curb

T =thickness of existing asphalt overlay

L = length of bridge

 $L_1 \& L_2 = \text{length of approach pavement to be removed}$ 

 $T_R$  = thickness to be removed and replaced on bridge  $P_R$  = thickness to be removed and replaced on pavement Note:  $L_1$  &  $L_2$  lengths shall be determined by using a transition rate of 100 ft/in of thickness

Route	Bridge	MP	W (ft)	T (in)	$L_1$ (ft)	$L_2$ (ft)	$T_R$	L (ft)	$P_{R}$ (in)
	No.						(in)		
KY 132	B00126N	11.224	24.000	1.000	100.000	100.000	1.000	35.000	1.000
KY 132	B00061N	12.630	24.000	0.000	100.000	100.000	0.000	115.000	1.000
KY 132	B00060N	14.169	24.000	1.000	100.000	100.000	1.000	20.000	1.000

01/01/2009

# **PART II**

# SPECIFICATIONS AND STANDARD DRAWINGS

# **SPECIFICATIONS REFERENCE**

Any reference in the plans or proposal to previous editions of the *Standard Specifications* for Road and Bridge Construction and Standard Drawings are superseded by Standard Specifications for Road and Bridge Construction, Edition of 2019 and Standard Drawings, Edition of 2020.

# SUPPLEMENTAL SPECIFICATIONS

The contractor shall use the Supplemental Specifications that are effective at the time of letting. The Supplemental Specifications can be found at the following link:

http://transportation.ky.gov/Construction/Pages/Kentucky-Standard-Specifications.aspx

# 2020 KENTUCKY STANDARD DRAWINGS

CURVE WIDENING AND SUPERELEVATION TRANSITIONS	RGS-001-07
SUPERELEVATION FOR MULTILANE PAVEMENT	RGS-002-06
MISCELLANEOUS STANDARDS	RGX-001-06
APPROACHES, ENTRANCES, AND MAIL BOX TURNOUT	RPM-110-07
LANE CLOSURE TWO-LANE HIGHWAY	TTC-100-04
SHOULDER CLOSURE	TTC-135-02
PAVEMENT CONDITION WARNING SIGNS	TTD-125-02
MOBILE OPERATION FOR PAINT STRIPING CASE I	TTS-100-02
MOBILE OPERATION FOR PAINT STRIPING CASE II	
SHOULDER & EDGELINE RUMBLE STRIPS PLACEMENT DETAILS	TPR-115
EDGELINE RUMBLE STRIP DETAILS TWO LANE ROADWAYS	TPR-120
GUARDRAIL END TREATMENT TYPE 1	RBR-020-07
STEEL BEAM GUARDRAIL ("W"-BEAM)	RBR-001-13
GUARDRAIL COMPONENTS	RBR-005-11
DELINEATORS FOR GUARDRAIL	
INSTALLATION OF GUARDRAIL END TREATMENT TYPE 1	RBI-004-06
TYPICAL GUARDRAIL INSTALLATIONS	
TYPICAL GUARDRAIL INSTALLATIONS	RBI-002-07
SILT TRAP - TYPE A	RDX-220-05
SILT TRAP - TYPE B	
EROSION CONTROL BLANKET SLOPE INSTALLATION	RDI-040-01
EROSION CONTROL BLANKET CHANNEL INSTALLATION	RDI-041-01
TEMPORARY SILT FENCE	RDX-210-03

# **PART III**

# EMPLOYMENT, WAGE AND RECORD REQUIREMENTS

#### Contract ID: 212152 Page 103 of 110

# TRANSPORTATION CABINET DEPARTMENT OF HIGHWAYS

# LABOR AND WAGE REQUIREMENTS APPLICABLE TO OTHER THAN FEDERAL-AID SYSTEM PROJECTS

- I. Application
- II. Nondiscrimination of Employees (KRS 344)

#### I. APPLICATION

- 1. These contract provisions shall apply to all work performed on the contract by the contractor with his own organization and with the assistance of workmen under his immediate superintendence and to all work performed on the contract by piecework, station work or by subcontract. The contractor's organization shall be construed to include only workmen employed and paid directly by the contractor and equipment owned or rented by him, with or without operators.
- 2. The contractor shall insert in each of his subcontracts all of the stipulations contained in these Required Provisions and such other stipulations as may be required.
- 3. A breach of any of the stipulations contained in these Required Provisions may be grounds for termination of the contract.

#### II. NONDISCRIMINATION OF EMPLOYEES

AN ACT OF THE KENTUCKY GENERAL ASSEMBLY TO PREVENT DISCRIMINATION IN EMPLOYMENT KRS CHAPTER 344 EFFECTIVE JUNE 16, 1972

The contract on this project, in accordance with KRS Chapter 344, provides that during the performance of this contract, the contractor agrees as follows:

- 1. The contractor shall not fail or refuse to hire, or shall not discharge any individual, or otherwise discriminate against an individual with respect to his compensation, terms, conditions, or privileges of employment, because of such individual's race, color, religion, national origin, sex, disability or age (forty and above); or limit, segregate, or classify his employees in any way which would deprive or tend to deprive an individual of employment opportunities or otherwise adversely affect his status as an employee, because of such individual's race, color, religion, national origin, sex, disability or age forty (40) and over. The contractor agrees to post in conspicuous places, available to employees and applicants for employment, notices to be provided setting forth the provisions of this nondiscrimination clause.
- 2. The contractor shall not print or publish or cause to be printed or published a notice or advertisement relating to employment by such an employer or membership in or any classification or referral for employment by the employment agency, indicating any preference, limitation, specification, or discrimination, based on race, color, religion, national origin, sex, or age forty (40) and over, or because the person is a qualified individual with a disability, except that such a notice or advertisement may indicate a preference, limitation, or specification based on religion, national origin, sex, or age forty (40) and over, or because the person is a qualified individual with a disability, when religion, national origin, sex, or age forty (40) and over, or because the person is a qualified individual with a disability, is a bona fide occupational qualification for employment.

- 3. If the contractor is in control of apprenticeship or other training or retraining, including on-the-job training programs, he shall not discriminate against an individual because of his race, color, religion, national origin, sex, disability or age forty (40) and over, in admission to, or employment in any program established to provide apprenticeship or other training.
- 4. The contractor will send to each labor union or representative of workers with which he has a collective bargaining agreement or other contract or understanding, a notice to be provided advising the said labor union or workers' representative of the contractor's commitments under this section, and shall post copies of the notice in conspicuous places available to employees and applicants for employment. The contractor will take such action with respect to any subcontract or purchase order as the administrating agency may direct as a means of enforcing such provisions, including sanctions for non-compliance.

Revised: January 25, 2017

#### Contract ID: 212152 Page 104 of 110

### **EXECUTIVE BRANCH CODE OF ETHICS**

In the 1992 regular legislative session, the General Assembly passed and Governor Brereton Jones signed Senate Bill 63 (codified as KRS 11A), the Executive Branch Code of Ethics, which states, in part:

## KRS 11A.040 (7) provides:

No present or former public servant shall, within six (6) months following termination of his office or employment, accept employment, compensation, or other economic benefit from any person or business that contracts or does business with, or is regulated by, the state in matters in which he was directly involved during the last thirty-six (36) months of his tenure. This provision shall not prohibit an individual from returning to the same business, firm, occupation, or profession in which he was involved prior to taking office or beginning his term of employment, or for which he received, prior to his state employment, a professional degree or license, provided that, for a period of six (6) months, he personally refrains from working on any matter in which he was directly involved during the last thirty-six (36) months of his tenure in state government. This subsection shall not prohibit the performance of ministerial functions, including but not limited to filing tax returns, filing applications for permits or licenses, or filing incorporation papers, nor shall it prohibit the former officer or public servant from receiving public funds disbursed through entitlement programs.

### KRS 11A.040 (9) states:

A former public servant shall not represent a person or business before a state agency in a matter in which the former public servant was directly involved during the last thirty-six (36) months of his tenure, for a period of one (1) year after the latter of:

- a) The date of leaving office or termination of employment; or
- b) The date the term of office expires to which the public servant was elected.

This law is intended to promote public confidence in the integrity of state government and to declare as public policy the idea that state employees should view their work as a public trust and not as a way to obtain private benefits.

If you have worked for the executive branch of state government within the past six months, you may be subject to the law's prohibitions. The law's applicability may be different if you hold elected office or are contemplating representation of another before a state agency.

Also, if you are affiliated with a firm which does business with the state and which employs former state executive-branch employees, you should be aware that the law may apply to them.

In case of doubt, the law permits you to request an advisory opinion from the Executive Branch Ethics Commission, 3 Fountain Place, Frankfort, Kentucky 40601; telephone (502) 564-7954.

Revised: January 27, 2017

## **Kentucky Equal Employment Opportunity Act of 1978**

The requirements of the Kentucky Equal Employment Opportunity Act of 1978 (KRS 45.560-45.640) shall apply to this Contract. The apparent low Bidder will be required to submit EEO forms to the Division of Construction Procurement, which will then forward to the Finance and Administration Cabinet for review and approval. No award will become effective until all forms are submitted and EEO/CC has certified compliance. The required EEO forms are as follows:

- EEO-1: Employer Information Report
- Affidavit of Intent to Comply
- Employee Data Sheet
- Subcontractor Report

These forms are available on the Finance and Administration's web page under *Vendor Information*, *Standard Attachments and General Terms* at the following address: <a href="https://www.eProcurement.ky.gov">https://www.eProcurement.ky.gov</a>.

Bidders currently certified as being in compliance by the Finance and Administration Cabinet may submit a copy of their approval letter in lieu of the referenced EEO forms.

For questions or assistance please contact the Finance and Administration Cabinet by email at **finance.contractcompliance@ky.gov** or by phone at 502-564-2874.

Contract ID: 212152 Page 106 of 110

# PLOYEE RIGH DER THE FAIR LABOR STANDARDS ACT

THE UNITED STATES DEPARTMENT OF LABOR WAGE AND HOUR DIVISION

# FEDERAL MINIMUM WAGE

**BEGINNING JULY 24, 2009** 

### **OVERTIME PAY**

At least 1½ times your regular rate of pay for all hours worked over 40 in a workweek.

#### **CHILD LABOR**

An employee must be at least 16 years old to work in most non-farm jobs and at least 18 to work in non-farm jobs declared hazardous by the Secretary of Labor.

Youths 14 and 15 years old may work outside school hours in various non-manufacturing, non-mining, non-hazardous jobs under the following conditions:

#### No more than

- 3 hours on a school day or 18 hours in a school week;
- 8 hours on a non-school day or 40 hours in a non-school week.

Also, work may not begin before 7 a.m. or end after 7 p.m., except from June 1 through Labor Day, when evening hours are extended to 9 p.m. Different rules apply in agricultural employment.

#### **TIP CREDIT**

Employers of "tipped employees" must pay a cash wage of at least \$2.13 per hour if they claim a tip credit against their minimum wage obligation. If an employee's tips combined with the employer's cash wage of at least \$2.13 per hour do not equal the minimum hourly wage, the employer must make up the difference. Certain other conditions must also be met.

### **ENFORCEMENT**

The Department of Labor may recover back wages either administratively or through court action, for the employees that have been underpaid in violation of the law. Violations may result in civil or criminal action.

Employers may be assessed civil money penalties of up to \$1,100 for each willful or repeated violation of the minimum wage or overtime pay provisions of the law and up to \$11,000 for each employee who is the subject of a violation of the Act's child labor provisions. In addition, a civil money penalty of up to \$50,000 may be assessed for each child labor violation that causes the death or serious injury of any minor employee, and such assessments may be doubled, up to \$100,000, when the violations are determined to be willful or repeated. The law also prohibits discriminating against or discharging workers who file a complaint or participate in any proceeding under the Act.

## **ADDITIONAL INFORMATION**

- · Certain occupations and establishments are exempt from the minimum wage and/or overtime pay provisions.
- · Special provisions apply to workers in American Samoa and the Commonwealth of the Northern Mariana Islands.
- Some state laws provide greater employee protections; employers must comply with both.
- The law requires employers to display this poster where employees can readily see it.
- Employees under 20 years of age may be paid \$4.25 per hour during their first 90 consecutive calendar days of employment with an employer.
- · Certain full-time students, student learners, apprentices, and workers with disabilities may be paid less than the minimum wage under special certificates issued by the Department of Labor.



# **PART IV**

# **INSURANCE**

Refer to *Kentucky Standard Specifications for Road and Bridge Construction*,

current edition

# **PART V**

# **BID ITEMS**

Contract ID: 212152 Page 109 of 110

Page 1 of 2

212152

## **PROPOSAL BID ITEMS**

Report Date 3/24/21

Section: 0001 - PAVING

LINE	BID CODE	ALT	DESCRIPTION	QUANTITY	UNIT	<b>UNIT PRIC</b>	FP	AMOUNT
0010	00001		DGA BASE	1,300.00	TON		\$	
0020	00003		CRUSHED STONE BASE	375.00	TON		\$	
0030	00103		ASPHALT SEAL COAT	23.00	TON		\$	
0040	00190		LEVELING & WEDGING PG64-22	2,061.00	TON		\$	
0050	00212		<b>CL2 ASPH BASE 1.00D PG64-22</b>	844.00	TON		\$	
0060	00291		EMULSIFIED ASPHALT RS-2	3.00	TON		\$	
0070	00301		CL2 ASPH SURF 0.38D PG64-22	5,567.00	TON		\$	
0800	02562		TEMPORARY SIGNS	330.00	SQFT		\$	
0090	02650		MAINTAIN & CONTROL TRAFFIC (FD05)	1.00	LS		\$	
0100	02676		MOBILIZATION FOR MILL & TEXT (FD04)	1.00	LS		\$	
0110	02676		MOBILIZATION FOR MILL & TEXT (FD05)	1.00	LS		\$	
0120	02677		ASPHALT PAVE MILLING & TEXTURING	304.00	TON		\$	
0130	02697		EDGELINE RUMBLE STRIPS	68,600.00	LF		\$	
0140	06510		PAVE STRIPING-TEMP PAINT-4 IN	35,000.00	LF		\$	
0150	06515		PAVE STRIPING-PERM PAINT-6 IN	60,000.00	LF		\$	
0160	10020NS		FUEL ADJUSTMENT	9,456.00	DOLL	\$1.00	\$	\$9,456.00
0170	10030NS		ASPHALT ADJUSTMENT	23,751.00	DOLL	\$1.00	\$	\$23,751.00
0180	21289ED		LONGITUDINAL EDGE KEY	1,204.00	LF		\$	
0190	24970EC		ASPHALT MATERIAL FOR TACK NON- TRACKING	36.00	TON		\$	

Section: 0002 - ROADWAY

LINE	BID CODE	ALT	DESCRIPTION	QUANTITY	UNIT	<b>UNIT PRIC</b>	FP	AMOUNT
0200	01987		DELINEATOR FOR GUARDRAIL BI DIRECTIONAL WHITE	12.00	EACH		\$	
0210	02014		BARRICADE-TYPE III	4.00	EACH		\$	
0220	02230		EMBANKMENT IN PLACE	2,258.00	CUYD		\$	
0230	02351		GUARDRAIL-STEEL W BEAM-S FACE	230.00	LF		\$	
0240	02355		GUARDRAIL-STEEL W BEAM-S FACE A	100.00	LF		\$	
0250	02367		GUARDRAIL END TREATMENT TYPE 1	4.00	EACH		\$	
0260	02562		TEMPORARY SIGNS	500.00	SQFT		\$	
0270	02585		EDGE KEY	59.00	LF		\$	
0280	02650		MAINTAIN & CONTROL TRAFFIC (FD04)	1.00	LS		\$	
0290	02726		STAKING	1.00	LS		\$	
0300	08801		GUARDRAIL-STEEL W BEAM-S FACE BR	92.00	LF		\$	
0310	20205EC		PAVE MARK STOP BAR-24 IN PAINT	20.00	LF		\$	

Section: 0003 - DRAINAGE

LINE	BID CODE	ALT DESCRIPTION	QUANTITY	UNIT	<b>UNIT PRIC</b>	FP	AMOUNT
0320	02701	TEMP SILT FENCE	625.00	LF	:	\$	

Contract ID: 212152 Page 110 of 110

#### **PROPOSAL BID ITEMS** 212152

Page 2 of 2

## Report Date 3/24/21

LINE	BID CODE	ALT	DESCRIPTION	QUANTITY	UNIT	<b>UNIT PRIC</b>	FP	AMOUNT
0330	02703		SILT TRAP TYPE A	1.00	EACH		\$	
0340	02704		SILT TRAP TYPE B	1.00	EACH		\$	
0350	02706		CLEAN SILT TRAP TYPE A	3.00	EACH		\$	
0360	02707		CLEAN SILT TRAP TYPE B	3.00	EACH		\$	
0370	05950		EROSION CONTROL BLANKET	270.00	SQYD		\$	
0380	05952		TEMP MULCH	2,300.00	SQYD		\$	
0390	05985		SEEDING AND PROTECTION	1,325.0	SQYD		\$	

Section: 0004 - BRIDGE

LINE	BID CODE	ALT	DESCRIPTION	QUANTITY	UNIT	<b>UNIT PRIC</b>	FP	AMOUNT
0400	02731		REMOVE STRUCTURE	1.00	LS		\$	
0410	23820EC		PRECAST ARCH	1.00	LS		\$	

Section: 0005 - UTILITY

LINE	BID CODE	ALT	DESCRIPTION	QUANTITY	UNIT	<b>UNIT PRIC</b>	FP	AMOUNT
			RELOCATE					
0420	24605ED		ONE UTILITY POLE	1.00	EACH		\$	

Section: 0006 - DEMOBILIZATION

LINE	BID CODE	ALT	DESCRIPTION	QUANTITY	UNIT	UNIT PRIC	FΡ	AMOUNT
0430	02569		DEMOBILIZATION	1.00	LS		\$	